

PHILIPPINE BIDDING DOCUMENTS



**Name of Project/Location : Proposed Expansion
with Improvement Works at Pasig City
Children's Hospital, Industria corner
Alcalde Jose Sts., Brgy. Kapasigan, Pasig
City**

Approved Budget for the Contract: P 319,778,374.90

Government of the Republic of the Philippines

**Sixth Edition
July 2020**

Preface

These Philippine Bidding Documents (PBDs) for the procurement of Infrastructure Projects (hereinafter referred to also as the “Works”) through Competitive Bidding have been prepared by the Government of the Philippines for use by all branches, agencies, departments, bureaus, offices, or instrumentalities of the government, including government-owned and/or -controlled corporations, government financial institutions, state universities and colleges, local government units, and autonomous regional government. The procedures and practices presented in this document have been developed through broad experience, and are for mandatory use in projects that are financed in whole or in part by the Government of the Philippines or any foreign government/foreign or international financing institution in accordance with the provisions of the 2016 revised Implementing Rules and Regulations (IRR) of Republic Act (RA) No. 9184.

The PBDs are intended as a model for admeasurements (unit prices or unit rates in a bill of quantities) types of contract, which are the most common in Works contracting.

The Bidding Documents shall clearly and adequately define, among others: (i) the objectives, scope, and expected outputs and/or results of the proposed contract; (ii) the eligibility requirements of Bidders; (iii) the expected contract duration; and (iv) the obligations, duties, and/or functions of the winning Bidder.

Care should be taken to check the relevance of the provisions of the PBDs against the requirements of the specific Works to be procured. If duplication of a subject is inevitable in other sections of the document prepared by the Procuring Entity, care must be exercised to avoid contradictions between clauses dealing with the same matter.

Moreover, each section is prepared with notes intended only as information for the Procuring Entity or the person drafting the Bidding Documents. They shall not be included in the final documents. The following general directions should be observed when using the documents:

- a. All the documents listed in the Table of Contents are normally required for the procurement of Infrastructure Projects. However, they should be adapted as necessary to the circumstances of the particular Project.
- b. Specific details, such as the “*name of the Procuring Entity*” and “*address for bid submission*,” should be furnished in the Instructions to Bidders, Bid Data Sheet, and Special Conditions of Contract. The final documents should contain neither blank spaces nor options.
- c. This Preface and the footnotes or notes in italics included in the Invitation to Bid, BDS, General Conditions of Contract, Special Conditions of Contract, Specifications, Drawings, and Bill of Quantities are not part of the text of the final document, although they contain instructions that the Procuring Entity should strictly follow.
- d. The cover should be modified as required to identify the Bidding Documents as to the names of the Project, Contract, and Procuring Entity, in addition to date of issue.

- e. Modifications for specific Procurement Project details should be provided in the Special Conditions of Contract as amendments to the Conditions of Contract. For easy completion, whenever reference has to be made to specific clauses in the Bid Data Sheet or Special Conditions of Contract, these terms shall be printed in bold typeface on Sections I (Instructions to Bidders) and III (General Conditions of Contract), respectively.
- f. For guidelines on the use of Bidding Forms and the procurement of Foreign-Assisted Projects, these will be covered by a separate issuance of the Government Procurement Policy Board.

TABLE OF CONTENTS

GLOSSARY OF	5
TERMS, ABBREVIATIONS, AND ACRONYMS	5
SECTION II. INSTRUCTIONS TO BIDDERS	11
1. Scope of Bid	12
2. Funding Information	12
3. Bidding Requirements.....	12
4. Corrupt, Fraudulent, Collusive, Coercive, and Obstructive Practices	12
5. Eligible Bidders	13
6. Origin of Associated Goods	13
7. Subcontracts	13
8. Pre-Bid Conference.....	13
9. Clarification and Amendment of Bidding Documents	14
10. Documents Comprising the Bid: Eligibility and Technical Components.....	14
11. Documents Comprising the Bid: Financial Component	14
12. Alternative Bids	15
13. Bid Prices	15
14. Bid and Payment Currencies	15
15. Bid Security	15
16. Sealing and Marking of Bids.....	15
17. Deadline for Submission of Bids.....	16
18. Opening and Preliminary Examination of Bids.....	16
19. Detailed Evaluation and Comparison of Bids	16
20. Post Qualification	16
21. Signing of the Contract	17
BAC CHAIRPERSON.....	21
SECTION III. BID DATA SHEET	22
SECTION IV. GENERAL CONDITIONS OF CONTRACT.....	27
1. Scope of Contract.....	27
2. Sectional Completion of Works	27
3. Possession of Site.....	27
4. The Contractor’s Obligations	27
5. Performance Security.....	28

6.	Site Investigation Reports	28
7.	Warranty.....	28
8.	Liability of the Contractor.....	28
9.	Termination for Other Causes	28
10.	Dayworks.....	29
11.	Program of Work	29
12.	Instructions, Inspections and Audits	29
13.	Advance Payment	29
14.	Progress Payments	29
15.	Operating and Maintenance Manuals	30
SECTION V. SPECIAL CONDITIONS OF CONTRACT		31
SECTION VI. SPECIFICATIONS.....		33
SECTION VII. DRAWINGS		35
SECTION VIII. BILL OF QUANTITIES		36
SECTION IX. CHECKLIST OF TECHNICAL AND FINANCIAL DOCUMENTS.....		38

Glossary of Terms, Abbreviations, and Acronyms

ABC – Approved Budget for the Contract.

ARCC – Allowable Range of Contract Cost.

BAC – Bids and Awards Committee.

Bid – A signed offer or proposal to undertake a contract submitted by a bidder in response to and in consonance with the requirements of the bidding documents. Also referred to as *Proposal* and *Tender*. (2016 r

evised IRR, Section 5[c])

Bidder – Refers to a contractor, manufacturer, supplier, distributor and/or consultant who submits a bid in response to the requirements of the Bidding Documents. (2016 revised IRR, Section 5[d])

Bidding Documents – The documents issued by the Procuring Entity as the bases for bids, furnishing all information necessary for a prospective bidder to prepare a bid for the Goods, Infrastructure Projects, and/or Consulting Services required by the Procuring Entity. (2016 revised IRR, Section 5[e])

BIR – Bureau of Internal Revenue.

BSP – Bangko Sentral ng Pilipinas.

CDA – Cooperative Development Authority.

Consulting Services – Refer to services for Infrastructure Projects and other types of projects or activities of the GOP requiring adequate external technical and professional expertise that are beyond the capability and/or capacity of the GOP to undertake such as, but not limited to: (i) advisory and review services; (ii) pre-investment or feasibility studies; (iii) design; (iv) construction supervision; (v) management and related services; and (vi) other technical services or special studies. (2016 revised IRR, Section 5[i])

Contract – Refers to the agreement entered into between the Procuring Entity and the Supplier or Manufacturer or Distributor or Service Provider for procurement of Goods and Services; Contractor for Procurement of Infrastructure Projects; or Consultant or Consulting Firm for Procurement of Consulting Services; as the case may be, as recorded in the Contract Form signed by the parties, including all attachments and appendices thereto and all documents incorporated by reference therein.

Contractor – is a natural or juridical entity whose proposal was accepted by the Procuring Entity and to whom the Contract to execute the Work was awarded. Contractor as used in these Bidding Documents may likewise refer to a supplier, distributor, manufacturer, or consultant.

CPI – Consumer Price Index.

DOLE – Department of Labor and Employment.

DTI – Department of Trade and Industry.

Foreign-funded Procurement or Foreign-Assisted Project – Refers to procurement whose funding source is from a foreign government, foreign or international financing institution as specified in the Treaty or International or Executive Agreement. (2016 revised IRR, Section 5[b]).

GFI – Government Financial Institution.

GOCC – Government-owned and/or –controlled corporation.

Goods – Refer to all items, supplies, materials and general support services, except Consulting Services and Infrastructure Projects, which may be needed in the transaction of public businesses or in the pursuit of any government undertaking, project or activity, whether in the nature of equipment, furniture, stationery, materials for construction, or personal property of any kind, including non-personal or contractual services such as the repair and maintenance of equipment and furniture, as well as trucking, hauling, janitorial, security, and related or analogous services, as well as procurement of materials and supplies provided by the Procuring Entity for such services. The term “related” or “analogous services” shall include, but is not limited to, lease or purchase of office space, media advertisements, health maintenance services, and other services essential to the operation of the Procuring Entity. (2016 revised IRR, Section 5[r])

GOP – Government of the Philippines.

Infrastructure Projects – Include the construction, improvement, rehabilitation, demolition, repair, restoration or maintenance of roads and bridges, railways, airports, seaports, communication facilities, civil works components of information technology projects, irrigation, flood control and drainage, water supply, sanitation, sewerage and solid waste management systems, shore protection, energy/power and electrification facilities, national buildings, school buildings, hospital buildings, and other related construction projects of the government. Also referred to as *civil works or works*. (2016 revised IRR, Section 5[u])

LGUs – Local Government Units.

NFCC – Net Financial Contracting Capacity.

NGA – National Government Agency.

PCAB – Philippine Contractors Accreditation Board.

PhilGEPS - Philippine Government Electronic Procurement System.

Procurement Project – refers to a specific or identified procurement covering goods, infrastructure project or consulting services. A Procurement Project shall be described, detailed, and scheduled in the Project Procurement Management Plan prepared by the agency

which shall be consolidated in the procuring entity's Annual Procurement Plan. (GPPB Circular No. 06-2019 dated 17 July 2019)

PSA – Philippine Statistics Authority.

SEC – Securities and Exchange Commission.

SLCC – Single Largest Completed Contract.

UN – United Nations.

Section I. Invitation to Bid

Notes on the Invitation to Bid

The Invitation to Bid (IB) provides information that enables potential Bidders to decide whether to participate in the procurement at hand. The IB shall be posted in accordance with Section 21.2 of the 2016 revised IRR of RA No. 9184.

Apart from the essential items listed in the Bidding Documents, the IB should also indicate the following:

- a. The date of availability of the Bidding Documents, which shall be from the time the IB is first advertised/posted until the deadline for the submission and receipt of bids;
- b. The place where the Bidding Documents may be acquired or the website where it may be downloaded;
- c. The deadline for the submission and receipt of bids; and
- d. Any important bid evaluation criteria.

The IB should be incorporated into the Bidding Documents. The information contained in the IB must conform to the Bidding Documents and in particular to the relevant information in the Bid Data Sheet.



Section I. Invitation to Bid

Invitation to Bid for [Proposed Expansion with Improvement Works at Pasig City Children's Hospital, Industria corner Alcalde Jose Sts., Brgy. Kapisigan, Pasig City.](#)

1. The **City Government of Pasig**, through the Annual or Supplemental Budget, as approved by the Sanggunian intends to apply the sum of **PHP 319,778,374.90** being the Approved Budget for the Contract (ABC) to payments under the contract **Proposed Expansion with Improvement Works at Pasig City Children's Hospital, Industria corner Alcalde Jose Sts., Brgy. Kapisigan, Pasig City.** Bids received in excess of the ABC for each lot shall be automatically rejected at bid opening.
2. The **City Government of Pasig** now invites bids for the above Procurement Project. Completion of the Works is required **600 calendar days**. Bidders should have completed a contract similar to the Project. The description of an eligible bidder is contained in the Bidding Documents, particularly, in Section II (Instructions to Bidders).
3. Bidding will be conducted through open competitive bidding procedures using non-discretionary “*pass/fail*” criterion as specified in the 2016 revised Implementing Rules and Regulations (IRR) of Republic Act (RA) No. 9184.
4. Interested bidders may obtain further information from City Government of Pasig and inspect the Bidding Documents at the address given below from 8:00 A.M. to 5:00 P.M. office hours.
5. A complete set of Bidding Documents may be acquired by interested bidders on **January 5, 2024** from given address and website/s below *and upon payment of the applicable fee for the Bidding Documents, pursuant to the latest Guidelines issued by the GPPB, in the amount of PHP50,000.00*. The Procuring Entity shall allow the bidder to present its proof of payment for the fees presented in person.
6. The City Government of Pasig will hold a Pre-Bid Conference¹ on **January 12, 2024, 1:30 P.M.**, at **7th Floor Meeting Room, Pasig City Hall** which shall be open to prospective bidders.
7. **Bids must be duly received by the Procurement Management Office (BAC Secretariat Office) through manual submission at the office address as indicated below, on or before 9:30 A.M. of January 24, 2024**. Late bids shall not be accepted.

8. All bids must be accompanied by a bid security in any of the acceptable forms and in the amount stated in **ITB Clause 16**.
9. Bid opening shall be on **January 24, 2024 at 10:00 A.M.** at the given address below **7th Floor Meeting Room, Pasig City Hall.** Bids will be opened in the presence of the bidders' representatives who choose to attend the activity.
10. **The address for submission of bids is at the Procurement Management Office (BAC Secretariat Office), 4th Floor Pasig City Hall Caruncho Avenue, San Nicolas Pasig City. The deadline for submission of bids is on or before 9:30 A.M. of January 24, 2024.**

Each Bidder shall submit **ONE (1) SEALED MOTHER ENVELOPE** containing:

1. ORIGINAL (SEALED AND LABELED)

1.1. Hard Copy Original Technical Components and

1.2. Hard Copy Original Financial Components and

1.3 One (1) **USB Flash Drive** containing scanned P.D.F. Documents of the Original Technical Components and Original Financial Components.

2. COPY 1 (SEALED AND LABELED)

2.1. One (1) **USB Flash Drive** or **CD** sealed and labeled as "**COPY 1**" containing scanned P.D.F Documents of Technical and Financial Components.

11. The **City Government of Pasig** reserves the right to reject any and all bids, declare a failure of bidding, or not award the contract at any time prior to contract award in accordance with Sections 35.6 and 41 of the 2016 revised Implementing Rules and Regulations (IRR) of RA No. 9184, without thereby incurring any liability to the affected bidder or bidders.
12. For further information, please refer to:

ATTY. BEA THERESE P. VILLANUEVA
Officer-in-Charge, Procurement Management Office
CITY GOVERNMENT OF PASIG
Procurement Management Office, 4th Floor, Pasig City Hall,
Caruncho Ave., San Nicolas Pasig City
bidсандawards@pasigcity.gov.ph
8643-1111 loc. 1461

13. You may visit the following websites:
For downloading of bidding documents
PS-Philgeps Website
Pasig City Website

January 5, 2024

(SGD.)
ATTY. JOSEPHINE C. LATI-BAGAOISAN
BAC Chairperson

Section II. Instructions to Bidders

Notes on the Instructions to Bidders

This Section on the Instruction to Bidders (ITB) provides the information necessary for bidders to prepare responsive bids, in accordance with the requirements of the Procuring Entity. It also provides information on bid submission, eligibility check, opening and evaluation of bids, post-qualification, and on the award of contract.

Section II. Instructions to Bidders

1. Scope of Bid

The Procuring Entity, **City Government of Pasig** invites Bids for the [Proposed Expansion with Improvement Works at Pasig City Children's Hospital, Industria corner Alcalde Jose Sts., Brgy. Kapasigan, Pasig City](#), with Project Identification Number [PB-01-24-2024-02](#).

[Note: The Project Identification Number is assigned by the Procuring Entity based on its own coding scheme and is not the same as the PhilGEPS reference number, which is generated after the posting of the bid opportunity on the PhilGEPS website.]

The Procurement Project (referred to herein as “Project”) is for the construction of Works, as described in Section VI (Specifications).

2. Funding Information

2.1. The GOP through the source of funding as indicated below for [CY 2024](#) in the amount of [PHP 319,778,374.90](#).

2.2. The source of funding is:

LGUs, the Annual or Supplemental Budget, as approved by the Sanggunian.

3. Bidding Requirements

The Bidding for the Project shall be governed by all the provisions of RA No. 9184 and its 2016 revised IRR, including its Generic Procurement Manual and associated policies, rules and regulations as the primary source thereof, while the herein clauses shall serve as the secondary source thereof.

Any amendments made to the IRR and other GPPB issuances shall be applicable only to the ongoing posting, advertisement, or invitation to bid by the BAC through the issuance of a supplemental or bid bulletin.

The Bidder, by the act of submitting its Bid, shall be deemed to have inspected the site, determined the general characteristics of the contracted Works and the conditions for this Project, such as the location and the nature of the work; (b) climatic conditions; (c) transportation facilities; (c) nature and condition of the terrain, geological conditions at the site communication facilities, requirements, location and availability of construction aggregates and other materials, labor, water, electric power and access roads; and (d) other factors that may affect the cost, duration and execution or implementation of the contract, project, or work and examine all instructions, forms, terms, and project requirements in the Bidding Documents.

4. Corrupt, Fraudulent, Collusive, Coercive, and Obstructive Practices

The Procuring Entity, as well as the Bidders and Contractors, shall observe the highest standard of ethics during the procurement and execution of the contract. They or through an agent shall not engage in corrupt, fraudulent, collusive, coercive, and obstructive practices defined under Annex “I” of the 2016 revised IRR of RA No. 9184 or other integrity violations in competing for the Project.

5. Eligible Bidders

- 5.1. Only Bids of Bidders found to be legally, technically, and financially capable will be evaluated.
- 5.2. The Bidder must have an experience of having completed a Single Largest Completed Contract (SLCC) that is similar to this Project, equivalent to at least fifty percent (50%) of the ABC adjusted, if necessary, by the Bidder to current prices using the PSA’s CPI, except under conditions provided for in Section 23.4.2.4 of the 2016 revised IRR of RA No. 9184.

A contract is considered to be “similar” to the contract to be bid if it has the major categories of work stated in the **BDS**.

- 5.3. For Foreign-funded Procurement, the Procuring Entity and the foreign government/foreign or international financing institution may agree on another track record requirement, as specified in the Bidding Document prepared for this purpose.
- 5.4. The Bidders shall comply with the eligibility criteria under Section 23.4.2 of the 2016 IRR of RA No. 9184.

6. Origin of Associated Goods

There is no restriction on the origin of Goods other than those prohibited by a decision of the UN Security Council taken under Chapter VII of the Charter of the UN.

7. Subcontracts

- 7.1. The Procuring Entity has prescribed that:
 - a. Subcontracting is not allowed.
- 7.2. Subcontracting of any portion of the Project does not relieve the Contractor of any liability or obligation under the Contract. The Supplier will be responsible for the acts, defaults, and negligence of any subcontractor, its agents, servants, or workmen as fully as if these were the Contractor’s own acts, defaults, or negligence, or those of its agents, servants, or workmen.

8. Pre-Bid Conference

The Procuring Entity will hold a pre-bid conference for this Project on the specified date and time and either at its physical address as indicated in paragraph 6 of the **IB**.

9. Clarification and Amendment of Bidding Documents

Prospective bidders may request for clarification on and/or interpretation of any part of the Bidding Documents. Such requests must be in writing and received by the Procuring Entity, either at its given address or through electronic mail indicated in the **IB**, at least ten (10) calendar days before the deadline set for the submission and receipt of Bids.

10. Documents Comprising the Bid: Eligibility and Technical Components

- 10.1. The first envelope shall contain the eligibility and technical documents of the Bid as specified in **Section IX. Checklist of Technical and Financial Documents**.
- 10.2. If the eligibility requirements or statements, the bids, and all other documents for submission to the BAC are in foreign language other than English, it must be accompanied by a translation in English, which shall be authenticated by the appropriate Philippine foreign service establishment, post, or the equivalent office having jurisdiction over the foreign bidder's affairs in the Philippines. For Contracting Parties to the Apostille Convention, only the translated documents shall be authenticated through an apostille pursuant to GPPB Resolution No. 13-2019 dated 23 May 2019. The English translation shall govern, for purposes of interpretation of the bid.
- 10.3. A valid special PCAB License in case of Joint Ventures, and registration for the type and cost of the contract for this Project. Any additional type of Contractor license or permit shall be indicated in the **BDS**.
- 10.4. A List of Contractor's key personnel (e.g., Project Manager, Project Engineers, Materials Engineers, and Foremen) assigned to the contract to be bid, with their complete qualification and experience data shall be provided. These key personnel must meet the required minimum years of experience set in the **BDS**.
- 10.5. A List of Contractor's major equipment units, which are owned, leased, and/or under purchase agreements, supported by proof of ownership, certification of availability of equipment from the equipment lessor/vendor for the duration of the project, as the case may be, must meet the minimum requirements for the contract set in the **BDS**.

11. Documents Comprising the Bid: Financial Component

- 11.1. The second bid envelope shall contain the financial documents for the Bid as specified in **Section IX. Checklist of Technical and Financial Documents**.

- 11.2. Any bid exceeding the ABC indicated in paragraph 1 of the **IB** shall not be accepted.
- 11.3. For Foreign-funded procurement, a ceiling may be applied to bid prices provided the conditions are met under Section 31.2 of the 2016 revised IRR of RA No. 9184.

12. Alternative Bids

Bidders shall submit offers that comply with the requirements of the Bidding Documents, including the basic technical design as indicated in the drawings and specifications. Unless there is a value engineering clause in the **BDS**, alternative Bids shall not be accepted.

13. Bid Prices

All bid prices for the given scope of work in the Project as awarded shall be considered as fixed prices, and therefore not subject to price escalation during contract implementation, except under extraordinary circumstances as determined by the NEDA and approved by the GPPB pursuant to the revised Guidelines for Contract Price Escalation guidelines.

14. Bid and Payment Currencies

14.1. Bid prices may be quoted in the local currency or tradeable currency accepted by the BSP at the discretion of the Bidder. However, for purposes of bid evaluation, Bids denominated in foreign currencies shall be converted to Philippine currency based on the exchange rate as published in the BSP reference rate bulletin on the day of the bid opening.

14.2. *Payment of the contract price shall be made in:*

- a. Philippine Pesos

15. Bid Security

15.1. The Bidder shall submit a Bid Securing Declaration or any form of Bid Security in the amount indicated in the **BDS**, which shall be not less than the percentage of the ABC in accordance with the schedule in the **BDS**.

15.2. The Bid and bid security shall be valid until **120 calendar days**. Any bid not accompanied by an acceptable bid security shall be rejected by the Procuring Entity as non-responsive.

16. Sealing and Marking of Bids

Each Bidder shall submit one copy of the first and second components of its Bid.

The Procuring Entity may request additional hard copies and/or electronic copies of the Bid. However, failure of the Bidders to comply with the said request shall not be a ground for disqualification.

If the Procuring Entity allows the submission of bids through online submission to the given website or any other electronic means, the Bidder shall submit an electronic copy of its Bid, which must be digitally signed. An electronic copy that cannot be opened or is corrupted shall be considered non-responsive and, thus, automatically disqualified.

17. Deadline for Submission of Bids

The Bidders shall submit on the specified date and time and either at its physical address or through online submission as indicated in paragraph 7 of the **IB**.

18. Opening and Preliminary Examination of Bids

18.1. The BAC shall open the Bids in public at the time, on the date, and at the place specified in paragraph 9 of the **IB**. The Bidders' representatives who are present shall sign a register evidencing their attendance. In case videoconferencing, webcasting or other similar technologies will be used, attendance of participants shall likewise be recorded by the BAC Secretariat.

In case the Bids cannot be opened as scheduled due to justifiable reasons, the rescheduling requirements under Section 29 of the 2016 revised IRR of RA No. 9184 shall prevail.

18.2. The preliminary examination of Bids shall be governed by Section 30 of the 2016 revised IRR of RA No. 9184.

19. Detailed Evaluation and Comparison of Bids

19.1. The Procuring Entity's BAC shall immediately conduct a detailed evaluation of all Bids rated "*passed*" using non-discretionary pass/fail criteria. The BAC shall consider the conditions in the evaluation of Bids under Section 32.2 of 2016 revised IRR of RA No. 9184.

19.2. If the Project allows partial bids, all Bids and combinations of Bids as indicated in the **BDS** shall be received by the same deadline and opened and evaluated simultaneously so as to determine the Bid or combination of Bids offering the lowest calculated cost to the Procuring Entity. Bid Security as required by **ITB** Clause 16 shall be submitted for each contract (lot) separately.

19.3. In all cases, the NFCC computation pursuant to Section 23.4.2.6 of the 2016 revised IRR of RA No. 9184 must be sufficient for the total of the ABCs for all the lots participated in by the prospective Bidder.

20. Post Qualification

Within a non-extendible period of five (5) calendar days from receipt by the Bidder of the notice from the BAC that it submitted the Lowest Calculated Bid, the Bidder shall submit its latest income and business tax returns filed and paid through the BIR Electronic Filing and Payment System (eFPS), and other appropriate licenses and permits required by law and stated in the **BDS**.

21. Signing of the Contract

The documents required in Section 37.2 of the 2016 revised IRR of RA No. 9184 shall form part of the Contract. Additional Contract documents are indicated in the **BDS**.

INSTRUCTION TO BIDDERS

PROJECT : Proposed Expansion with Improvement Works at Pasig City Children's
Hospital, Industria corner Alcalde Jose Sts., Brgy. Kapasigan, Pasig City

Date : January 5, 2024

This shall form an integral part of the Bid Documents.

1. Bidders are requested to organize and submit their bids on the following requirements:

1. *Submit First (1st) Envelope containing one (1) hardcopy of the ORIGINAL Technical Component, including the Eligibility Requirements. 1st Envelope shall be sealed and labeled as "ORIGINAL TECHNICAL COMPONENT".*
2. *Submit Second (2nd) Envelope containing one (1) hard copy of the ORIGINAL Financial Component. 2nd Envelope shall be sealed and labeled as "ORIGINAL FINANCIAL COMPONENT".*
3. *Submit USB Flash Drive containing one (1) soft/scanned copy of the ORIGINAL Technical Component and Financial Component;*

***Note:** The 1st Envelope, 2nd Envelope and the USB flash drive containing the soft/scanned copy of the original technical and financial components shall be enclosed in a single envelope, sealed and labeled as "ORIGINAL BID".*
4. *Submit USB Flash Drive containing one (1) soft/scanned copy of the Technical Component and Financial Component. USB flash drive shall be enclosed in a separate envelope, sealed and labeled as "COPY1".*
5. *The "ORIGINAL BID" and "COPY 1" envelopes shall be enclosed in a single MOTHER ENVELOPE sealed and properly labeled.*

**Sections of the bid shall be separated by dividers, proper tabs;*

****NO** scratch papers.*

All envelopes (1st Envelope, 2nd Envelope, Original Bid Envelope, Copy 1 Envelope and Mother Envelope) shall be labeled as follows:

- **Addressed to the procuring entity’s BAC Chairperson**
 - **Name of the project/contract to be bid**
 - **Name, address and contact details of the bidder including e-mail address**
 - **“DO NOT OPEN BEFORE <bid opening date and time>”**
- ✓ Unsealed or unmarked bid envelopes shall be rejected. However, bid envelopes that are not properly sealed and marked, as required in the bidding documents, shall be accepted, provided that the bidder or its duly authorized representative shall acknowledge such condition of the bid as submitted. The Procuring Entity shall not be responsible for misplaced Bidding Documents and premature opening.

BIDDING DOCUMENTS AVAILABILITY AND FEE

- Bidding Documents:
 - January 5, 2024 to January 24, 2024 until 9:30 A.M.
 - 8:00 am to 5:00 pm and upon payment of applicable fees for the Bidding Documents at the City Treasurer’s Office.
- Bidders shall pay the applicable fee for the Bidding Documents not later than the submission of their bids.
- Standard rates for bidding documents

Approved Budget for the Contract	Maximum Cost of Bidding Documents
500,000 and below	P500.00
More than 500,000 up to 1 million	1,000.00
More than 1 million up to 5 million	5,000.00
More than 5 million up to 10 million	10,000.00
More than 10 million up to 50 million	25,000.00
More than 50 million up to 500 million	50,000.00
More than 500 million	75,000.00

INSTRUCTION TO BIDDERS ON PAYMENT OF BIDDING DOCUMENTS

- Secure Order of Payment for the bidding documents at the Procurement Management Office, 4th Floor Pasig City Hall.

- Proceed to City Treasurer's Office, 1st Floor Pasig City Hall for the payment of bidding documents.
- Mode of payment: Cashier Manager's/Cashier's Check payable to City Government of Pasig
 - **Personal Check shall not be accepted.**
- Present the Official Receipt to the BAC Secretariat's Office for the release of the complete Set of bidding documents.

REMINDERS:

- The **deadline for the submission of bid is on January 24, 2024 at 9:30 AM at the Procurement Management Office, 4th Floor Pasig City Hall, Caruncho Ave., San Nicolas Pasig City.** The digital clock at the Procurement Management Office that is set to the Philippine Time (PhST) shall be used as reference in determining the time for the submission of bids, Hence participating bidders are advised to synchronize their timepiece with the said digital clock. **Late bids or those who submitted after 9:30 AM of January 24, 2024 shall not be accepted.**
- Bidders may submit their bid documents days ahead of the deadline for the submission in order to avoid late submission.
- **Bid opening shall be on January 24, 2024 at 10:00 AM at 7th Floor Meeting Room, Pasig City Hall, Caruncho Ave., San Nicolas Pasig City.** Bids will be opened in the presence of the bidders' representatives who choose to attend.
- All licenses, permits and other required clearances should be valid at the time of the submission of bids, Post-Qualification Evaluation and signing of the contract.

- *The BAC expects the bidders to exercise due diligence in going through the bid documents so that they can prepare their bids intelligently.*
- *The Bids and Awards Committee will still continue to implement social distancing and shall require only one (1) Representative per company.*
- All attendees will be subjected to thermal scan prior to entry of the venue and shall:
 1. Wear medical face mask and face shield at all times—**“No Mask No Entry”**
 2. Bring black ballpen
 3. Bring alcohol

Please be reminded that all queries after the issuance of Bid Bulletin will not be entertained.

(SGD.)

ATTY. JOSEPHINE C. LATI-BAGAOISAN

BAC Chairperson

Section III. Bid Data Sheet

Notes on the Bid Data Sheet (BDS)

The Bid Data Sheet (BDS) consists of provisions that supplement, amend, or specify in detail, information, or requirements included in the ITB found in Section II, which are specific to each procurement.

This Section is intended to assist the Procuring Entity in providing the specific information in relation to corresponding clauses in the ITB and has to be prepared for each specific procurement.

The Procuring Entity should specify in the BDS information and requirements specific to the circumstances of the Procuring Entity, the processing of the procurement, and the bid evaluation criteria that will apply to the Bids. In preparing the BDS, the following aspects should be checked:

- a. Information that specifies and complements provisions of the ITB must be incorporated.
- b. Amendments and/or supplements, if any, to provisions of the ITB as necessitated by the circumstances of the specific procurement, must also be incorporated.

Section III. Bid Data Sheet

Bid Data Sheet

ITB Clause																												
5.2	For this purpose, contracts similar to the Project refer to contracts which have the same major categories of work, which shall be: <u>The Bidder must have an experience of having completed a Single Largest Completed Contract (SLCC) that is similar to this Project-Construction and/or Major Improvement Works of Hospital Building, equivalent to at least fifty percent (50%) of the ABC.</u>																											
7.1	Subcontracting is not allowed.																											
10.3	The Bidder must have a valid Philippine Contractors Accreditation Board (PCAB) license and registration for Size Range – <u>Large A- Building & Industrial Plant</u> License at least Category: <u>General Building- AA</u>																											
10.4	The key personnel must meet the required minimum years of experience set below: <table border="1" style="width: 100%; border-collapse: collapse;"> <thead> <tr> <th style="text-align: center;">KEY PERSONNEL</th> <th style="text-align: center;">QTY.</th> <th style="text-align: center;">GENERAL EXPERIENCE</th> <th style="text-align: center;">RELEVANT EXPERIENCE</th> </tr> </thead> <tbody> <tr> <td>Project Manager (PM)/ Civil Engineer</td> <td style="text-align: center;">1</td> <td>Licensed Civil Engineer</td> <td>With a minimum of five (5) years relevant work experience as Project Manager in Building construction</td> </tr> <tr> <td>Electrical Engineer</td> <td style="text-align: center;">1</td> <td>Licensed Electrical Engineer</td> <td>With a minimum of 5 years relevant work experience as Electrical Engineer in Building Construction</td> </tr> <tr> <td>Mechanical Engineer</td> <td style="text-align: center;">1</td> <td>Licensed Mechanical Engineer</td> <td>With a minimum of 5 years relevant work experience as Mechanical Engineer in Building Construction</td> </tr> <tr> <td>Electronics Engineer</td> <td style="text-align: center;">1</td> <td>Licensed Electronics Engineer</td> <td>With a minimum of 5 years relevant work experience as Electronics Engineer in Building Construction</td> </tr> <tr> <td>Sanitary Engineer/ Master Plumber</td> <td style="text-align: center;">1</td> <td>Licensed Master Plumber</td> <td>With a minimum of 3 years in Building</td> </tr> </tbody> </table>				KEY PERSONNEL	QTY.	GENERAL EXPERIENCE	RELEVANT EXPERIENCE	Project Manager (PM)/ Civil Engineer	1	Licensed Civil Engineer	With a minimum of five (5) years relevant work experience as Project Manager in Building construction	Electrical Engineer	1	Licensed Electrical Engineer	With a minimum of 5 years relevant work experience as Electrical Engineer in Building Construction	Mechanical Engineer	1	Licensed Mechanical Engineer	With a minimum of 5 years relevant work experience as Mechanical Engineer in Building Construction	Electronics Engineer	1	Licensed Electronics Engineer	With a minimum of 5 years relevant work experience as Electronics Engineer in Building Construction	Sanitary Engineer/ Master Plumber	1	Licensed Master Plumber	With a minimum of 3 years in Building
KEY PERSONNEL	QTY.	GENERAL EXPERIENCE	RELEVANT EXPERIENCE																									
Project Manager (PM)/ Civil Engineer	1	Licensed Civil Engineer	With a minimum of five (5) years relevant work experience as Project Manager in Building construction																									
Electrical Engineer	1	Licensed Electrical Engineer	With a minimum of 5 years relevant work experience as Electrical Engineer in Building Construction																									
Mechanical Engineer	1	Licensed Mechanical Engineer	With a minimum of 5 years relevant work experience as Mechanical Engineer in Building Construction																									
Electronics Engineer	1	Licensed Electronics Engineer	With a minimum of 5 years relevant work experience as Electronics Engineer in Building Construction																									
Sanitary Engineer/ Master Plumber	1	Licensed Master Plumber	With a minimum of 3 years in Building																									

			Construction projects handled as Safety Officer
Safety Officer	1	DOLE Accredited COSH experience	At least 1 year experience on construction
Foreman	4	At least 1 year experience	At least 1 year experience Building Construction as Foreman

The Bidder shall submit the corresponding bio-data of the above key personnel that includes description of his/her relevant experience. The bio-data shall include a statement of availability of the key personnel for the duration of the project, signed by the named key personnel. The key personnel can be a current or on-call employee, or a consultant of the company.

10.5

The minimum major equipment requirements are the following:

Equipment Capacity Number of Units

EQUIPMENT	CAPACITY	NUMBER OF UNITS
Elf	35.31 ft.3	2
Angle Grinder	1400W	3
Table Saw	1800W	1
Hand Drill	400W	5
Hand Saw	n/a	2
Electrician Tool Set	n/a	6
Aircon Technician Tools	n/a	4
Electronic Tools	n/a	6
Multimeter Tester	n/a	4
Ground Resistance Tester	n/a	1
Vacuum Pump	n/a	4
Data Connector Tester	n/a	6
Tile Cutter	n/a	1
Welding Machine	400A	2
Jack hammer	n/a	1

12

No further instructions.

15.1

The bid security shall be in the form of a *Bid Securing Declaration* or any of the following forms and amounts:

- a. The amount of not less than 2% of ABC, if bid security is in cash, cashier's/manager's check, bank draft/guarantee or irrevocable letter of credit;
- b. The amount of not less than 5% of ABC if bid security is in Surety Bond.

19.2	No further instructions.
20	<p>The following licenses/s and permit/s shall be required:</p> <ol style="list-style-type: none"> 1. Registration certificate form Securities and Exchange Commission (SEC), Department of Trade and Industry (DTI) for sole proprietorship, or Cooperative Development Authority (CDA) for cooperatives of its equivalent document 1. Mayor’s or Business permit issued by the city or municipality where the principal place of business of the prospective bidder is located. 2. Tax clearance per E.O. No. 398, s. 2005, as finally reviewed and approved by the Bureau of Internal Revenue (BIR) 3. Valid PCAB License Category: <u>General Building- AA</u> and Registration of at least <u>Large A- Building & Industrial Plant</u> 4. The prospective bidder’s audited financial statements, showing, among others, the prospective bidder’s total and current assets and liabilities, stamped “received” by the BIR or its duly accredited and authorized institutions, for the preceding calendar year which should not be earlier than two (2) years from the date of bid submission. 5. Latest income and business tax returns 6. Valid licenses issued by the Professional Regulatory Commission (PRC); <p>No other acceptable proof of registration is recognized.</p>
21	Additional contract documents relevant to the Project that may be required by existing laws and/or the Procuring Entity, such as construction schedule and PERT/CPM S-curve, manpower schedule, construction methods, equipment utilization schedule, construction safety and health program approved by the DOLE, and other acceptable tools of project scheduling.

Section IV. General Conditions of Contract

Notes on the General Conditions of Contract

The General Conditions of Contract (GCC) in this Section, read in conjunction with the Special Conditions of Contract in Section V and other documents listed therein, should be a complete document expressing all the rights and obligations of the parties.

Matters governing performance of the Contractor, payments under the contract, or matters affecting the risks, rights, and obligations of the parties under the contract are included in the GCC and Special Conditions of Contract.

Any complementary information, which may be needed, shall be introduced only through the Special Conditions of Contract.

Section IV. General Conditions of Contract

1. Scope of Contract

This Contract shall include all such items, although not specifically mentioned, that can be reasonably inferred as being required for its completion as if such items were expressly mentioned herein. All the provisions of RA No. 9184 and its 2016 revised IRR, including the Generic Procurement Manual, and associated issuances, constitute the primary source for the terms and conditions of the Contract, and thus, applicable in contract implementation. Herein clauses shall serve as the secondary source for the terms and conditions of the Contract.

This is without prejudice to Sections 74.1 and 74.2 of the 2016 revised IRR of RA No. 9184 allowing the GPPB to amend the IRR, which shall be applied to all procurement activities, the advertisement, posting, or invitation of which were issued after the effectivity of the said amendment.

2. Sectional Completion of Works

If sectional completion is specified in the **Special Conditions of Contract (SCC)**, references in the Conditions of Contract to the Works, the Completion Date, and the Intended Completion Date shall apply to any Section of the Works (other than references to the Completion Date and Intended Completion Date for the whole of the Works).

3. Possession of Site

3.1 The Procuring Entity shall give possession of all or parts of the Site to the Contractor based on the schedule of delivery indicated in the **SCC**, which corresponds to the execution of the Works. If the Contractor suffers delay or incurs cost from failure on the part of the Procuring Entity to give possession in accordance with the terms of this clause, the Procuring Entity's Representative shall give the Contractor a Contract Time Extension and certify such sum as fair to cover the cost incurred, which sum shall be paid by Procuring Entity.

3.2 If possession of a portion is not given by the above date, the Procuring Entity will be deemed to have delayed the start of the relevant activities. The resulting adjustments in contract time to address such delay may be addressed through contract extension provided under Annex "E" of the 2016 revised IRR of RA No. 9184.

4. The Contractor's Obligations

The Contractor shall employ the key personnel named in the Schedule of Key Personnel indicating their designation, in accordance with **ITB** Clause 10.3 and specified in the **BDS**, to carry out the supervision of the Works.

The Procuring Entity will approve any proposed replacement of key personnel only if their relevant qualifications and abilities are equal to or better than those of the personnel listed in the Schedule.

5. Performance Security

- 5.1. Within ten (10) calendar days from receipt of the Notice of Award from the Procuring Entity but in no case later than the signing of the contract by both parties, the successful Bidder shall furnish the performance security in any of the forms prescribed in Section 39 of the 2016 revised IRR.
- 5.2. The Contractor, by entering into the Contract with the Procuring Entity, acknowledges the right of the Procuring Entity to institute action pursuant to RA No. 3688 against any subcontractor be they an individual, firm, partnership, corporation, or association supplying the Contractor with labor, materials and/or equipment for the performance of this Contract.

6. Site Investigation Reports

The Contractor, in preparing the Bid, shall rely on any Site Investigation Reports referred to in the SCC supplemented by any information obtained by the Contractor.

7. Warranty

- 7.1. In case the Contractor fails to undertake the repair works under Section 62.2.2 of the 2016 revised IRR, the Procuring Entity shall forfeit its performance security, subject its property(ies) to attachment or garnishment proceedings, and perpetually disqualify it from participating in any public bidding. All payables of the GOP in his favor shall be offset to recover the costs.
- 7.2. The warranty against Structural Defects/Failures, except that occasioned-on force majeure, shall cover the period from the date of issuance of the Certificate of Final Acceptance by the Procuring Entity. Specific duration of the warranty is found in the SCC.

8. Liability of the Contractor

Subject to additional provisions, if any, set forth in the SCC, the Contractor's liability under this Contract shall be as provided by the laws of the Republic of the Philippines.

If the Contractor is a joint venture, all partners to the joint venture shall be jointly and severally liable to the Procuring Entity.

9. Termination for Other Causes

Contract termination shall be initiated in case it is determined *prima facie* by the Procuring Entity that the Contractor has engaged, before, or during the implementation of the contract, in unlawful deeds and behaviors relative to contract

acquisition and implementation, such as, but not limited to corrupt, fraudulent, collusive, coercive, and obstructive practices as stated in **ITB** Clause 4.

10. Dayworks

Subject to the guidelines on Variation Order in Annex “E” of the 2016 revised IRR of RA No. 9184, and if applicable as indicated in the **SCC**, the Dayworks rates in the Contractor’s Bid shall be used for small additional amounts of work only when the Procuring Entity’s Representative has given written instructions in advance for additional work to be paid for in that way.

11. Program of Work

11.1. The Contractor shall submit to the Procuring Entity’s Representative for approval the said Program of Work showing the general methods, arrangements, order, and timing for all the activities in the Works. The submissions of the Program of Work are indicated in the **SCC**.

11.2. The Contractor shall submit to the Procuring Entity’s Representative for approval an updated Program of Work at intervals no longer than the period stated in the **SCC**. If the Contractor does not submit an updated Program of Work within this period, the Procuring Entity’s Representative may withhold the amount stated in the **SCC** from the next payment certificate and continue to withhold this amount until the next payment after the date on which the overdue Program of Work has been submitted.

12. Instructions, Inspections and Audits

The Contractor shall permit the GOP or the Procuring Entity to inspect the Contractor’s accounts and records relating to the performance of the Contractor and to have them audited by auditors of the GOP or the Procuring Entity, as may be required.

13. Advance Payment

The Procuring Entity shall, upon a written request of the Contractor which shall be submitted as a Contract document, make an advance payment to the Contractor in an amount not exceeding fifteen percent (15%) of the total contract price, to be made in lump sum, or at the most two installments according to a schedule specified in the **SCC**, subject to the requirements in Annex “E” of the 2016 revised IRR of RA No. 9184.

14. Progress Payments

The Contractor may submit a request for payment for Work accomplished. Such requests for payment shall be verified and certified by the Procuring Entity’s Representative/Project Engineer. Except as otherwise stipulated in the **SCC**, materials and equipment delivered on the site but not completely put in place shall not be included for payment.

15. Operating and Maintenance Manuals

- 15.1. If required, the Contractor will provide “as built” Drawings and/or operating and maintenance manuals as specified in the **SCC**.
- 15.2. If the Contractor does not provide the Drawings and/or manuals by the dates stated above, or they do not receive the Procuring Entity’s Representative’s approval, the Procuring Entity’s Representative may withhold the amount stated in the **SCC** from payments due to the Contractor.

Section V. Special Conditions of Contract

Notes on the Special Conditions of Contract

Similar to the BDS, the clauses in this Section are intended to assist the Procuring Entity in providing contract-specific information in relation to corresponding clauses in the GCC found in Section IV.

The Special Conditions of Contract (SCC) complement the GCC, specifying contractual requirements linked to the special circumstances of the Procuring Entity, the Procuring Entity's country, the sector, and the Works procured. In preparing this Section, the following aspects should be checked:

- a. Information that complements provisions of the GCC must be incorporated.
- b. Amendments and/or supplements to provisions of the GCC as necessitated by the circumstances of the specific purchase, must also be incorporated.

However, no special condition which defeats or negates the general intent and purpose of the provisions of the GCC should be incorporated herein.

Section V. Special Conditions of Contract

Special Conditions of Contract

GCC Clause	
2	The Intended Completion Date is <u>600 calendar days</u> .
3.1	The Procuring Entity shall give possession of all parts of the Site to the Contractor upon the issuance of Notice to Proceed.
6	No further instructions.
7.2	<p><i>In case of permanent structures, such as buildings of types 4 and 5 as classified under the National Building Code of the Philippines and other structures made of steel, iron, or concrete which comply with relevant structural codes (e.g., DPWH Standard Specifications), such as, but not limited to, steel/concrete bridges, flyovers, aircraft movement areas, ports, dams, tunnels, filtration and treatment plants, sewerage systems, power plants, transmission and communication towers, railway system, and other similar permanent structures: Fifteen (15) years.</i></p> <p><i>In case of semi-permanent structures, such as buildings of types 1, 2, and 3 as classified under the National Building Code of the Philippines, concrete/asphalt roads, concrete river control, drainage, irrigation lined canals, river landing, deep wells, rock causeway, pedestrian overpass, and other similar semi-permanent structures: Five (5) years.</i></p> <p><i>In case of other structures, such as Bailey and wooden bridges, shallow wells, spring developments, and other similar structures: Two (2) years.</i></p>
10	Dayworks are applicable at the rate shown in the Contractor's original Bid.
11.1	The Contractor shall submit the Program of Work showing the general methods, arrangements, order, and timing for all the activities in the Works to the Procuring Entity's Representative within ten (10) days of delivery of the Notice of Award.
11.2	The amount to be withheld for late submission of an updated Program of Work is one percent (1%).
13	Advance payment shall be made only upon the submission to and acceptance by the Procuring Entity. The amount of the advance payment is fifteen percent (15%) of the Contract price.
14	No further instructions.
15.1	If required, the Contractor will provide "as built" Drawings and/or operating and maintenance manuals within thirty (30) calendar days from the completion of the project.
15.2	The amount to be withheld for failing to produce "as built" drawings and/or operating and maintenance manuals by the date required is one percent (1%) of the final contract amount.

Section VI. Specifications

Notes on Specifications

A set of precise and clear specifications is a prerequisite for Bidders to respond realistically and competitively to the requirements of the Procuring Entity without qualifying or conditioning their Bids. In the context of international competitive bidding, the specifications must be drafted to permit the widest possible competition and, at the same time, present a clear statement of the required standards of workmanship, materials, and performance of the goods and services to be procured. Only if this is done will the objectives of economy, efficiency, and fairness in procurement be realized, responsiveness of Bids be ensured, and the subsequent task of bid evaluation facilitated. The specifications should require that all goods and materials to be incorporated in the Works be new, unused, of the most recent or current models, and incorporate all recent improvements in design and materials unless provided otherwise in the Contract.

Samples of specifications from previous similar projects are useful in this respect. The use of metric units is mandatory. Most specifications are normally written specially by the Procuring Entity or its representative to suit the Works at hand. There is no standard set of Specifications for universal application in all sectors in all regions, but there are established principles and practices, which are reflected in these PBDs.

There are considerable advantages in standardizing General Specifications for repetitive Works in recognized public sectors, such as highways, ports, railways, urban housing, irrigation, and water supply, in the same country or region where similar conditions prevail. The General Specifications should cover all classes of workmanship, materials, and equipment commonly involved in construction, although not necessarily to be used in a particular Works Contract. Deletions or addenda should then adapt the General Specifications to the particular Works.

Care must be taken in drafting specifications to ensure that they are not restrictive. In the specification of standards for goods, materials, and workmanship, recognized international standards should be used as much as possible. Where other particular standards are used, whether national standards or other standards, the specifications should state that goods, materials, and workmanship that meet other authoritative standards, and which ensure substantially equal or higher quality than the standards mentioned, will also be acceptable. The following clause may be inserted in the SCC.

Sample Clause: Equivalency of Standards and Codes

Wherever reference is made in the Contract to specific standards and codes to be met by the goods and materials to be furnished, and work performed or tested, the provisions of the latest current edition or revision of the relevant standards and codes in effect shall apply, unless otherwise expressly stated in the Contract. Where such standards and codes are national, or relate to a particular country or region, other authoritative standards that

ensure a substantially equal or higher quality than the standards and codes specified will be accepted subject to the Procuring Entity's Representative's prior review and written consent. Differences between the standards specified and the proposed alternative standards shall be fully described in writing by the Contractor and submitted to the Procuring Entity's Representative at least twenty-eight (28) days prior to the date when the Contractor desires the Procuring Entity's Representative's consent. In the event the Procuring Entity's Representative determines that such proposed deviations do not ensure substantially equal or higher quality, the Contractor shall comply with the standards specified in the documents.

These notes are intended only as information for the Procuring Entity or the person drafting the Bidding Documents. They should not be included in the final Bidding Documents.

Section VII. Drawings

[Insert here a list of Drawings. The actual Drawings, including site plans, should be attached to this section, or annexed in a separate folder.]

Section VIII. Bill of Quantities

Notes on the Bill of Quantities

Objectives

The objectives of the Bill of Quantities are:

- a. to provide sufficient information on the quantities of Works to be performed to enable Bids to be prepared efficiently and accurately; and
- b. when a Contract has been entered into, to provide a priced Bill of Quantities for use in the periodic valuation of Works executed.

In order to attain these objectives, Works should be itemized in the Bill of Quantities in sufficient detail to distinguish between the different classes of Works, or between Works of the same nature carried out in different locations or in other circumstances which may give rise to different considerations of cost. Consistent with these requirements, the layout and content of the Bill of Quantities should be as simple and brief as possible.

Daywork Schedule

A Daywork Schedule should be included only if the probability of unforeseen work, outside the items included in the Bill of Quantities, is high. To facilitate checking by the Entity of the realism of rates quoted by the Bidders, the Daywork Schedule should normally comprise the following:

- a. A list of the various classes of labor, materials, and Constructional Plant for which basic daywork rates or prices are to be inserted by the Bidder, together with a statement of the conditions under which the Contractor will be paid for work executed on a daywork basis.
- b. Nominal quantities for each item of Daywork, to be priced by each Bidder at Daywork rates as Bid. The rate to be entered by the Bidder against each basic Daywork item should include the Contractor's profit, overheads, supervision, and other charges.

Provisional Sums

A general provision for physical contingencies (quantity overruns) may be made by including a provisional sum in the Summary Bill of Quantities. Similarly, a contingency allowance for possible price increases should be provided as a provisional sum in the Summary Bill of Quantities. The inclusion of such provisional sums often facilitates budgetary approval by avoiding the need to request periodic supplementary approvals as the future need arises. Where such provisional sums or contingency allowances are used, the SCC should state the manner in which they will be used, and under whose authority (usually the Procuring Entity's Representative's).

The estimated cost of specialized work to be carried out, or of special goods to be supplied, by other contractors should be indicated in the relevant part of the Bill of Quantities as a particular provisional sum with an appropriate brief description. A separate procurement procedure is normally carried out by the Procuring Entity to select such specialized contractors. To provide an element of competition among the Bidders in respect of any facilities, amenities, attendance, etc., to be provided by the successful Bidder as prime Contractor for the use and convenience of the specialist contractors, each related provisional sum should be followed by an item in the Bill of Quantities inviting the Bidder to quote a sum for such amenities, facilities, attendance, etc.

Signature Box

A signature box shall be added at the bottom of each page of the Bill of Quantities where the authorized representative of the Bidder shall affix his signature. Failure of the authorized representative to sign each and every page of the Bill of Quantities shall be a cause for rejection of his bid.

These Notes for Preparing a Bill of Quantities are intended only as information for the Procuring Entity or the person drafting the Bidding Documents. They should not be included in the final documents.

Section IX. Checklist of Technical and Financial Documents

Notes on the Checklist of Technical and Financial Documents

The prescribed documents in the checklist are mandatory to be submitted in the Bid, but shall be subject to the following:

- a. GPPB Resolution No. 09-2020 on the efficient procurement measures during a State of Calamity or other similar issuances that shall allow the use of alternate documents in lieu of the mandated requirements; or
- b. any subsequent GPPB issuances adjusting the documentary requirements after the effectivity of the adoption of the PBDs.

The BAC shall be checking the submitted documents of each Bidder against this checklist to ascertain if they are all present, using a non-discretionary “pass/fail” criterion pursuant to Section 30 of the 2016 revised IRR of RA No. 9184.

Republic of the Philippines
BIDS AND AWARDS COMMITTEE
City Government of Pasig

Name of Bidder : _____
Name of Contract : _____
Approved Budget Contract : _____
Bidding Date : _____

(Note: Checklist is to be filled up by the BAC only)

I. TECHNICAL COMPONENT ENVELOPE FOR THE PROCUREMENT OF INFRASTRUCTURE PROJECTS

Class "A" Documents

Legal Documents

- (a) Valid PhilGEPS Certificate of Platinum Registration and Membership with additional caveat in accordance with Section 8.5.2 of the 2016 Revised IRR of RA 9184 amended through GPPB Resolution No. 15-2021, provided that all of Class "A" eligibility documents submitted to PhilGEPS are maintained and updated;

Technical Documents

- (b) Statement of the prospective bidder of all its ongoing government and private contracts, including contracts awarded but not yet started, if any, whether similar or not similar in nature and complexity to the contract to be bid; **and**
- (c) Statement of the bidder's Single Largest Completed Contract (SLCC) similar to the contract to be bid, except under conditions provided under the rules (Contractors under Small A and Small B categories without similar experience on the contract to be bid may be allowed to bid if the cost of such contract is not more than the Allowable Range of Contract Cost (ARCC) of their registration based on the guidelines as prescribed by the PCAB.); **and**
- (d) Special PCAB License in case of Joint Ventures; **and** registration for the type and cost of the contract to be bid; **and**
- (e) Original copy of Bid Security. If in the form of a Surety Bond, submit also a certification issued by the Insurance Commission; **or**
Original copy of Notarized Bid Securing Declaration; **and**
- (f) Project Requirements, which shall include the following:
- a. Organizational chart for the contract to be bid; **and**
- b. List of contractor's key personnel (e.g., Project Manager, Project Engineers, Materials Engineers, and Foremen), to be assigned to the contract to be bid, with their complete qualification and experience data; **and**
- c. Duly signed Manpower Schedule; **and**
- d. List of contractor's major equipment units, which are owned, leased, and/or under purchase agreements, supported by proof of ownership or certification of availability of equipment from the equipment lessor/vendor for the duration of the project, as the case may be; **and**
- e. Equipment utilization schedule; **and**
- f. Duly signed Construction Schedule (PERT/CPM) and S-curve; **and**
- g. Duly signed Construction Method in narrative form; **and**
- h. Construction Safety and Health Program; **and**
- (g) Original duly signed Omnibus Sworn Statement (OSS);

and if applicable, Original Notarized Secretary's Certificate in case of a corporation, partnership, or cooperative; or Original Special Power of Attorney of all members of the joint venture giving full power and authority to its officer to sign the OSS and do acts to represent the Bidder.

Financial Documents

- (h) The prospective bidder's computation of Net Financial Contracting Capacity (NFCC).

Class "B" Documents

- (i) If applicable, duly signed joint venture agreement (JVA) in accordance with RA No. 4566 and its IRR in case the joint venture is already in existence;
or
duly notarized statements from all the potential joint venture partners stating that they will enter into and abide by the provisions of the JVA in the instance that the bid is successful.

NOTE: Any missing document/s on the above mentioned checklist is a ground for outright disqualification/ rejection of the bid.

REMARKS: **PASSED** **FAILED**

ACKNOWLEDGMENT: (Please see above "note" Do not fill up/sign if documents are marked passed)
This is to acknowledge receipt of the first and second envelopes which is being returned because of disqualification due to deficiencies and non-compliance with checklist therein.

Signature over printed name/Representative of Bidder

Date Received

CHECKED AND VERIFIED BY:

SIGNATURE:

ATTY. JOSEPHINE C. LATI-BAGAOISAN
Chairperson

ATTY. DIEGO LUIS S. SANTIAGO
Vice Chairperson

DR. EMMA MEJIA-SANCHEZ
Member

DR. JEANNA V. PLES
Member

ENGR. JOHNNY L. CALATA
Member

MS. RUTH F. ROMANO
Member

DR. STUART G. SANTOS
Member

ATTY. KATHLEEN MAE M. VILLAMIN
Alternate Member

MR. JOSE REY Q. ESPINA
Alternate Member

ATTY. BERNICE C. MENDOZA
Alternate Member

ATTY. JOHNSON L. VILLARUEL
Alternate Member

ATTY. RAUL G. CORALDE
Alternate Member

Attested by:

ATTY. BEA THERESE P. VILLANUEVA
Officer-In-Charge, Procurement Management Office

**Republic of the Philippines
BIDS AND AWARDS COMMITTEE
City Government of Pasig**

Name of Bidder : _____
Name of Contract : _____
Approved Budget Contract: _____
Bidding Date : _____

(Note: Checklist is to be filled up by the BAC only)

II. FINANCIAL COMPONENT ENVELOPE FOR THE PROCUREMENT OF INFRASTRUCTURE PROJECTS

(j) Original of duly signed and accomplished Financial Bid Form; **and**

Other documentary requirements under RA No. 9184

(k) Original of duly signed Bid Prices in the Bill of Quantities; **and**

(l) Duly accomplished Detailed Estimates Form, including a summary sheet indicating the unit prices of construction materials, labor rates, and equipment rentals used in coming up with the Bid; **and**

(m) Cash Flow by Quarter.

NOTE:

Any missing document/s on the above-mentioned checklist is a ground for outright disqualification/ rejection of the bid.

REMARKS:

PASSED

FAILED

ACKNOWLEDGMENT: (Please see above "note" Do not fill up/sign if documents are marked passed)

This is to acknowledge receipt of the first and second envelopes which is being returned because of disqualification due to deficiencies and non-compliance with checklist therein.

Signature over printed name/Representative of Bidder

Date Received

CHECKED AND VERIFIED BY:

SIGNATURE:

ATTY. JOSEPHINE C. LATI-BAGAOISAN
Chairperson

ATTY. DIEGO LUIS S. SANTIAGO
Vice Chairperson

DR. EMMA MEJIA-SANCHEZ
Member

DR. JEANNA V. PLES
Member

ENGR. JOHNNY L. CALATA
Member

- MS. RUTH F. ROMANO**
Member _____
- DR. STUART G. SANTOS**
Member _____
- ATTY. KATHLEEN MAE M. VILLAMIN**
Alternate Member _____
- MR. JOSE REY Q. ESPINA**
Alternate Member _____
- ATTY. BERNICE C. MENDOZA**
Alternate Member _____
- ATTY. JOHNSON L. VILLARUEL**
Alternate Member _____
- ATTY. RAUL G. CORALDE**
Alternate Member _____

Attested by:

ATTY. BEA THERESE P. VILLANUEVA
Officer In Charge, Procurement Management Office

Omnibus Sworn Statement (Revised)

[shall be submitted with the Bid]

REPUBLIC OF THE PHILIPPINES)
CITY/MUNICIPALITY OF _____)S.S.

AFFIDAVIT

I, [Name of Affiant], of legal age, [Civil Status], [Nationality], and residing at [Address of Affiant], after having been duly sworn in accordance with law, do hereby depose and state that:

1. *[Select one, delete the other:]*

[If a sole proprietorship:] I am the sole proprietor or authorized representative of [Name of Bidder] with office address at [address of Bidder];

[If a partnership, corporation, cooperative, or joint venture:] I am the duly authorized and designated representative of [Name of Bidder] with office address at [address of Bidder];

2. *[Select one, delete the other:]*

[If a sole proprietorship:] As the owner and sole proprietor, or authorized representative of [Name of Bidder], I have full power and authority to do, execute and perform any and all acts necessary to participate, submit the bid, and to sign and execute the ensuing contract for [Name of the Project] of the [Name of the Procuring Entity], as shown in the attached duly notarized Special Power of Attorney;

[If a partnership, corporation, cooperative, or joint venture:] I am granted full power and authority to do, execute and perform any and all acts necessary to participate, submit the bid, and to sign and execute the ensuing contract for [Name of the Project] of the [Name of the Procuring Entity], as shown in the attached [state title of attached document showing proof of authorization (e.g., duly notarized Secretary's Certificate, Board/Partnership Resolution, or Special Power of Attorney, whichever is applicable)];

3. [Name of Bidder] is not "blacklisted" or barred from bidding by the Government of the Philippines or any of its agencies, offices, corporations, or Local Government Units, foreign government/foreign or international financing institution whose blacklisting rules have been recognized by the Government Procurement Policy Board, **by itself or by relation, membership, association, affiliation, or controlling interest with another blacklisted person or entity as defined and provided for in the Uniform Guidelines on Blacklisting;**

4. Each of the documents submitted in satisfaction of the bidding requirements is an authentic copy of the original, complete, and all statements and information provided therein are true and correct;

5. [Name of Bidder] is authorizing the Head of the Procuring Entity or its duly authorized representative(s) to verify all the documents submitted;

6. *[Select one, delete the rest:]*

[If a sole proprietorship:] The owner or sole proprietor is not related to the Head of the Procuring Entity, members of the Bids and Awards Committee(BAC), the Technical Working Group, and the BAC Secretariat, the head of the Project Management Office or the end-user unit, and the project consultants by consanguinity or affinity up to the third civil degree;

*[If a partnership or cooperative:]*None of the officers and members of *[Name of Bidder]* is related to the Head of the Procuring Entity, members of the Bids and Awards Committee (BAC), the Technical Working Group, and the BAC Secretariat, the head of the Project Management Office or the end-user unit, and the project consultants by consanguinity or affinity up to the third civil degree;

[If a corporation or joint venture:] None of the officers, directors, and controlling stockholders of *[Name of Bidder]* is related to the Head of the Procuring Entity, members of the Bids and Awards Committee(BAC),the Technical Working Group, and the BAC Secretariat, the head of the Project Management Office or the end-user unit, and the project consultants by consanguinity or affinity up to the third civil degree;

7. *[Name of Bidder]* complies with existing labor laws and standards; and
8. *[Name of Bidder]* is aware of and has undertaken the responsibilities as a Bidder in compliance with the Philippine Bidding Documents, which includes:
 - a. Carefully examining all of the Bidding Documents;
 - b. Acknowledging all conditions, local or otherwise, affecting the implementation of the Contract;
 - c. Making an estimate of the facilities available and needed for the contract to be bid, if any; and
 - d. Inquiring or securing Supplemental/Bid Bulletin(s) issued for the *[Name of the Project]*.
9. *[Name of Bidder]* did not give or pay directly or indirectly, any commission, amount, fee, or any form of consideration, pecuniary or otherwise, to any person or official, personnel or representative of the government in relation to any procurement project or activity.
10. **In case advance payment was made or given, failure to perform or deliver any of the obligations and undertakings in the contract shall be sufficient grounds to constitute criminal liability for Swindling (Estafa) or the commission of fraud with unfaithfulness or abuse of confidence through misappropriating or converting any payment received by a person or entity under an obligation involving the duty to deliver certain goods or services, to the prejudice of the public and the government of the Philippines pursuant to Article 315 of Act No. 3815 s. 1930, as amended, or the Revised Penal Code.**

IN WITNESS WHEREOF, I have hereunto set my hand this ___day of ___, 20__at _____, Philippines.

[Insert NAME OF BIDDER OR ITS AUTHORIZED REPRESENTATIVE]

[Insert signatory's legal capacity]

Affiant

[Jurat]

[Format shall be based on the latest Rules on Notarial Practice]

Bid Securing Declaration Form

[shall be submitted with the Bid if bidder opts to provide this form of bid security]

REPUBLIC OF THE PHILIPPINES)
CITY OF _____) S.S.

BID SECURING DECLARATION **Project Identification No.:*[Insert number]***

To:*[Insert name and address of the Procuring Entity]*

I/We, the undersigned, declare that:

1. I/We understand that, according to your conditions, bids must be supported by a Bid Security, which may be in the form of a Bid Securing Declaration.
2. I/We accept that: (a) I/we will be automatically disqualified from bidding for any procurement contract with any procuring entity for a period of two (2) years upon receipt of your Blacklisting Order; and, (b) I/we will pay the applicable fine provided under Section 6 of the Guidelines on the Use of Bid Securing Declaration, within fifteen (15) days from receipt of the written demand by the procuring entity for the commission of acts resulting to the enforcement of the bid securing declaration under Sections 23.1(b), 34.2, 40.1 and 69.1, except 69.1 (f), of the IRR of RA No.9184; without prejudice to other legal action the government may undertake.
3. I/We understand that this Bid Securing Declaration shall cease to be valid on the following circumstances:
 - a. Upon expiration of the bid validity period, or any extension there of pursuant to your request;
 - b. I am/we are declared ineligible or post-disqualified upon receipt of your notice to such effect, and (i) I/we failed to timely file a request for reconsideration or (ii) I/we filed a waiver to avail of said right; and
 - c. I am/we are declared the bidder with the Lowest Calculated Responsive Bid, and I/we have furnished the performance security and signed the Contract.

IN WITNESS WHEREOF, I/We have here unto set my/our hand/s this _____ day of *[month]* *[year]* at *[place of execution]*.

*[Insert NAME OF BIDDER OR ITS AUTHORIZED
REPRESENTATIVE]*

[Insert signatory's legal capacity]
Affiant

[Jurat]

[Format shall be based on the latest Rules on Notarial Practice]

Statement of All Ongoing Government and Private Contracts Including Contracts Awarded But Not Yet Started, If Any, Whether Similar or Not in Nature and Complexity to the Contract to be Bid

Business Name: _____

Business Address: _____

Name of the Contract and Project Location	a. Owner's Name b. Address c. Telephone Nos.	Nature of Work	Amount of Contract and Value of Outstanding Contract	a. Date of Contract b. Duration of the Contract c. Estimated Date of Completion	Bidder's Role		% of Accomplishment (based on latest % accomplishment report with a cut-off date of not earlier than October 2023)	
					Description	%	Planned	Actual
Ongoing								
Contracts Awarded But Not Yet Started								

--	--	--	--	--	--	--	--	--

Note: Bidder shall attach any of the following latest accomplishment report with a cut-off date of not earlier than October 2023, showing the percentages of planned and actual accomplishments:

- a. Statement of Work Accomplished showing the percentages of planned and actual accomplishments, or
- b. Updated Schedule Bar Chart with S-Curve, or
- c. Any similar report showing the percentages of planned and actual accomplishments of the project.

Said reports must be duly signed by the project owner or its representative. The absence of such document is a ground for disqualification of the Bidder.

Submitted by : _____
(Printed Name & Signature)

Designation : _____

Date : _____

Statement of Single Largest Completed Contract (SLCC)

(Similar to the contract to be bid, within the last five (5) years from the date of submission and receipt of bids, the value of which must be at least fifty percent (50%) of the ABC)

Business Name: _____

Business Address: _____

Name of the Contract	a. Owner's Name b. Address c. Telephone Nos.	Nature of Work	Amount of Contract	a. Date of Contract b. Duration of the Contract c. Date Completed	Bidder's Role		Total Contract Value at Completion
					Description	%	

Note: Attach a copy of the: 1) Notice of Award, Notice to Proceed, and/or official receipt(s); and 2) Certificate of Final Acceptance/Certificate of Satisfactory Completion. All the SLCC required documents should be issued by the client for the specified SLCC.

Submitted by : _____

(Printed Name & Signature)

Designation : _____

Date: : _____

NFCC COMPUTATION FOR ELIGIBILITY CHECK

A. Summary of the Applicant Supplier's/Distributor's/Manufacturer's assets and liabilities on the basis of the attached income tax return and audited financial statement, stamped "RECEIVED" by the Bureau of Internal Revenue or BIR authorized collecting agent, for the immediately preceding year and a certified copy of Schedule of Fixed Assets particularly the list of construction equipment.

	Year 20_____
1.Total Assets	
2.Current Assets	
3.Total Liabilities	
4.Current Liabilities	
5.Net Worth(1-3)	
6.Net Working Capital (2-4)	

B. The Net Financial Contracting Capacity (NFCC) based on the above data is computed as follows:

NFCC=[(Current assets minus current liabilities) (15)] minus the value of all outstanding or uncompleted portions of the projects under ongoing contracts, including awarded contracts yet to be started, coinciding with the contract to be bid.

The values of the domestic bidder's current assets and current liabilities shall be based on the latest Audited Financial Statements (AFS) submitted to the BIR.

NFCC=P_____


Submitted by:

Name of Supplier/ Distributor/ Manufacturer:

Signature of Authorized Representative:

Date:

MARKING AND SEALING OF BIDS

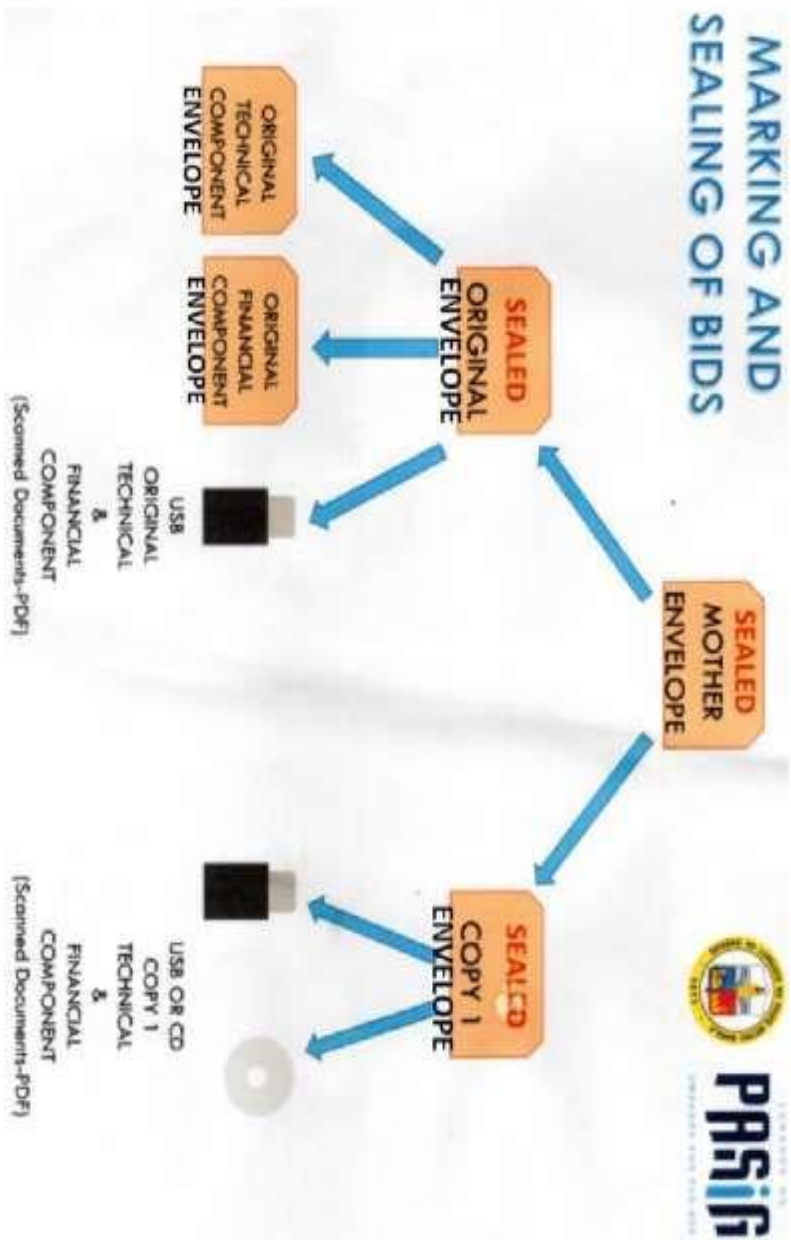

BID FORM

Date : _____

Project Identification No. : _____

To: **THE CHAIRMAN
BIDS AND AWARDS COMMITTEE
PASIG CITY**

Having examined the Philippine Bidding Documents (PBDs) including the Supplemental or Bid Bulletin Numbers _____ the receipt of which is hereby duly acknowledged, we, the undersigned, declare that:

a. We have no reservation to the PBDs, including the Supplemental or Bid Bulletins, for the Procurement Project: **PROPOSED EXPANSION WITH IMPROVEMENT WORKS AT PASIG CITY CHILDREN'S HOSPITAL, INDUSTRIA CORNER ALCALDE JOSE STS., BRGY. KAPASIGAN, PASIG CITY;**

b. We offer to execute the Works for this Contract in accordance with the PBDs;

c. The total price of our Bid in words and figures, excluding any discounts offered below is: _____
_____ (P _____)

d. The discounts offered and the methodology for their application are: _____;

e. The total bid price includes the cost of all taxes, such as, but not limited to: [specify the applicable taxes, e.g. (i) value added tax (VAT), (ii) income tax, (iii) local taxes, and (iv) other fiscal levies and duties], which are itemized herein and reflected in the detailed estimates,

f. Our Bid shall be valid within the a period stated in the PBDs, and it shall remain binding upon us at any time before the expiration of that period;

g. If our Bid is accepted, we commit to obtain a Performance Security in the amount of _____
_____ (P _____) percent of the Contract Price for the due performance of the Contract, or a Performance Securing Declaration in lieu of the allowable forms of Performance Security, subject to the terms and conditions of issued GPPB guidelines¹² for this purpose;

h. We are not participating, as Bidders, in more than one Bid in this bidding process, other than alternative offers in accordance with the Bidding Documents;

i. We understand that this Bid, together with your written acceptance thereof included in your notification of award, shall constitute a binding contract between us, until a formal Contract is prepared and executed; and

j. We understand that you are not bound to accept the Lowest Calculated Bid or any other Bid that you may receive.

k. We likewise certify/confirm that the undersigned, is the duly authorized representative of the bidder, and granted full power and authority to do, execute and perform any and all acts necessary to participate, submit the bid, and to sign and execute the ensuing contract for **PROPOSED EXPANSION WITH IMPROVEMENT WORKS AT PASIG CITY CHILDREN'S HOSPITAL, INDUSTRIA CORNER ALCALDE JOSE STS., BRGY. KAPASIGAN, PASIG CITY** of the **Bids and Awards Committee (B.A.C.) Pasig City**

l. We acknowledge that failure to sign each and every page of this Bid Form, including the Bill of Quantities, shall be a ground for the rejection of our bid.

Name: _____

Legal Capacity: _____

Signature: _____

Duly authorized to sign the Bid for and behalf of: _____

Date: _____

SUBJECT : **BILL OF QUANTITIES / COST ESTIMATE**

NAME OF PROJECT : **PROPOSED EXPANSION WITH IMPROVEMENT WORKS**

LOCATION : **PASIG CITY CHILDREN'S HOSPITAL, INDUSTRIA CORNER ALCALDE JOSE STS.,
BRGY. KAPASIGAN, PAISG CITY**

ITEM NO.	DESCRIPTION	QUANTITY	UNIT	UNIT PRICE (P)	AMOUNT (P)
1.0	Mobilization / Demobilization <hr/> <small>(Pesos</small> <hr/> <small>)</small>	1.00	lot		
2.0	Preliminaries <hr/> <small>(Pesos</small> <hr/> <small>)</small>	1.00	l.s		
3.0	Repair and Improvement at Basement <hr/> <small>(Pesos</small> <hr/> <small>)</small>	1.00	l.s		
4.0	Repair and Improvement of Ramp <hr/> <small>(Pesos</small> <hr/> <small>)</small>	1.00	l.s		
5.0	Repair and Improvement at Ground Floor <hr/> <small>(Pesos</small> <hr/> <small>)</small>	1.00	l.s		
6.0	Repair and Improvement Work at Second Floor <hr/> <small>(Pesos</small> <hr/> <small>)</small>	1.00	l.s		
7.0	Repair and Improvement Work at Third Floor <hr/> <small>(Pesos</small> <hr/> <small>)</small>	1.00	l.s		
Total Amount in Words: _____					
GRAND TOTAL					

(Name & Address of Bidder)

(Signature)

(Name, Designation of Authorized Signing Official)

SUBJECT : **BILL OF QUANTITIES / COST ESTIMATE**

NAME OF PROJECT : **PROPOSED EXPANSION WITH IMPROVEMENT WORKS**

LOCATION : **PASIG CITY CHILDREN'S HOSPITAL, INDUSTRIA CORNER ALCALDE JOSE STS.,
BRGY. KAPASIGAN, PAISG CITY**

ITEM NO.	DESCRIPTION	QUANTITY	UNIT	UNIT PRICE (P)	AMOUNT (P)
8.0	Repair and Improvement Work at Fourth Floor <hr/> (Pesos <hr/>)	1.00	l.s		
9.0	Repair and Improvement Work at Fifth Floor <hr/> (Pesos <hr/>)	1.00	l.s		
10.0	Repair and Improvement Work at Sixth Floor <hr/> (Pesos <hr/>)	1.00	l.s		
11.0	Repair and Improvement Work at Lower Roof Deck <hr/> (Pesos <hr/>)	1.00	l.s		
12.0	Repair and Improvement Work at Upper Roof Deck <hr/> (Pesos <hr/>)	1.00	l.s		
13.0	Rehabilitation of Public Toilet <hr/> (Pesos <hr/>)	1.00	l.s		
14.0	Exterior Painting <hr/> (Pesos <hr/>)	39.00	pcs		
Total Amount in Words: _____					
GRAND TOTAL					

(Name & Address of Bidder)

(Signature)

(Name, Designation of Authorized Signing Official)

SUBJECT : **BILL OF QUANTITIES / COST ESTIMATE**

NAME OF PROJECT : **PROPOSED EXPANSION WITH IMPROVEMENT WORKS**

LOCATION : **PASIG CITY CHILDREN'S HOSPITAL, INDUSTRIA CORNER ALCALDE JOSE STS.,
BRGY. KAPASIGAN, PAISG CITY**

ITEM NO.	DESCRIPTION	QUANTITY	UNIT	UNIT PRICE (P)	AMOUNT (P)
15.0	Rehabilitation of Staircase 1 and 2 <hr/> (Pesos <hr/>)	1.00	l.s		
16.0	Counter Windows, Doors and Windows <hr/> (Pesos <hr/>)	1.00	l.s		
17.0 17.1	Medical Gas Piping Basement and Ground Floor <hr/> (Pesos <hr/>)	1.00	l.s		
17.2	Second Floor and Fourth Floor <hr/> (Pesos <hr/>)	1.00	l.s		
17.3	Fifth to Sevent Floor <hr/> (Pesos <hr/>)	1.00	l.s		
17.4	Medical Gas Source Equipment <hr/> (Pesos <hr/>)	1.00	l.s		
17.5	Labor and Supervision <hr/> (Pesos <hr/>)	1.00	l.s		
Total Amount in Words: _____					
GRAND TOTAL					

(Name & Address of Bidder)

(Signature)

**(Name, Designation of Authorized
Signing Official)**

SUBJECT : **BILL OF QUANTITIES / COST ESTIMATE**

NAME OF PROJECT : **PROPOSED EXPANSION WITH IMPROVEMENT WORKS**

LOCATION : **PASIG CITY CHILDREN'S HOSPITAL, INDUSTRIA CORNER ALCALDE JOSE STS.,
BRGY. KAPASIGAN, PAISG CITY**

ITEM NO.	DESCRIPTION	QUANTITY	UNIT	UNIT PRICE (P)	AMOUNT (P)
18.0 18.1	Plumbing Works Sewer Lines (Pesos _____ _____)	1.00	l.s		
18.2	Sewer Lines (Pesos _____ _____)	1.00	l.s		
18.3	Repair of Water Lines (Pesos _____ _____)	1.00	l.s		
18.4	Plumbing Fixtures (Pesos _____ _____)	1.00	l.s		
19.0 19.1 19.1.1	Electrical and Mechanical Works Electrical Works Panel Board and Breakers (Pesos _____ _____)	1.00	l.s		
19.1.2	Wires, Conduits and Boxes (Pesos _____ _____)	1.00	l.s		
19.1.3	Fixtures and Wiring Devices (Pesos _____ _____)	1.00	l.s		
Total Amount in Words: _____					
GRAND TOTAL					

(Name & Address of Bidder)

(Signature)

**(Name, Designation of Authorized
Signing Official)**

SUBJECT : **BILL OF QUANTITIES / COST ESTIMATE**

NAME OF PROJECT : **PROPOSED EXPANSION WITH IMPROVEMENT WORKS**

LOCATION : **PASIG CITY CHILDREN'S HOSPITAL, INDUSTRIA CORNER ALCALDE JOSE STS.,
BRGY. KAPASIGAN, PAISG CITY**

ITEM NO.	DESCRIPTION	QUANTITY	UNIT	UNIT PRICE (P)	AMOUNT (P)
19.2 19.2.1	Mechanical Works Aircon Works (Pesos _____)	1.00	l.s		
19.2.1.2	Refrigerant Works (Pesos _____)	1.00	l.s		
19.2.1.3	Electrical Works of Aircon Units (Pesos _____)	1.00	l.s		
19.2.2 19.2.2.1	Auxiliary System FDAS (Fire Detection and Alarm System) (Pesos _____)	1.00	l.s		
19.2.2.2	CCTV (Closed Circuit Television) System (Pesos _____)	1.00	l.s		
19.2.2.3	Public Address and Background Music System (Pesos _____)	1.00	l.s		
19.2.2.4	BMS (Building Management System) (Pesos _____)	1.00	unit		
	Total Amount in Words: _____				
	GRAND TOTAL				

(Name & Address of Bidder)

(Signature)

(Name, Designation of Authorized Signing Official)

SUBJECT : **BILL OF QUANTITIES / COST ESTIMATE**

NAME OF PROJECT : **PROPOSED EXPANSION WITH IMPROVEMENT WORKS**


LOCATION : **PASIG CITY CHILDREN'S HOSPITAL, INDUSTRIA CORNER ALCALDE JOSE STS.,
BRGY. KAPASIGAN, PAISG CITY**

ITEM NO.	DESCRIPTION	QUANTITY	UNIT	UNIT PRICE (P)	AMOUNT (P)
20.0	Electric Motor Pumps and Fire Protection System (Pesos)	1.00	ls		
Total Amount in Words: _____					
GRAND TOTAL					


(Name & Address of Bidder)

(Signature)



(Name, Designation of Authorized Signing Official)

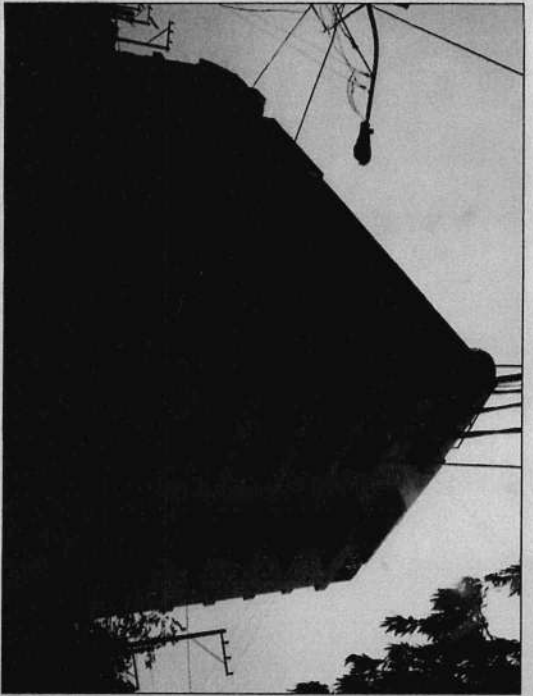

ACTUAL PHOTO

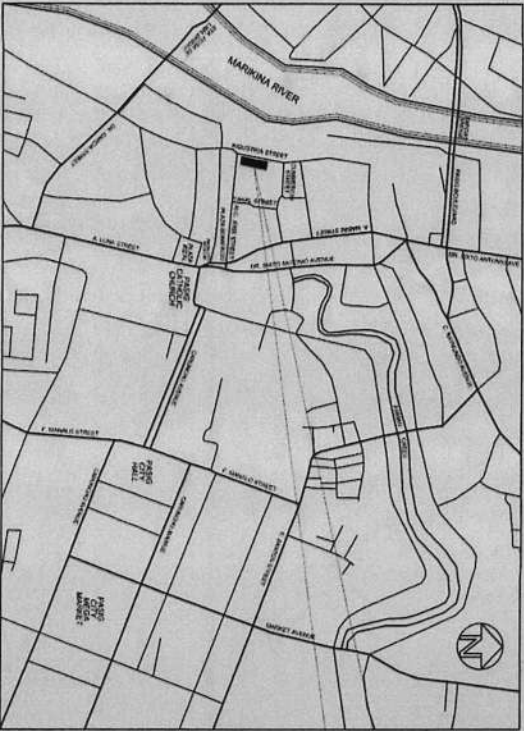

VICINITY MAP

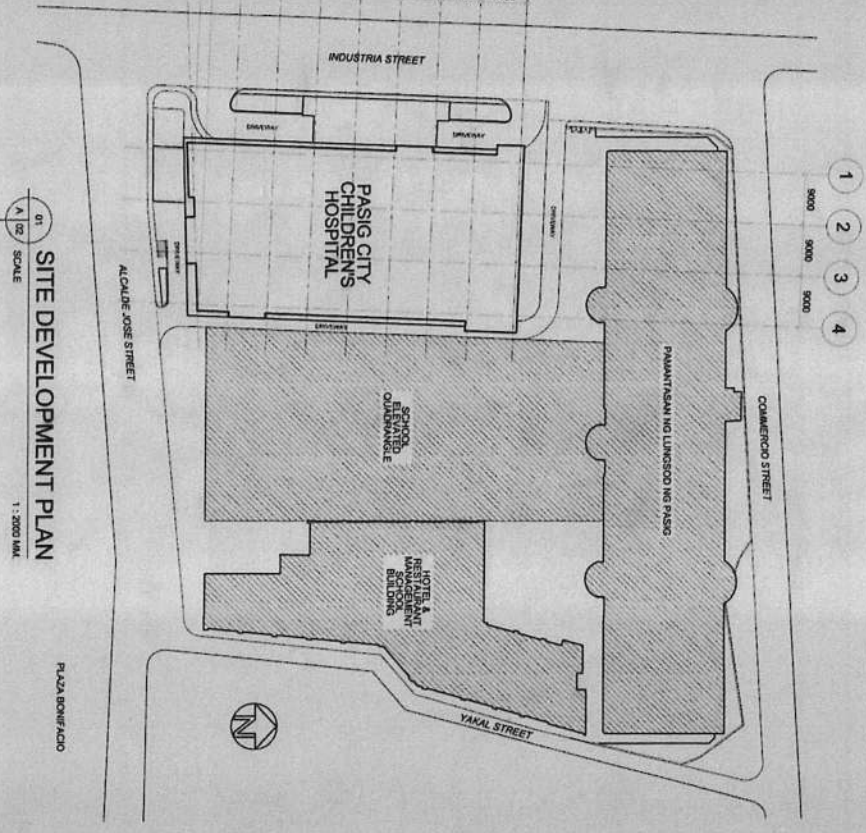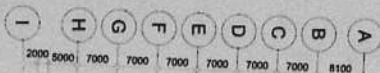


SITE DEVELOPMENT PLAN
1:2000 S.M.


COMPILED BY:
DR. JOSE LITO T. MORETE
MEDICAL DIRECTOR, PCH

APPROVED BY:
DR. NENSISA G. SABARRE
PASIG CITY COMMUNITY HEALTH OFFICER

	PROJECT TITLE: PROPOSED EXPANSION W/ IMPROVEMENT WORKS AT PASIG CITY CHILDREN'S HOSPITAL	ARCHITECTURAL: ARCH. LEVI O. OLVAR CHIEF ARCHITECTURAL SECTION ARCH. ELMER C. ESTRADA ARCHITECT	PROGRAMMING & CONSTRUCTION: ENGR. JEREMY R. RANESSES CHIEF ENGINEERING PROJECTS ENGR. JIMMY R. DELA CRUZ ENGR. ROBERTO T. MENDOZA ENGR. JEREMY R. RANESSES ENGR. ROBERTO T. MENDOZA	RECOMMENDING APPROVAL: ENGR. LAMBERTO B. PRUDENCIO ENGR. ARTAVARDES V. GERONIMO O.C. ENGINEERING DEPARTMENT	APPROVED BY: VICTOR M. REGIS N. SOTTO CITY MAJOR	SHEET CONTENTS: ACTUAL PHOTO VICINITY MAP SITE DEVELOPMENT PLAN CADD ECESTRADA	SHEET NO.: A 01 39
	LOCATION: INDUSTRIA COR. AL CALLE JOSE STS. PASIG CITY	1. TO BE USED FOR THE PROPOSED EXPANSION W/ IMPROVEMENT WORKS AT PASIG CITY CHILDREN'S HOSPITAL. 2. FOR THE PROPOSED EXPANSION W/ IMPROVEMENT WORKS AT PASIG CITY CHILDREN'S HOSPITAL. 3. FOR THE PROPOSED EXPANSION W/ IMPROVEMENT WORKS AT PASIG CITY CHILDREN'S HOSPITAL. 4. APPROXIMATION OF THE INSTRUMENT SHALL BE CONNECTED AT THE EXPENSE OF THE CONTRACTOR. 5. THIS SITE DEVELOPMENT PLAN IS FOR INFORMATION ONLY. IT DOES NOT CONSTITUTE A CONTRACT. THE CONTRACTOR SHALL BE RESPONSIBLE FOR THE PROPOSED EXPANSION W/ IMPROVEMENT WORKS AT PASIG CITY CHILDREN'S HOSPITAL. 6. THE PROPOSED EXPANSION W/ IMPROVEMENT WORKS AT PASIG CITY CHILDREN'S HOSPITAL.	APPROVALS: 1. GOVERNMENT CORP. SHALL BE BASED ON APPROVED PLAN & SPECIAL CONTRACT. 2. NO. 1. APPROVED CONTRACT. APPROVED CONTRACT. APPROVED CONTRACT. APPROVED CONTRACT. 3. THE PROPOSED EXPANSION W/ IMPROVEMENT WORKS AT PASIG CITY CHILDREN'S HOSPITAL.				

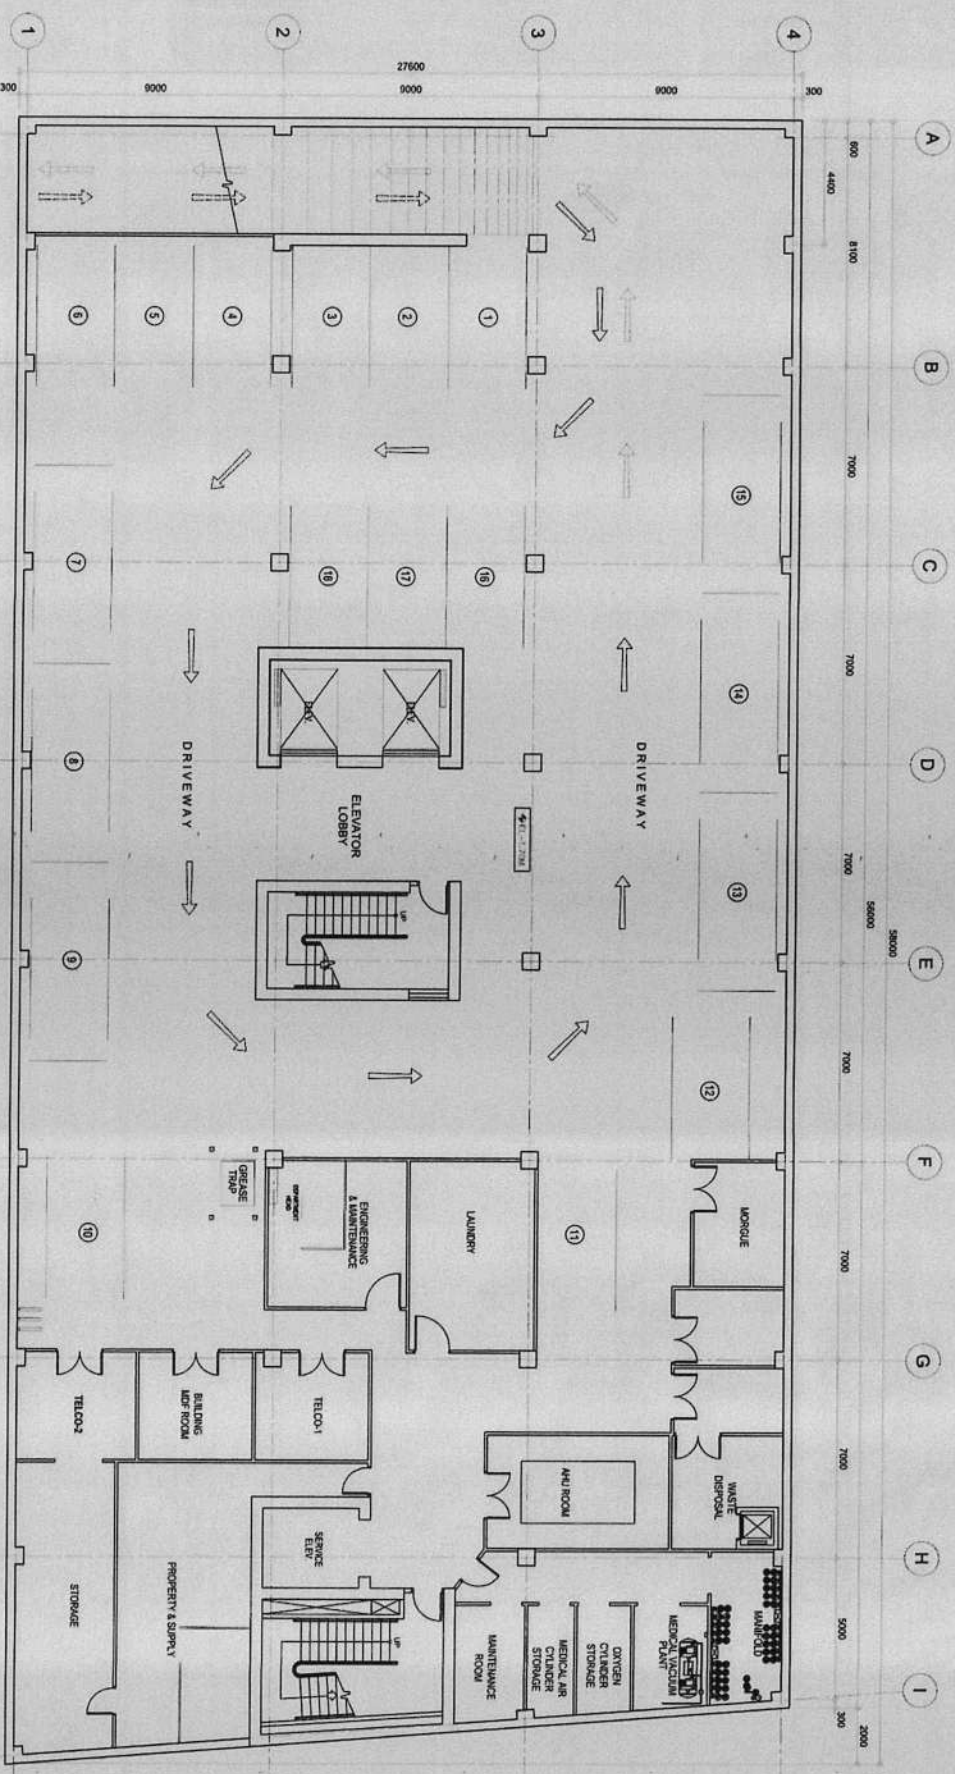


01
A I 02
SCALE
EXISTING BASEMENT FLOOR PLAN
1 : 100 MM

 <p>REPUBLIC OF THE PHILIPPINES CITY OF PASIG OFFICE OF THE MAYOR ENGINEERING DEPARTMENT</p>	<p>PROJECT TITLE: PROPOSED EXPANSION W/ IMPROVEMENT WORKS AT PASIG CITY CHILDREN'S HOSPITAL</p> <p>LOCATION: INDUSTRIAL COR. ALAYUE JOSE STS. PASIG CITY</p>	<p>ARCHITECTURAL: ARCH. LEY V. OLIVAR City of Pasig ARCH. EDUARDO ESTRADA Architect</p>	<p>PROGRAMMING & CONSTRUCTION: ENGR. RENE R. RAVERES City of Pasig ENR. RAFAEL REYES City of Pasig ENR. JOSE A. DE VERA City of Pasig</p>	<p>RECOMMENDING APPROVAL: ENGR. ANTONIO BRINDENCO City of Pasig ENR. ANTONIO V. GERONIMO City of Pasig</p>	<p>APPROVED BY: VICTOR M. REGIS N. SOTTO City Mayor</p>	<p>SHEET CONTENTS: SHEETING: ENGINEERING FLOOR PLAN 02 39 A</p>
---	--	---	--	--	--	--

IMPORTANT NOTES:

1. THIS FLOOR PLAN IS BASED ON THE EXISTING FLOOR PLAN AND THE INFORMATION PROVIDED BY THE ARCHITECT AND THE OWNER.
2. IN ANY CASE, THE CONTRACTOR SHALL BE RESPONSIBLE FOR VERIFYING THE EXISTING CONDITIONS OF THE PROJECT AND THE INFORMATION PROVIDED BY THE ARCHITECT AND THE OWNER.
3. IN CASE OF DISCREPANCY BETWEEN THE ARCHITECT'S DRAWINGS AND THE INFORMATION PROVIDED BY THE ARCHITECT AND THE OWNER, THE ARCHITECT'S DRAWINGS SHALL PREVAIL.
4. THE CONTRACTOR SHALL BE RESPONSIBLE FOR VERIFYING THE EXISTING CONDITIONS OF THE PROJECT AND THE INFORMATION PROVIDED BY THE ARCHITECT AND THE OWNER.

02. THE PROVISION OF WORK IS FROM ARCHITECTURAL PURPOSES ONLY.

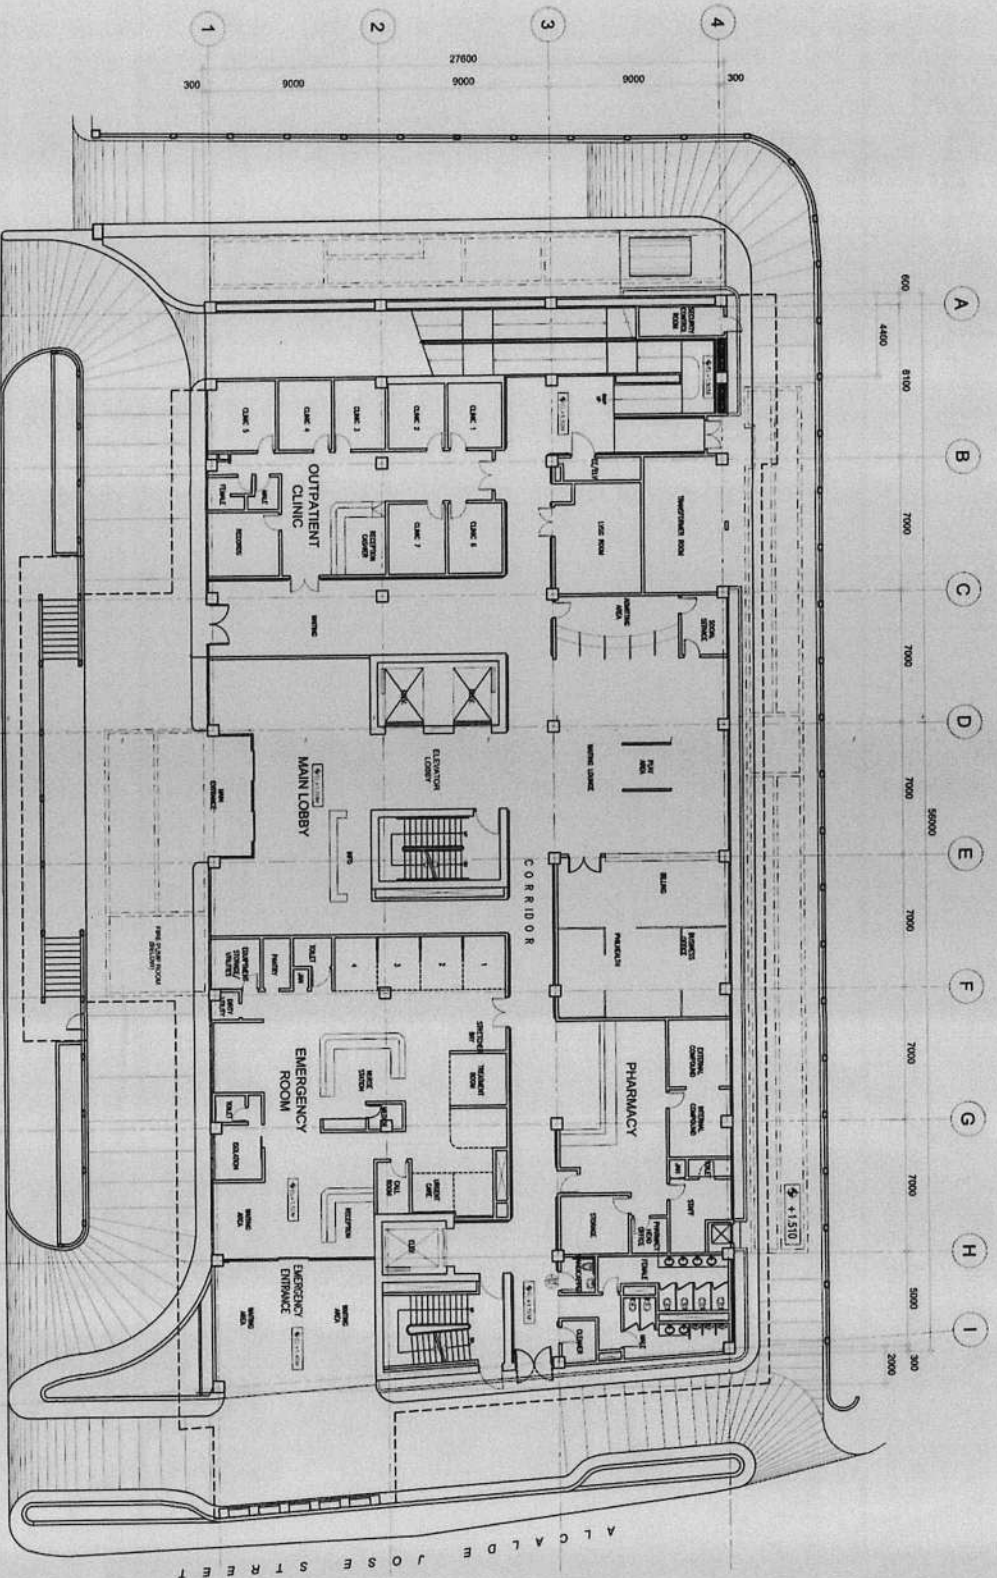


INDUSTRIA STREET
EXISTING GROUND FLOOR PLAN
SCALE: 1/8" = 1'-0"

<p>REPUBLIC OF THE PHILIPPINES CITY OF PASIG OFFICE OF THE MAYOR ENGINEERING DEPARTMENT</p>	<p>PROJECT TITLE: PROPOSED EXPANSION W/ IMPROVEMENT WORKS AT PASIG CITY CHILDREN'S HOSPITAL</p> <p>LOCATION: INDUSTRIAL COR. AL CALDE JOSE STS. NO. 100</p>	<p>ARCHITECTURAL: ARCH. LEYLA OLIVAR ARCHITECT ARCH. EDUARDO ESTRADA ARCHITECT</p>	<p>PROGRAMMING & CONSTRUCTION: ENGR. JESSE PARRALES PROGRAMMER ENGR. JUAN L. FERRIZ ENGR. SUPERVISOR ENGR. JONAS A. MENDOZA ENGR. SUPERVISOR</p>	<p>RECOMMENDING APPROVAL: ENGR. MARICELINA S. BRUDENIO ENGR. SUPERVISOR ENGR. ARTAVERTES V. GERONIMO D.I.C. ENGINEERING DEPARTMENT</p>	<p>APPROVED BY: VICTOR W. REGIS N. SOTTO CITY MAYOR</p>	<p>SHEET CONTENTS: EXISTING GROUND FLOOR PLAN</p> <p>SHEET NO.: A 04 / 39</p>
---	--	--	---	--	--	--

IMPORTANT NOTES:

1. FOR ALL STRUCTURE IN THIS PLAN, THE CONSTRUCTION SHALL BE IN ACCORDANCE WITH THE PROVISIONS OF THE NATIONAL BUILDING CODE AND THE PROVISIONS OF THE PASIG CITY ENGINEERING DEPARTMENT.
2. IN ANY CASE, THE CONSTRUCTION SHALL BE IN ACCORDANCE WITH THE PROVISIONS OF THE NATIONAL BUILDING CODE AND THE PROVISIONS OF THE PASIG CITY ENGINEERING DEPARTMENT.
3. THE OWNER SHALL BE RESPONSIBLE FOR THE OBTAINMENT OF ALL NECESSARY PERMITS AND APPROVALS FROM THE APPROPRIATE AGENCIES AND OFFICIALS.
4. THE CONTRACTOR SHALL BE RESPONSIBLE FOR THE OBTAINMENT OF ALL NECESSARY PERMITS AND APPROVALS FROM THE APPROPRIATE AGENCIES AND OFFICIALS.
5. THE CONTRACTOR SHALL BE RESPONSIBLE FOR THE OBTAINMENT OF ALL NECESSARY PERMITS AND APPROVALS FROM THE APPROPRIATE AGENCIES AND OFFICIALS.

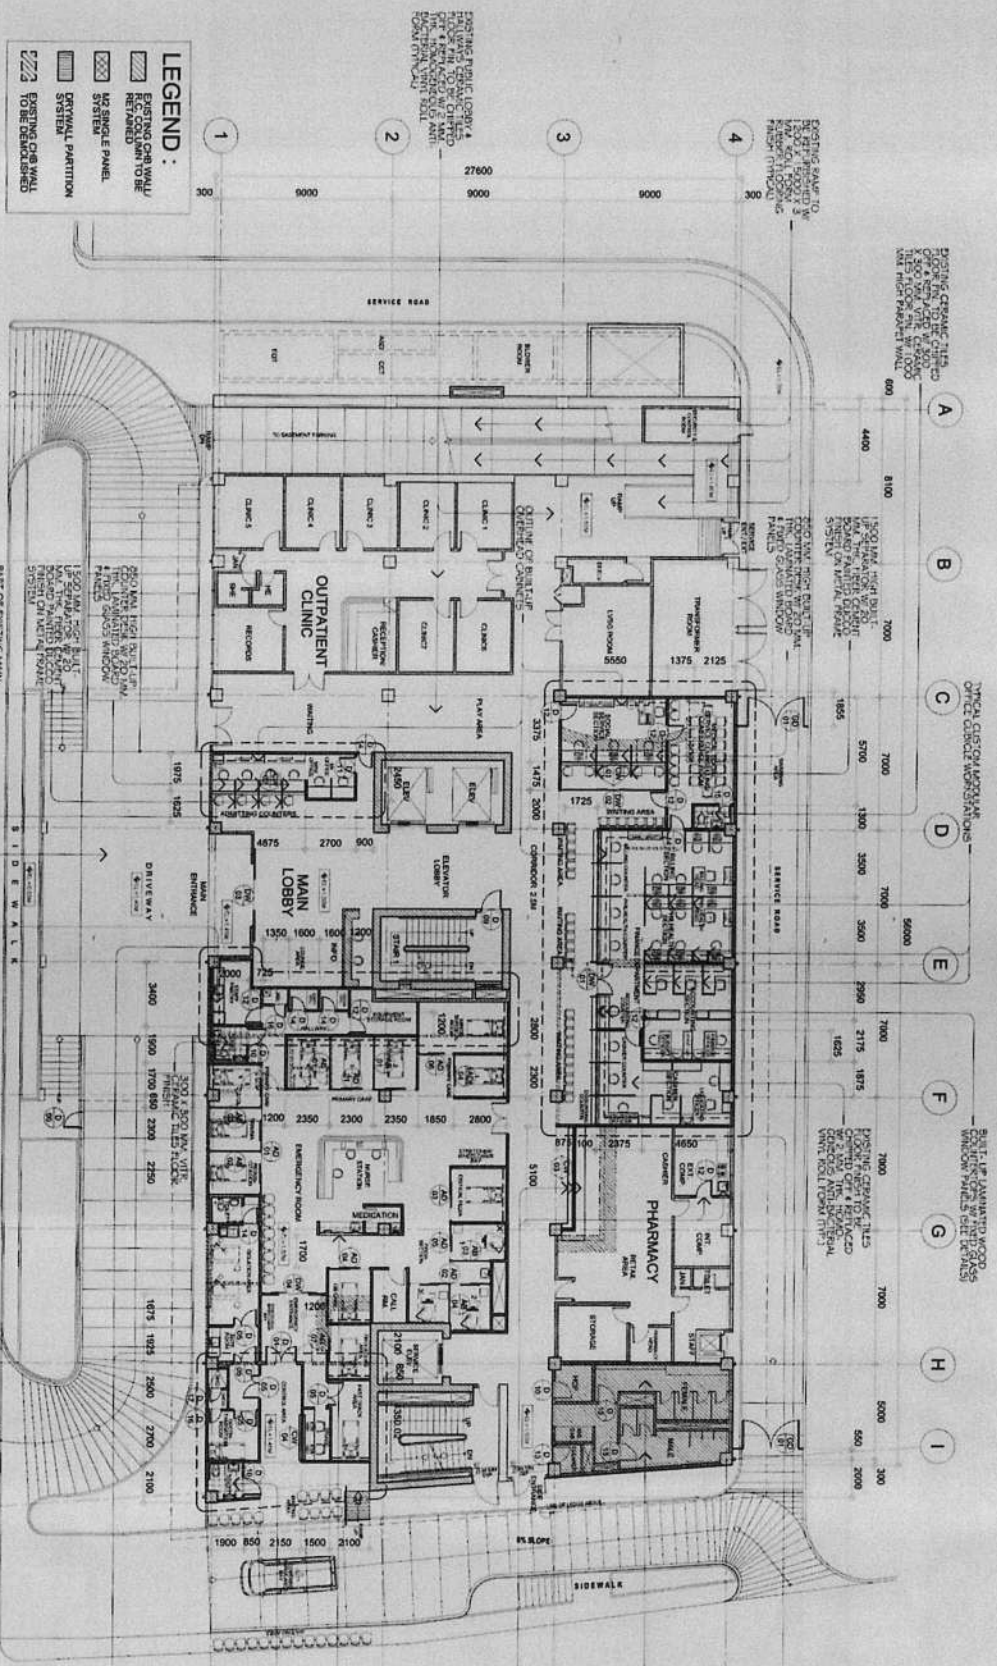

LEGEND :

- EXISTING CBW WALL TO BE RETAINED
- NO SINGLE PANEL
- EXISTING CBW WALL TO BE DEMOLISHED
- EXISTING CBW WALL TO BE DEMOLISHED

WITH PROPOSED REPAIR WORKS
EXISTING GROUND FLOOR PLAN
 SCALE: 1:150 (A1)



REPUBLIC OF THE PHILIPPINES
 CITY OF PASIG
 OFFICE OF THE MAYOR
 ENGINEERING DEPARTMENT

PROJECT TITLE:
**PROPOSED EXPANSION W/
 IMPROVEMENT WORKS AT
 PASIG CITY CHILDREN'S HOSPITAL**

ARCHITECTURAL:
 ARCHITECT: **ARCH. ELMER C. ESTRADA**

PROGRAMMING & CONSTRUCTION:
 ENGR. ISMAEL M. ALBERES

RECOMMENDING APPROVAL:
 ENGR. JOSE M. TRINIDAD

APPROVED BY:
VICTOR MATTHEW R. SOTTO
 CITY MAYOR

SHEET CONTENTS:
 SHEET NO.: **A**
05/39

REMARKS/NOTES:

1. THIS DRAWING IS THE PROPERTY OF THE ARCHITECT. IT IS TO BE USED ONLY FOR THE PROJECT AND SITE SPECIFICALLY IDENTIFIED THEREON.
2. PARTIAL CONSTRUCTION OF THE PROPOSED EXPANSION AND IMPROVEMENT WORKS SHALL BE CONSIDERED AS A SEPARATE PROJECT AND SHALL BE APPROVED BY THE ENGINEERING DEPARTMENT.
3. THE USE OF THIS DRAWING FOR ANY OTHER PROJECT OR FOR ANY OTHER PURPOSE WITHOUT THE WRITTEN PERMISSION OF THE ARCHITECT IS STRICTLY PROHIBITED.
4. APPROVAL OF THIS DRAWING SHALL BE CONSIDERED AS THE APPROVAL OF THE ARCHITECT.
5. THIS DRAWING IS THE PROPERTY OF THE ARCHITECT. IT IS TO BE USED ONLY FOR THE PROJECT AND SITE SPECIFICALLY IDENTIFIED THEREON.
6. THE PROVISION OF WORKS IS FOR INFORMATION ONLY.



REPUBLIC OF THE PHILIPPINES
 OFFICE OF THE MAYOR
 CITY OF PASIG
 ENGINEERING DEPARTMENT

PROJECT TITLE:
**PROPOSED EXPANSION W/
 IMPROVEMENT WORKS AT
 PASIG CITY CHILDREN'S HOSPITAL**

ARCHITECTURAL:
 ARCH. **EVAN OLIVAR**
 CHIEF ARCHITECTURAL SECTION
 ARCH. **EDMUND ESTRADA**
 ARCHITECT

PROGRAMMING & CONSTRUCTION:
 ENGR. **ISIDORO RAMIREZ**
 CHIEF OF PROJECTS
 ENGR. **ANDREW REBER**
 PROJECT MANAGER


RECOMMENDING APPROVAL:
 ENGR. **FRUDESCO**
 CHIEF ENGINEERING DEPARTMENT
 ENGR. **ARTAVARDES Y GERONIMO**
 O.I.C. ENGINEERING DEPARTMENT

APPROVED BY:
VICTOR MAX REGIS N. SOTTO
 CITY MAYOR


SHEET CONTENTS:
 EXISTING SECOND FLOOR PLAN
 CHD ECESTRADA

SHEET NO. 1:
A
06 39

IMPORTANT NOTES:
 1. NO PART OF THIS PLAN SHALL BE USED FOR ANY OTHER PROJECT WITHOUT THE WRITTEN PERMISSION OF THE ARCHITECT.
 2. FOR ALL WORKS TO BE DONE IN ACCORDANCE WITH THE CITY ENGINEERING DEPARTMENT'S STANDARDS AND SPECIFICATIONS.
 3. IN CASE OF ANY DISCREPANCY BETWEEN THIS PLAN AND ANY OTHER DOCUMENTS, THIS PLAN SHALL PREVAIL.
 4. ANY MODIFICATION OF THIS INSTRUCTION SHALL BE CORRECTED AT THE EXPENSE OF THE CONTRACTOR.
 5. PROJECT TO BE COMPLETED WITHIN THE SPECIFIED PERIOD.
 6. CONSTRUCTION SHALL PROCEED ON THE BASIS OF THIS PLAN.
 7. GOVERNING CODES WILL BE BASED ON APPROVED PLANS & SPECIFICATIONS.
 8. NO PART OF THIS PLAN SHALL BE USED FOR ANY OTHER PROJECT WITHOUT THE WRITTEN PERMISSION OF THE ARCHITECT.
 9. THE PRESENCE OF WORKS IS FOR ILLUSTRATIVE PURPOSES ONLY.

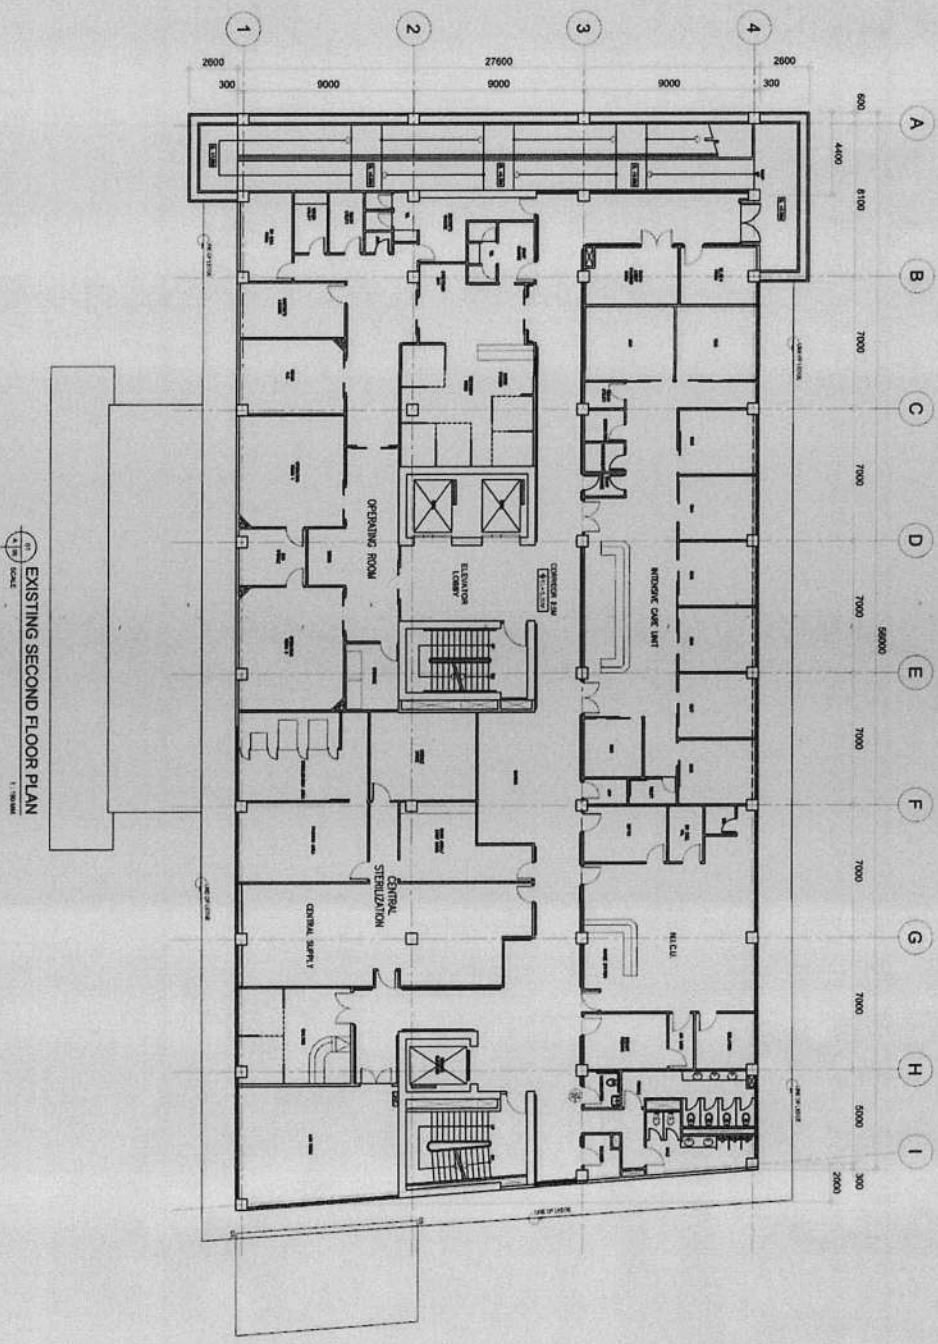

EXISTING SECOND FLOOR PLAN
 1:1000 SCALE

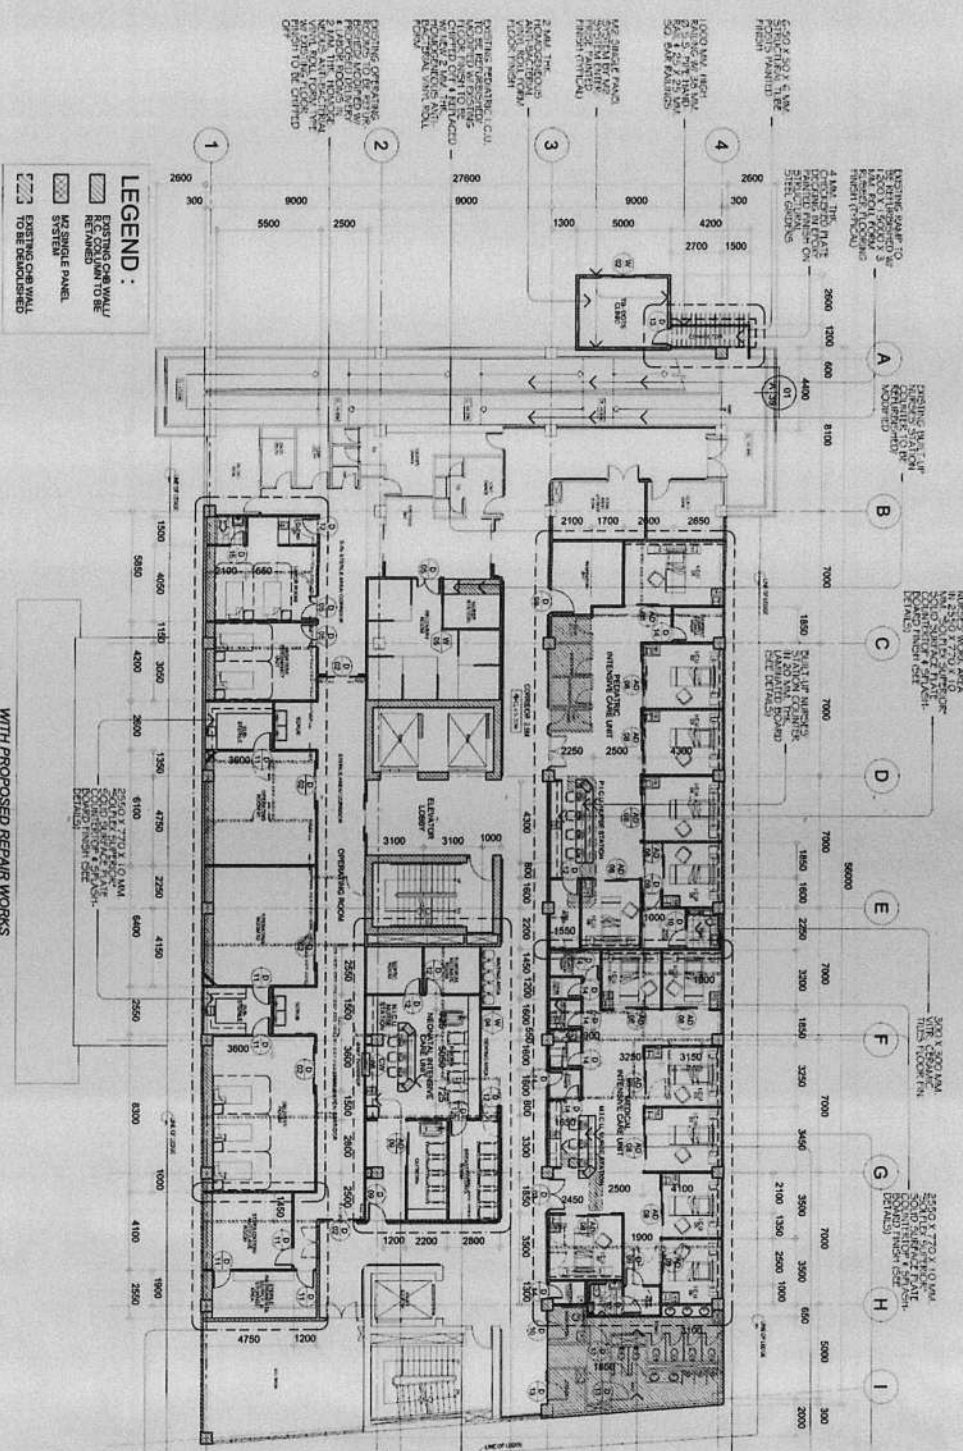

WITH PROPOSED REPAIR WORKS
EXISTING SECOND FLOOR PLAN
SCALE 1/8" = 1'-0"

LEGEND:
 [Symbol] EXISTING CURB WALL TO BE RETAINED
 [Symbol] NEW SINGLE PANEL
 [Symbol] EXISTING CURB WALL TO BE DEMOLISHED



REPUBLIC OF THE PHILIPPINES
 OFFICE OF THE MAYOR
 ENGINEERING DEPARTMENT

PROJECT TITLE:
**PROPOSED EXPANSION W/
 IMPROVEMENT WORKS AT
 PASIG CITY CHILDREN'S HOSPITAL**

ARCHITECTURAL:
 ARCH. ELEANOR OLIVAR
 CHIEF ARCHITECTURAL DESIGNER
 ARCH. ELMER ESTRAÑA
 ARCHITECT

PROGRAMMING & CONSTRUCTION:
 ENGR. ISABEL BRANDES
 ENGR. JUAN DELA CRUZ
 ENGR. ROBERTO A. JACOB


RECOMMENDING APPROVAL:
 ENGR. JUAN DELA CRUZ
 ENGR. ROBERTO A. JACOB

APPROVED BY:
 ENGR. ARTAVARES Y GERONIMO
 O.P.C. ENGINEERING BEHAVIOR

APPROVED BY:
 VICTOR MAE REGIS Y SOTTO
 CITY MAYOR

SHEET CONTENTS:
 SHEET NO. 07/39


1. THE CONTRACTOR SHALL BE RESPONSIBLE FOR THE DESIGN OF THE STRUCTURE.
 2. THE CONTRACTOR SHALL BE RESPONSIBLE FOR THE DESIGN OF THE STRUCTURE.
 3. THE CONTRACTOR SHALL BE RESPONSIBLE FOR THE DESIGN OF THE STRUCTURE.
 4. THE CONTRACTOR SHALL BE RESPONSIBLE FOR THE DESIGN OF THE STRUCTURE.
 5. THE CONTRACTOR SHALL BE RESPONSIBLE FOR THE DESIGN OF THE STRUCTURE.
 6. THE CONTRACTOR SHALL BE RESPONSIBLE FOR THE DESIGN OF THE STRUCTURE.
 7. THE CONTRACTOR SHALL BE RESPONSIBLE FOR THE DESIGN OF THE STRUCTURE.
 8. THE CONTRACTOR SHALL BE RESPONSIBLE FOR THE DESIGN OF THE STRUCTURE.
 9. THE CONTRACTOR SHALL BE RESPONSIBLE FOR THE DESIGN OF THE STRUCTURE.
 10. THE CONTRACTOR SHALL BE RESPONSIBLE FOR THE DESIGN OF THE STRUCTURE.

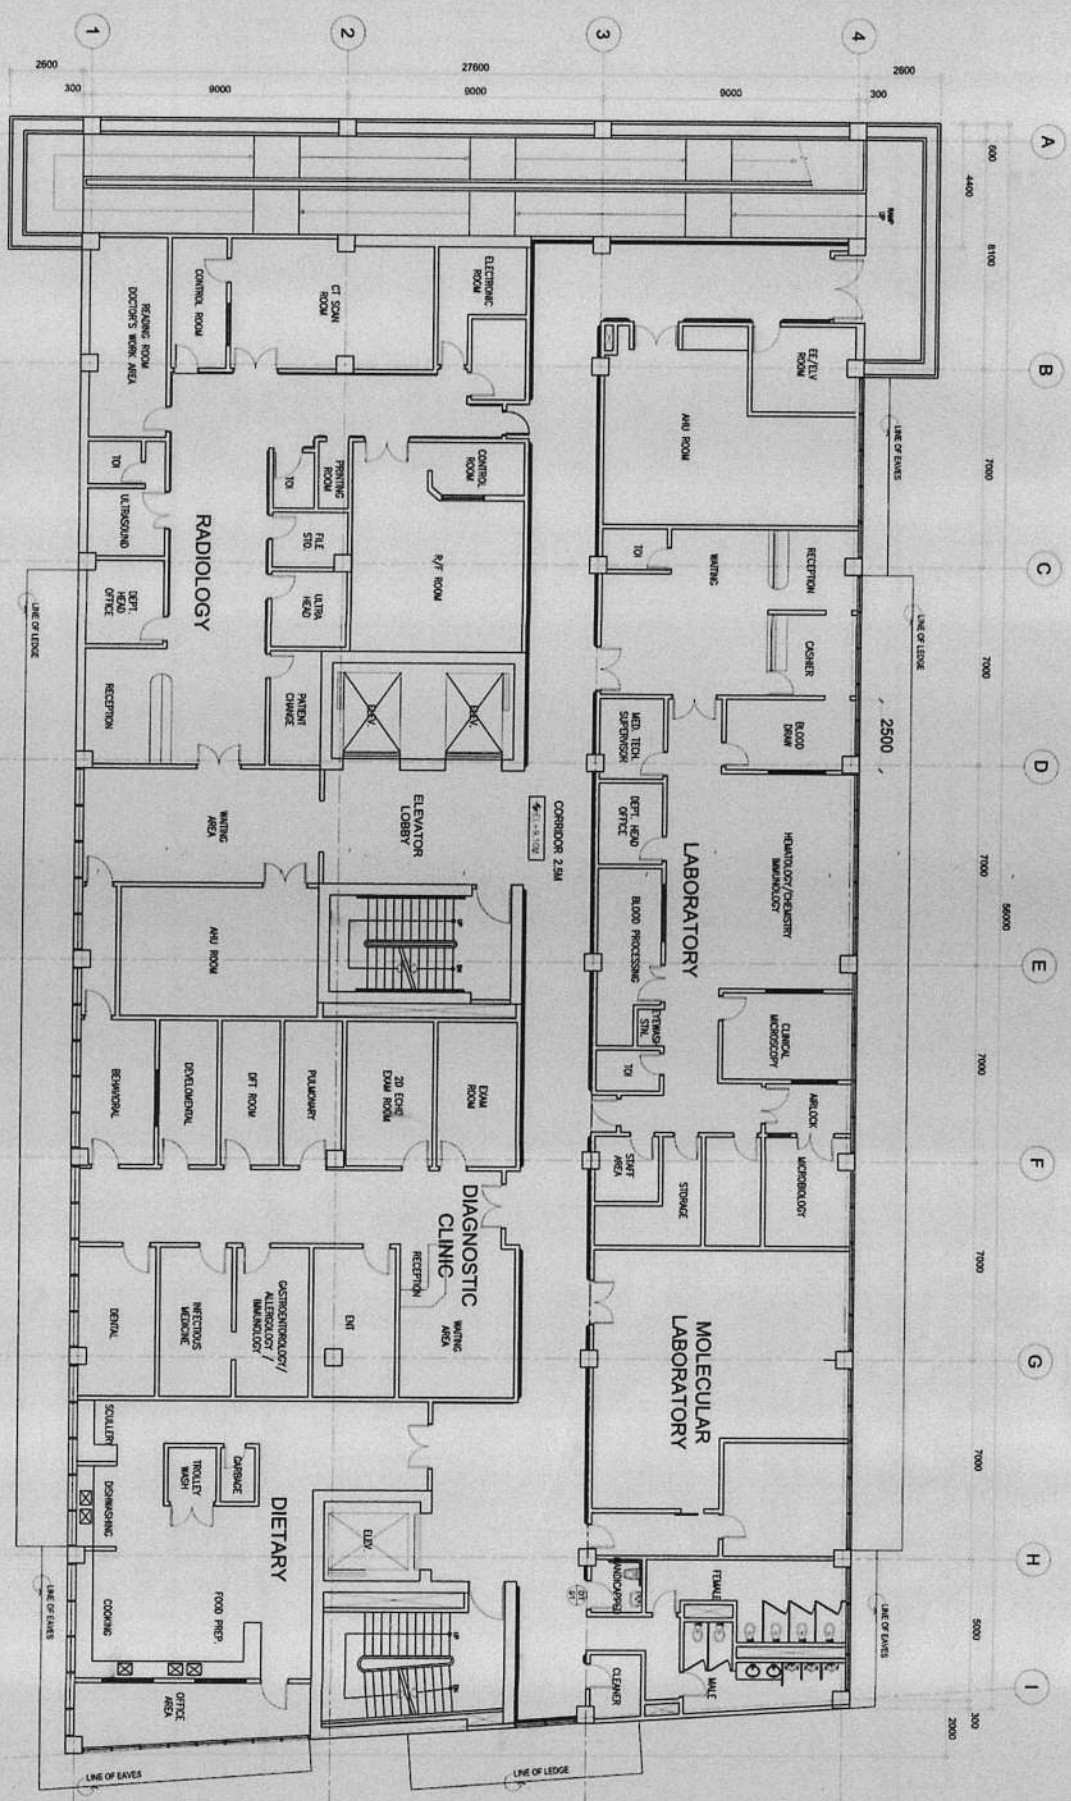

01 EXISTING THIRD FLOOR PLAN
 1:100 ILM

	REPUBLIC OF THE PHILIPPINES OFFICE OF THE MAYOR CITY OF PASIG	PROJECT TITLE: PROPOSED EXPANSION WITH IMPROVEMENT WORKS AT PASIG CITY CHILDREN'S HOSPITAL	ARCHITECTURAL: ARCH. ALVIN QUAR CHIEF ARCHITECT ARCH. ELMER ESTRADA ARCHITECT IN CHARGE	PROGRAMMING & CONSTRUCTION: ENGR. JOSE RAFAEL PROJECT MANAGER ENGR. JOSE RAFAEL PROJECT MANAGER	RECOMMENDING APPROVAL: ENGR. JOSE RAFAEL PROJECT MANAGER ENGR. JOSE RAFAEL PROJECT MANAGER	APPROVED BY: VICTOR MA REGIS N. SOTTO CITY MAYOR	SHEET CONTENTS: RESTROOM RORR LINE	SHEET NO.: 08 39 A
	REPORTING OFFICE: ENGINEERING DEPARTMENT	LOCATION: INDUSTRIAL COR. ALCALDE JOSE STS. PASIG CITY	1. TO BE CONSTRUCTED IN ACCORDANCE WITH THE PROVISIONS OF THE NATIONAL BUILDING CODE AND THE LOCAL ORDINANCES THEREUNDER. 2. IN ANY CASE, THE CONTRACTOR SHALL BE RESPONSIBLE FOR OBTAINING ALL NECESSARY PERMITS AND APPROVALS FROM THE APPROPRIATE AGENCIES. 3. IN CASE OF DISCREPANCY IN THE DRAWINGS, THE LATTER SHALL BE ADMITTED AS FINAL. 4. THE ARCHITECT SHALL BE RESPONSIBLE FOR THE DESIGN AND CONSTRUCTION OF THE STRUCTURE. 5. THE ARCHITECT SHALL BE RESPONSIBLE FOR THE DESIGN AND CONSTRUCTION OF THE STRUCTURE. 6. THE ARCHITECT SHALL BE RESPONSIBLE FOR THE DESIGN AND CONSTRUCTION OF THE STRUCTURE. 7. THE ARCHITECT SHALL BE RESPONSIBLE FOR THE DESIGN AND CONSTRUCTION OF THE STRUCTURE. 8. THE ARCHITECT SHALL BE RESPONSIBLE FOR THE DESIGN AND CONSTRUCTION OF THE STRUCTURE. 9. THE ARCHITECT SHALL BE RESPONSIBLE FOR THE DESIGN AND CONSTRUCTION OF THE STRUCTURE. 10. THE ARCHITECT SHALL BE RESPONSIBLE FOR THE DESIGN AND CONSTRUCTION OF THE STRUCTURE.	1. TO BE CONSTRUCTED IN ACCORDANCE WITH THE PROVISIONS OF THE NATIONAL BUILDING CODE AND THE LOCAL ORDINANCES THEREUNDER. 2. IN ANY CASE, THE CONTRACTOR SHALL BE RESPONSIBLE FOR OBTAINING ALL NECESSARY PERMITS AND APPROVALS FROM THE APPROPRIATE AGENCIES. 3. IN CASE OF DISCREPANCY IN THE DRAWINGS, THE LATTER SHALL BE ADMITTED AS FINAL. 4. THE ARCHITECT SHALL BE RESPONSIBLE FOR THE DESIGN AND CONSTRUCTION OF THE STRUCTURE. 5. THE ARCHITECT SHALL BE RESPONSIBLE FOR THE DESIGN AND CONSTRUCTION OF THE STRUCTURE. 6. THE ARCHITECT SHALL BE RESPONSIBLE FOR THE DESIGN AND CONSTRUCTION OF THE STRUCTURE. 7. THE ARCHITECT SHALL BE RESPONSIBLE FOR THE DESIGN AND CONSTRUCTION OF THE STRUCTURE. 8. THE ARCHITECT SHALL BE RESPONSIBLE FOR THE DESIGN AND CONSTRUCTION OF THE STRUCTURE. 9. THE ARCHITECT SHALL BE RESPONSIBLE FOR THE DESIGN AND CONSTRUCTION OF THE STRUCTURE. 10. THE ARCHITECT SHALL BE RESPONSIBLE FOR THE DESIGN AND CONSTRUCTION OF THE STRUCTURE.	APPROVED BY: VICTOR MA REGIS N. SOTTO CITY MAYOR	SHEET CONTENTS: RESTROOM RORR LINE	SHEET NO.: 08 39 A	

<p>CHEMICAL LABORATORY SECTION</p> <ol style="list-style-type: none"> 1. EXISTING CHEMICAL LABORATORY 2. EXISTING CHEMICAL LABORATORY 3. EXISTING CHEMICAL LABORATORY 4. EXISTING CHEMICAL LABORATORY 	<p>HISTORICAL LABORATORY SECTION</p> <ol style="list-style-type: none"> 1. EXISTING HISTORICAL LABORATORY 2. EXISTING HISTORICAL LABORATORY 3. EXISTING HISTORICAL LABORATORY 4. EXISTING HISTORICAL LABORATORY 	<p>CHEMICAL CHEMISTRY SECTION</p> <ol style="list-style-type: none"> 1. EXISTING CHEMICAL CHEMISTRY 2. EXISTING CHEMICAL CHEMISTRY 3. EXISTING CHEMICAL CHEMISTRY 4. EXISTING CHEMICAL CHEMISTRY 	<p>HISTORICAL CHEMISTRY SECTION</p> <ol style="list-style-type: none"> 1. EXISTING HISTORICAL CHEMISTRY 2. EXISTING HISTORICAL CHEMISTRY 3. EXISTING HISTORICAL CHEMISTRY 4. EXISTING HISTORICAL CHEMISTRY
<p>HISTORICAL LABORATORY SECTION</p> <ol style="list-style-type: none"> 1. EXISTING HISTORICAL LABORATORY 2. EXISTING HISTORICAL LABORATORY 3. EXISTING HISTORICAL LABORATORY 4. EXISTING HISTORICAL LABORATORY 	<p>HISTORICAL CHEMISTRY SECTION</p> <ol style="list-style-type: none"> 1. EXISTING HISTORICAL CHEMISTRY 2. EXISTING HISTORICAL CHEMISTRY 3. EXISTING HISTORICAL CHEMISTRY 4. EXISTING HISTORICAL CHEMISTRY 	<p>HISTORICAL LABORATORY SECTION</p> <ol style="list-style-type: none"> 1. EXISTING HISTORICAL LABORATORY 2. EXISTING HISTORICAL LABORATORY 3. EXISTING HISTORICAL LABORATORY 4. EXISTING HISTORICAL LABORATORY 	<p>HISTORICAL CHEMISTRY SECTION</p> <ol style="list-style-type: none"> 1. EXISTING HISTORICAL CHEMISTRY 2. EXISTING HISTORICAL CHEMISTRY 3. EXISTING HISTORICAL CHEMISTRY 4. EXISTING HISTORICAL CHEMISTRY

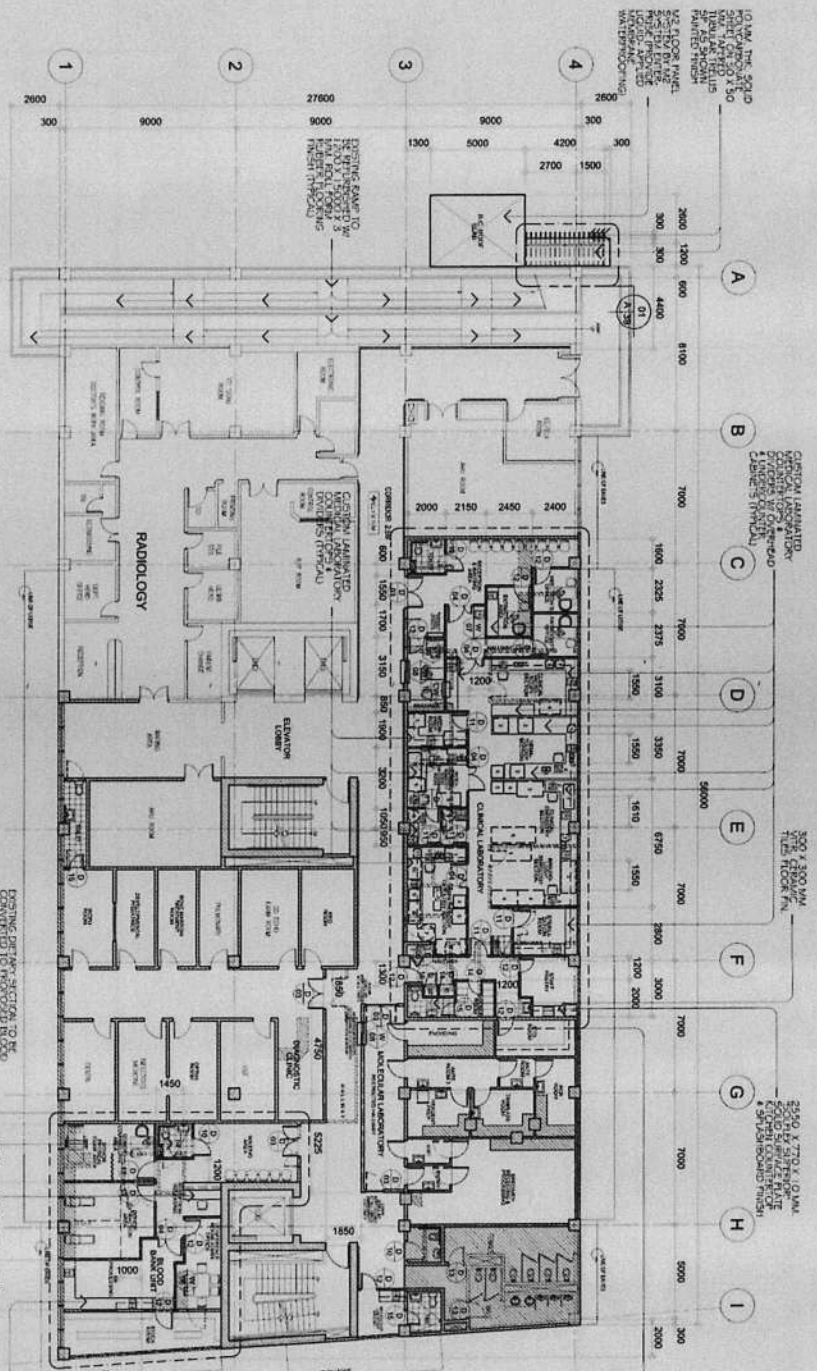

LEGEND:

- EXISTING ORIGINAL WALL TO BE RETAINED
- EXISTING ORIGINAL WALL TO BE REMOVED
- NO SINGLE PANEL
- EXISTING ORIGINAL WALL TO BE REMOVED


**WITH PROPOSED REPAIR WORKS
EXISTING THIRD FLOOR PLAN**

1:150 MM SCALE

<p>REPUBLIC OF THE PHILIPPINES CITY OF PASIG</p> <p>OFFICE OF THE MAYOR ENGINEERING DEPARTMENT</p>	<p>PROJECT TITLE: PROPOSED EXPANSION WITH IMPROVEMENT WORKS AT PASIG CITY CHILDREN'S HOSPITAL</p> <p>LOCATION: MAGSAYSAY COR. AGUIAR JOSE STS. MAGSAYSAY, PASIG CITY</p>	<p>ARCHITECTURAL: AROCYAN OLIVAR CHIEF ARCHITECTURAL SECTION ARCH. ELMER C. ESTRADA</p>	<p>PROGRAMMING & CONSTRUCTION: ENGR. JUAN M. GONZALES ENGR. JUAN M. GONZALES ENGR. ROBERTO A. GONZALES</p>	<p>RECOMMENDING APPROVAL: ENGR. JUAN M. GONZALES ENGR. ROBERTO A. GONZALES</p>	<p>APPROVED BY: VICTOR MA. REGIS N. SOTTO CITY MAYOR</p>	<p>SHEET CONTENTS: PROPOSED REPAIR WORKS</p>	<p>SHEET NO.: A 09139</p>
--	---	---	--	--	--	--	-----------------------------------

IMPORTANT NOTES:

1. ALL WORK SHALL BE DONE IN ACCORDANCE WITH THE LATEST EDITIONS OF THE PHILIPPINE NATIONAL STANDARDS (PNS) AND THE NATIONAL BUILDING CODE (NBC).
2. ALL WORK SHALL BE DONE IN ACCORDANCE WITH THE LATEST EDITIONS OF THE PHILIPPINE NATIONAL STANDARDS (PNS) AND THE NATIONAL BUILDING CODE (NBC).
3. ALL WORK SHALL BE DONE IN ACCORDANCE WITH THE LATEST EDITIONS OF THE PHILIPPINE NATIONAL STANDARDS (PNS) AND THE NATIONAL BUILDING CODE (NBC).
4. ALL WORK SHALL BE DONE IN ACCORDANCE WITH THE LATEST EDITIONS OF THE PHILIPPINE NATIONAL STANDARDS (PNS) AND THE NATIONAL BUILDING CODE (NBC).
5. ALL WORK SHALL BE DONE IN ACCORDANCE WITH THE LATEST EDITIONS OF THE PHILIPPINE NATIONAL STANDARDS (PNS) AND THE NATIONAL BUILDING CODE (NBC).
6. ALL WORK SHALL BE DONE IN ACCORDANCE WITH THE LATEST EDITIONS OF THE PHILIPPINE NATIONAL STANDARDS (PNS) AND THE NATIONAL BUILDING CODE (NBC).
7. ALL WORK SHALL BE DONE IN ACCORDANCE WITH THE LATEST EDITIONS OF THE PHILIPPINE NATIONAL STANDARDS (PNS) AND THE NATIONAL BUILDING CODE (NBC).
8. ALL WORK SHALL BE DONE IN ACCORDANCE WITH THE LATEST EDITIONS OF THE PHILIPPINE NATIONAL STANDARDS (PNS) AND THE NATIONAL BUILDING CODE (NBC).
9. ALL WORK SHALL BE DONE IN ACCORDANCE WITH THE LATEST EDITIONS OF THE PHILIPPINE NATIONAL STANDARDS (PNS) AND THE NATIONAL BUILDING CODE (NBC).
10. ALL WORK SHALL BE DONE IN ACCORDANCE WITH THE LATEST EDITIONS OF THE PHILIPPINE NATIONAL STANDARDS (PNS) AND THE NATIONAL BUILDING CODE (NBC).

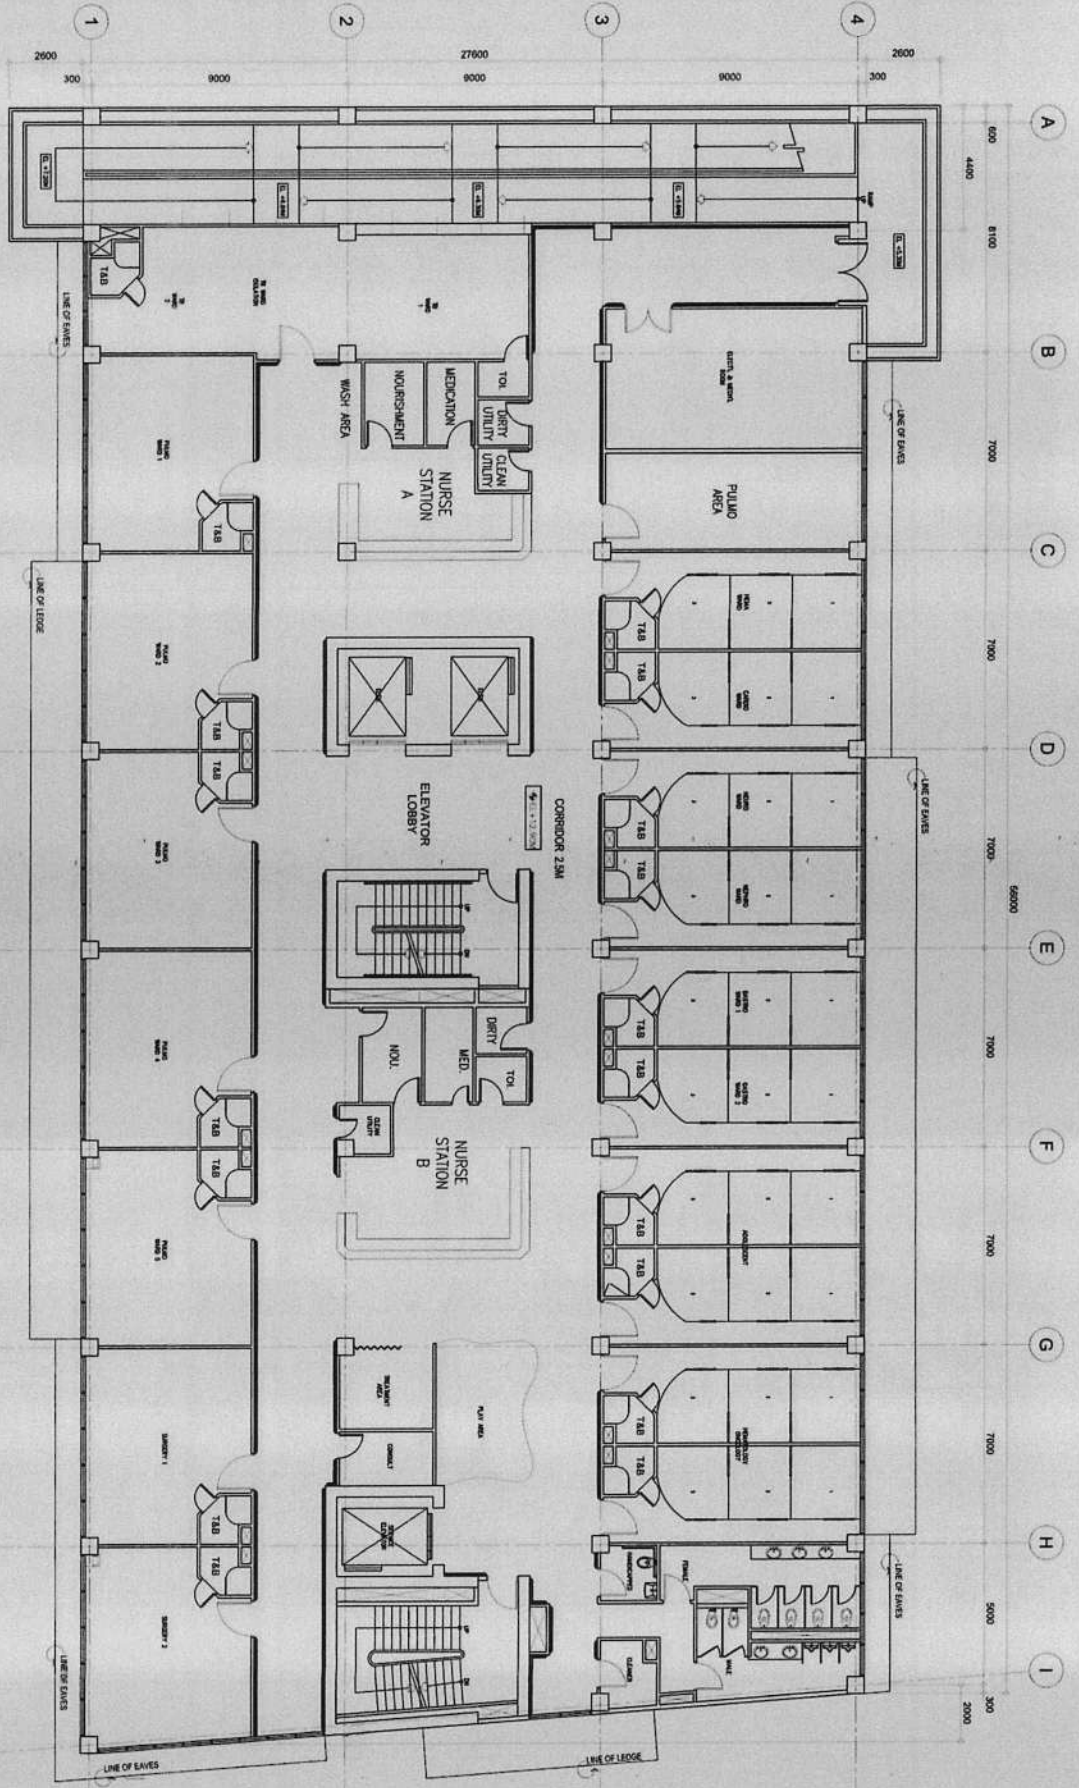

01
EXISTING FOURTH FLOOR PLAN
SCALE 1:100 NML



REPUBLIC OF THE PHILIPPINES
CITY OF PASIG
OFFICE OF THE MAYOR
ENGINEERING DEPARTMENT

PROJECT TITLE:
PROPOSED EXPANSION W/
IMPROVEMENT WORKS AT
PASIG CITY CHILDREN'S HOSPITAL

ARCHITECTURAL:
ARCH. EDUARDO ESTRAÑA
ARCHITECT II

PROGRAMMING & CONSTRUCTION:
ENGR. JESON B. FRANCIS
ENGR. JONAS D. LEZOR
ENGR. FREDY E. VILLO

RECOMMENDING APPROVAL:
ENGR. LUIS R. ANDRÉS
ENGR. ARTAVENES V. GERONIMO


APPROVED BY:
VICTOR MAC REGIS W. SOTTO
CITY MAYOR

SHEET CONTENTS:
EXISTING FOURTH FLOOR PLAN

SHEET NO.:
A
10 | 39

REVISIONS:
1. NO. 1. TO BE USED FOR THE PROPOSED EXPANSION W/ IMPROVEMENT WORKS AT PASIG CITY CHILDREN'S HOSPITAL. THE ORIGINAL PLAN SHALL BE USED FOR THE PROPOSED EXPANSION W/ IMPROVEMENT WORKS AT PASIG CITY CHILDREN'S HOSPITAL.
2. NO. 2. TO BE USED FOR THE PROPOSED EXPANSION W/ IMPROVEMENT WORKS AT PASIG CITY CHILDREN'S HOSPITAL. THE ORIGINAL PLAN SHALL BE USED FOR THE PROPOSED EXPANSION W/ IMPROVEMENT WORKS AT PASIG CITY CHILDREN'S HOSPITAL.
3. TO BE USED FOR THE PROPOSED EXPANSION W/ IMPROVEMENT WORKS AT PASIG CITY CHILDREN'S HOSPITAL. THE ORIGINAL PLAN SHALL BE USED FOR THE PROPOSED EXPANSION W/ IMPROVEMENT WORKS AT PASIG CITY CHILDREN'S HOSPITAL.
4. ANY MODIFICATION OF THIS INSTRUCTION SHALL BE CONNECTED AT THE END OF THE CONNECTION.
5. THIS SET OF DRAWINGS IS PREPARED FOR THE PROPOSED EXPANSION W/ IMPROVEMENT WORKS AT PASIG CITY CHILDREN'S HOSPITAL. THE ORIGINAL PLAN SHALL BE USED FOR THE PROPOSED EXPANSION W/ IMPROVEMENT WORKS AT PASIG CITY CHILDREN'S HOSPITAL.
6. THE PROPOSAL OF WORKS IS FOR EXISTING PURPOSES ONLY.

- EXISTING PUBLIC WORKS ROOMS TO BE REFINISHED WITH:
1. REPAIRING OF WALLS BY CHANGING MATERIAL TO MATCH EXISTING
 2. WIPING OFF ALL UNDERCOATINGS
 3. FLOOR FINISH TO BE CHANGED TO POLISHED CONCRETE
 4. CEILING FINISH TO BE CHANGED TO 2" X 4" GRID WITH 2" X 4" PANELS
 5. 4" DECKING OF FLOOR

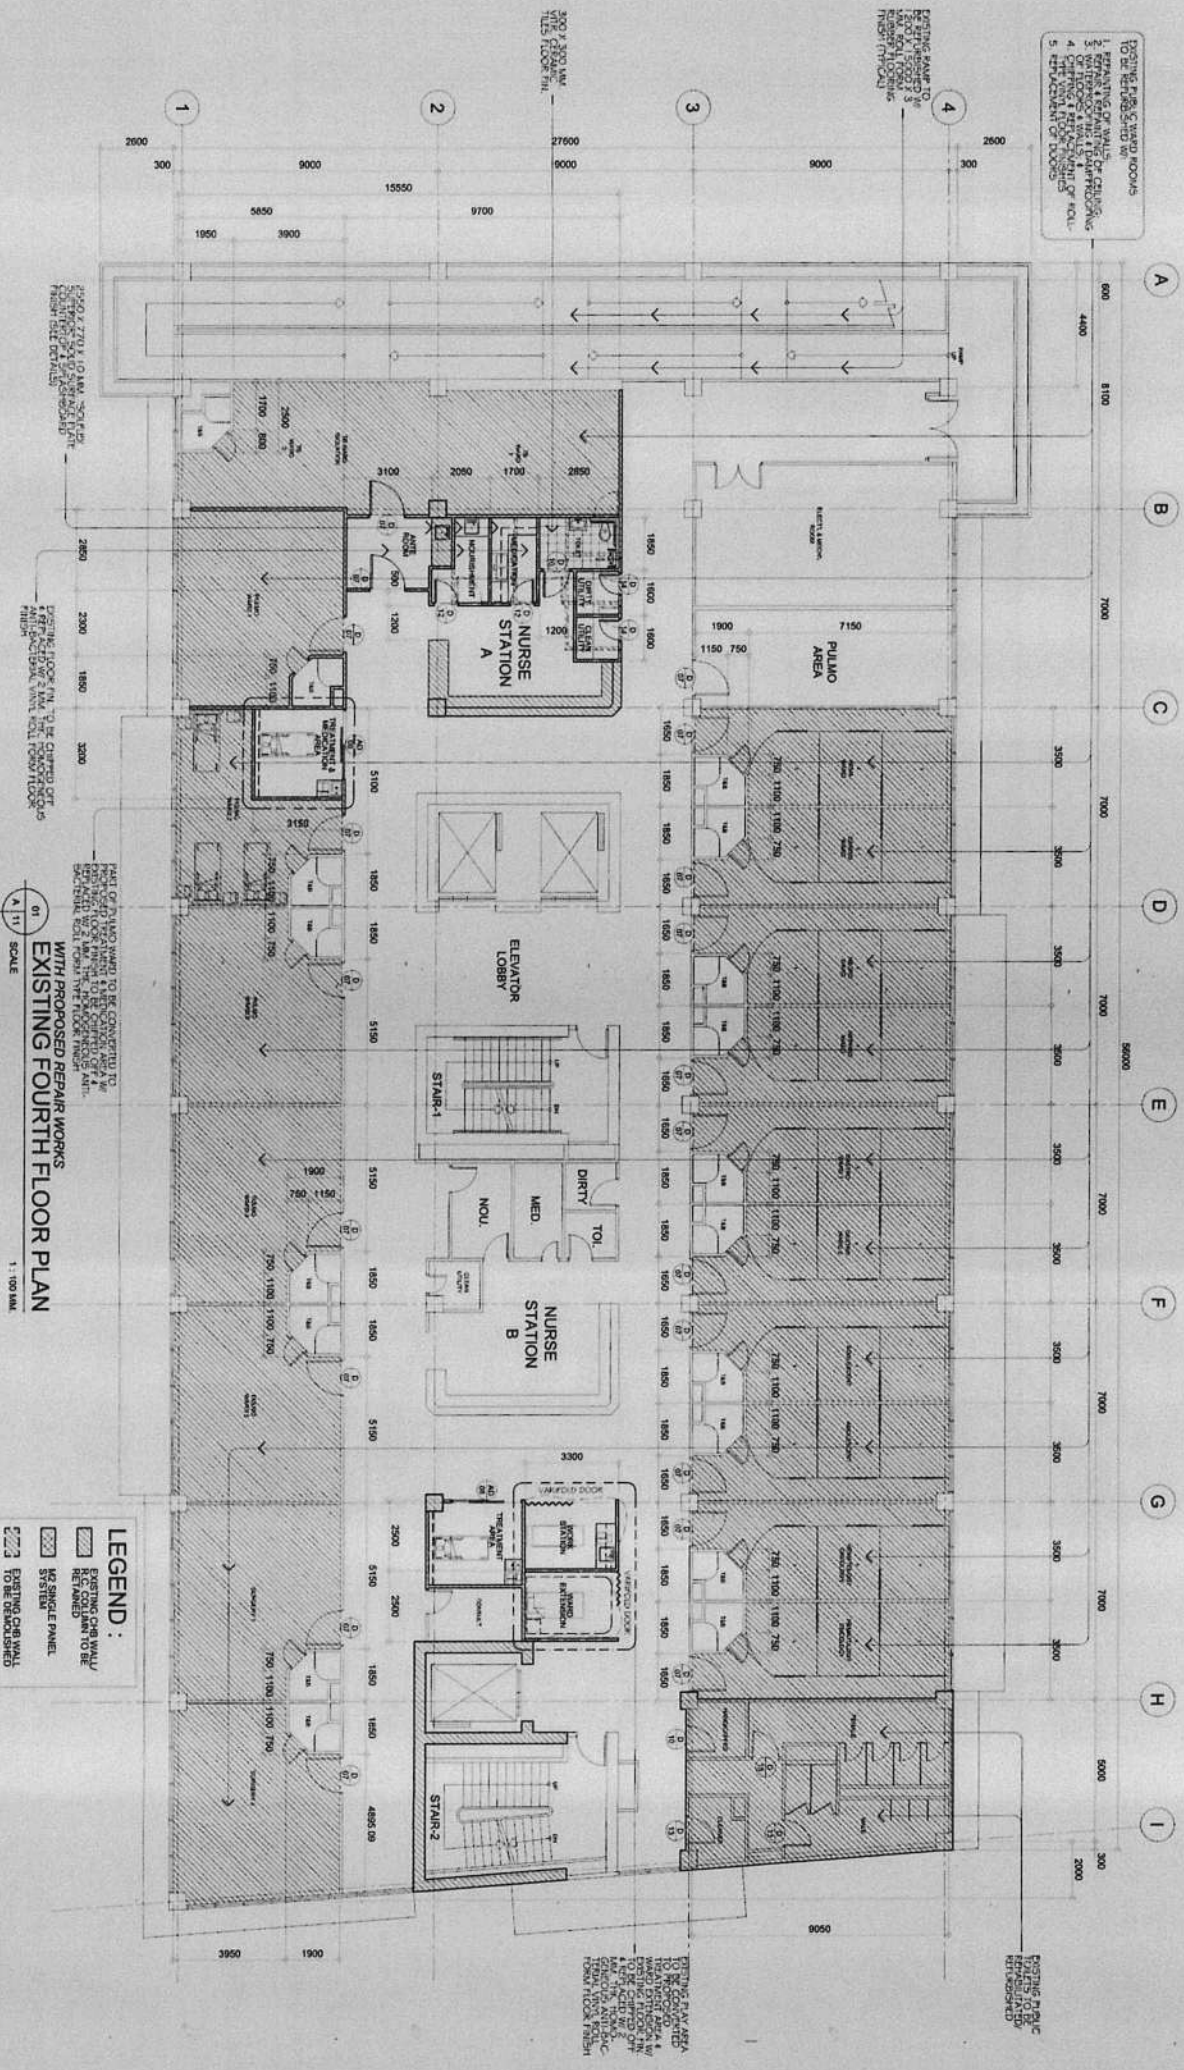


01
SCALE
1:100 IMA
WITH PROPOSED REPAIR WORKS
EXISTING FOURTH FLOOR PLAN

- LEGEND:**
- EXISTING CHIB WALL
 - EXISTING CHIB WALL TO BE DEMOLISHED
 - NEW CHIB WALL
 - NEW CHIB WALL TO BE DEMOLISHED
 - NEW SINGLE PANEL
 - EXISTING CHIB WALL TO BE DEMOLISHED

	REPUBLIC OF THE PHILIPPINES OFFICE OF THE MAYOR CITY OF PASIG ENGINEERING DEPARTMENT	PROJECT TITLE PROPOSED EXPANSION W/ IMPROVEMENT WORKS AT PASIG CITY CHILDREN'S HOSPITAL	ARCHITECTURAL ARCH. ELY V. OLIVAR <small>CHIEF ARCHITECTURAL SECTION</small> ARCH. ELMER C. ESTRADA <small>CONSULTANT</small>	PROGRAMMING & CONSTRUCTION ENGR. ARSENIO RABERES <small>CHIEF PROGRAMMING & CONSTRUCTION SECTION</small> ENGR. JUAN P. PEREZ <small>CONSULTANT</small> ENGR. JOSE E. APZO <small>CONSULTANT</small>	RECOMMENDING APPROVAL: ENGR. ARSENIO RABERES <small>CHIEF PROGRAMMING & CONSTRUCTION SECTION</small>	APPROVED BY: VICTOR MA. REGIS N. SOTTO <small>CITY MAYOR</small>	SHEET CONTENTS: PROPOSED EXPANSION W/ IMPROVEMENT WORKS AT PASIG CITY CHILDREN'S HOSPITAL	SHEET NO.: A 11/39
	LOCATION: INDUSTRIAL COR. AL-CAJUP, JOSE STS. PASIG CITY	ARCHITECTURAL: ARCH. ELY V. OLIVAR <small>CHIEF ARCHITECTURAL SECTION</small> ARCH. ELMER C. ESTRADA <small>CONSULTANT</small>	PROGRAMMING & CONSTRUCTION: ENGR. ARSENIO RABERES <small>CHIEF PROGRAMMING & CONSTRUCTION SECTION</small> ENGR. JUAN P. PEREZ <small>CONSULTANT</small> ENGR. JOSE E. APZO <small>CONSULTANT</small>	RECOMMENDING APPROVAL: ENGR. ARSENIO RABERES <small>CHIEF PROGRAMMING & CONSTRUCTION SECTION</small>	APPROVED BY: VICTOR MA. REGIS N. SOTTO <small>CITY MAYOR</small>	SHEET CONTENTS: PROPOSED EXPANSION W/ IMPROVEMENT WORKS AT PASIG CITY CHILDREN'S HOSPITAL	SHEET NO.: A 11/39	

PROGRAM NOTES:
 1. FOR ALL EXPANSION WORKS, ALL STRUCTURES SHALL BE CONSTRUCTED TO MEET THE REQUIREMENTS OF THE NATIONAL BUREAU OF FIRE PROTECTION (NBF) AND THE NATIONAL BUREAU OF STANDARDS (NS).
 2. ALL STRUCTURES SHALL BE CONSTRUCTED TO MEET THE REQUIREMENTS OF THE NATIONAL BUREAU OF STANDARDS (NS).
 3. ALL STRUCTURES SHALL BE CONSTRUCTED TO MEET THE REQUIREMENTS OF THE NATIONAL BUREAU OF STANDARDS (NS).
 4. ALL STRUCTURES SHALL BE CONSTRUCTED TO MEET THE REQUIREMENTS OF THE NATIONAL BUREAU OF STANDARDS (NS).
 5. ALL STRUCTURES SHALL BE CONSTRUCTED TO MEET THE REQUIREMENTS OF THE NATIONAL BUREAU OF STANDARDS (NS).
 6. ALL STRUCTURES SHALL BE CONSTRUCTED TO MEET THE REQUIREMENTS OF THE NATIONAL BUREAU OF STANDARDS (NS).
 7. ALL STRUCTURES SHALL BE CONSTRUCTED TO MEET THE REQUIREMENTS OF THE NATIONAL BUREAU OF STANDARDS (NS).
 8. ALL STRUCTURES SHALL BE CONSTRUCTED TO MEET THE REQUIREMENTS OF THE NATIONAL BUREAU OF STANDARDS (NS).
 9. ALL STRUCTURES SHALL BE CONSTRUCTED TO MEET THE REQUIREMENTS OF THE NATIONAL BUREAU OF STANDARDS (NS).
 10. ALL STRUCTURES SHALL BE CONSTRUCTED TO MEET THE REQUIREMENTS OF THE NATIONAL BUREAU OF STANDARDS (NS).

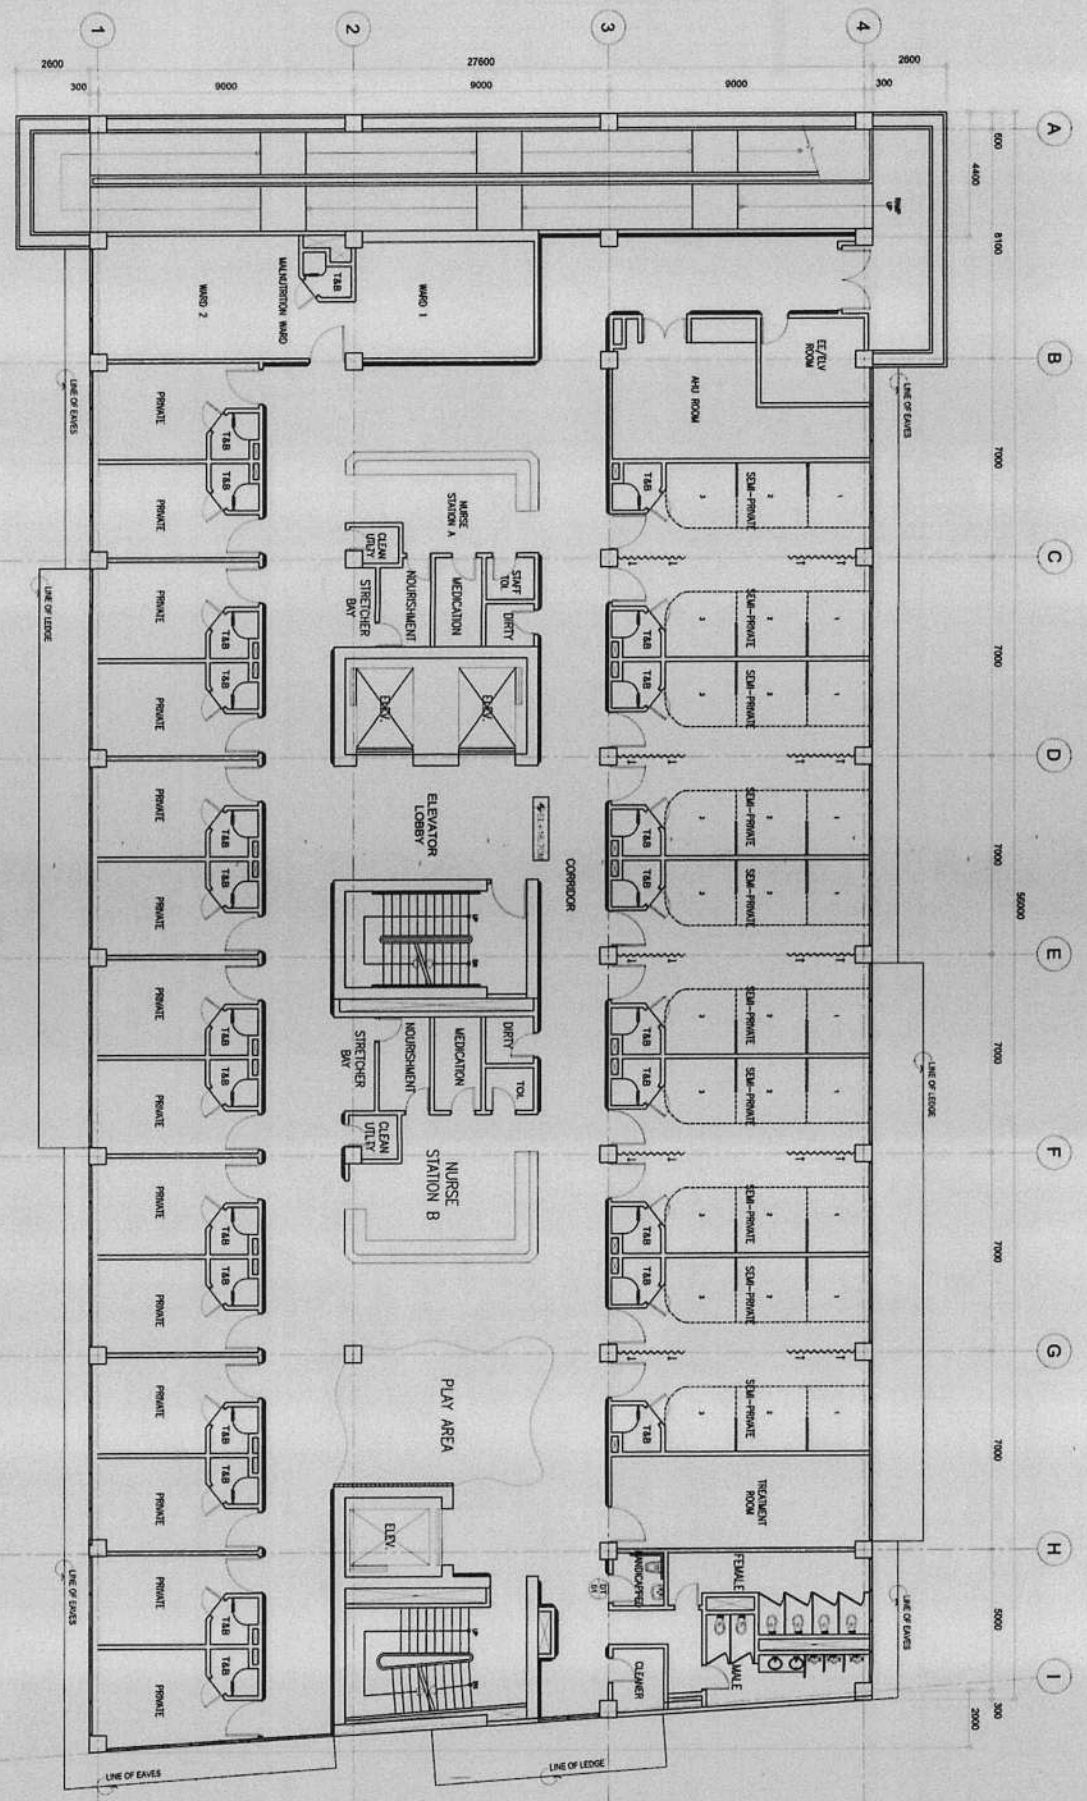

01 EXISTING FIFTH FLOOR PLAN
 1:100 MM
 A 1/2 SCALE



REPUBLIC OF THE PHILIPPINES
 CITY OF PASIG
 OFFICE OF THE MAYOR
 ENGINEERING DEPARTMENT

PROJECT TITLE:
PROPOSED EXPANSION W/ INHIBITORY CHILDREN'S HOSPITAL PASIG CITY

ARCHITECTURAL:
 ARCH. **RODOLFO OLIVAR**
 CHIEF ARCHITECTURAL SECTION
 ARCH. **EDMUND ESTRADA**
 ARCHITECT IN CHARGE

PROGRAMMING & CONSTRUCTION:
 ENGR. **JOSE R. RANESSES**
 PROJECTS
 ENGR. **ALBERTO S. SANCHEZ**
 ENGR. **EDUARDO A. ALBERO**


RECOMMENDING APPROVAL:
 ENGR. **RODOLFO PRODENICIO**
 O.I.C. ENGINEERING DEPARTMENT

ENGR. **ARTAVENDES V. GERONIMO**
 O.I.C. ENGINEERING DEPARTMENT

APPROVED BY:
VICTOR MA. REGIS N. SOTTO
 CITY MAYOR

SHEET CONTENTS: **RENDERING ROOM PLAN**
 SHEET NO.: **A**
12 39

IMPORTANT NOTES:
 1. NOT A FINAL CONTRACT DOCUMENT. THIS IS A PRELIMINARY PLAN. ALL DIMENSIONS SHALL BE BASED ON THE ARCHITECTURAL DRAWING.
 2. ALL WORK SHALL BE DONE IN ACCORDANCE WITH THE LATEST EDITIONS OF THE NATIONAL BUILDING CODE AND ALL APPLICABLE REGULATIONS.
 3. THE USER OF THIS DOCUMENT SHALL BE RESPONSIBLE FOR OBTAINING ALL NECESSARY PERMITS AND APPROVALS FROM THE APPROPRIATE AGENCIES.
 4. ANY MODIFICATION OF THIS DESIGN SHALL BE CONNECTED AT THE END OF THE DRAWING.
 5. THE PROVISION OF WORK IS FOR INFORMATION PURPOSES ONLY.

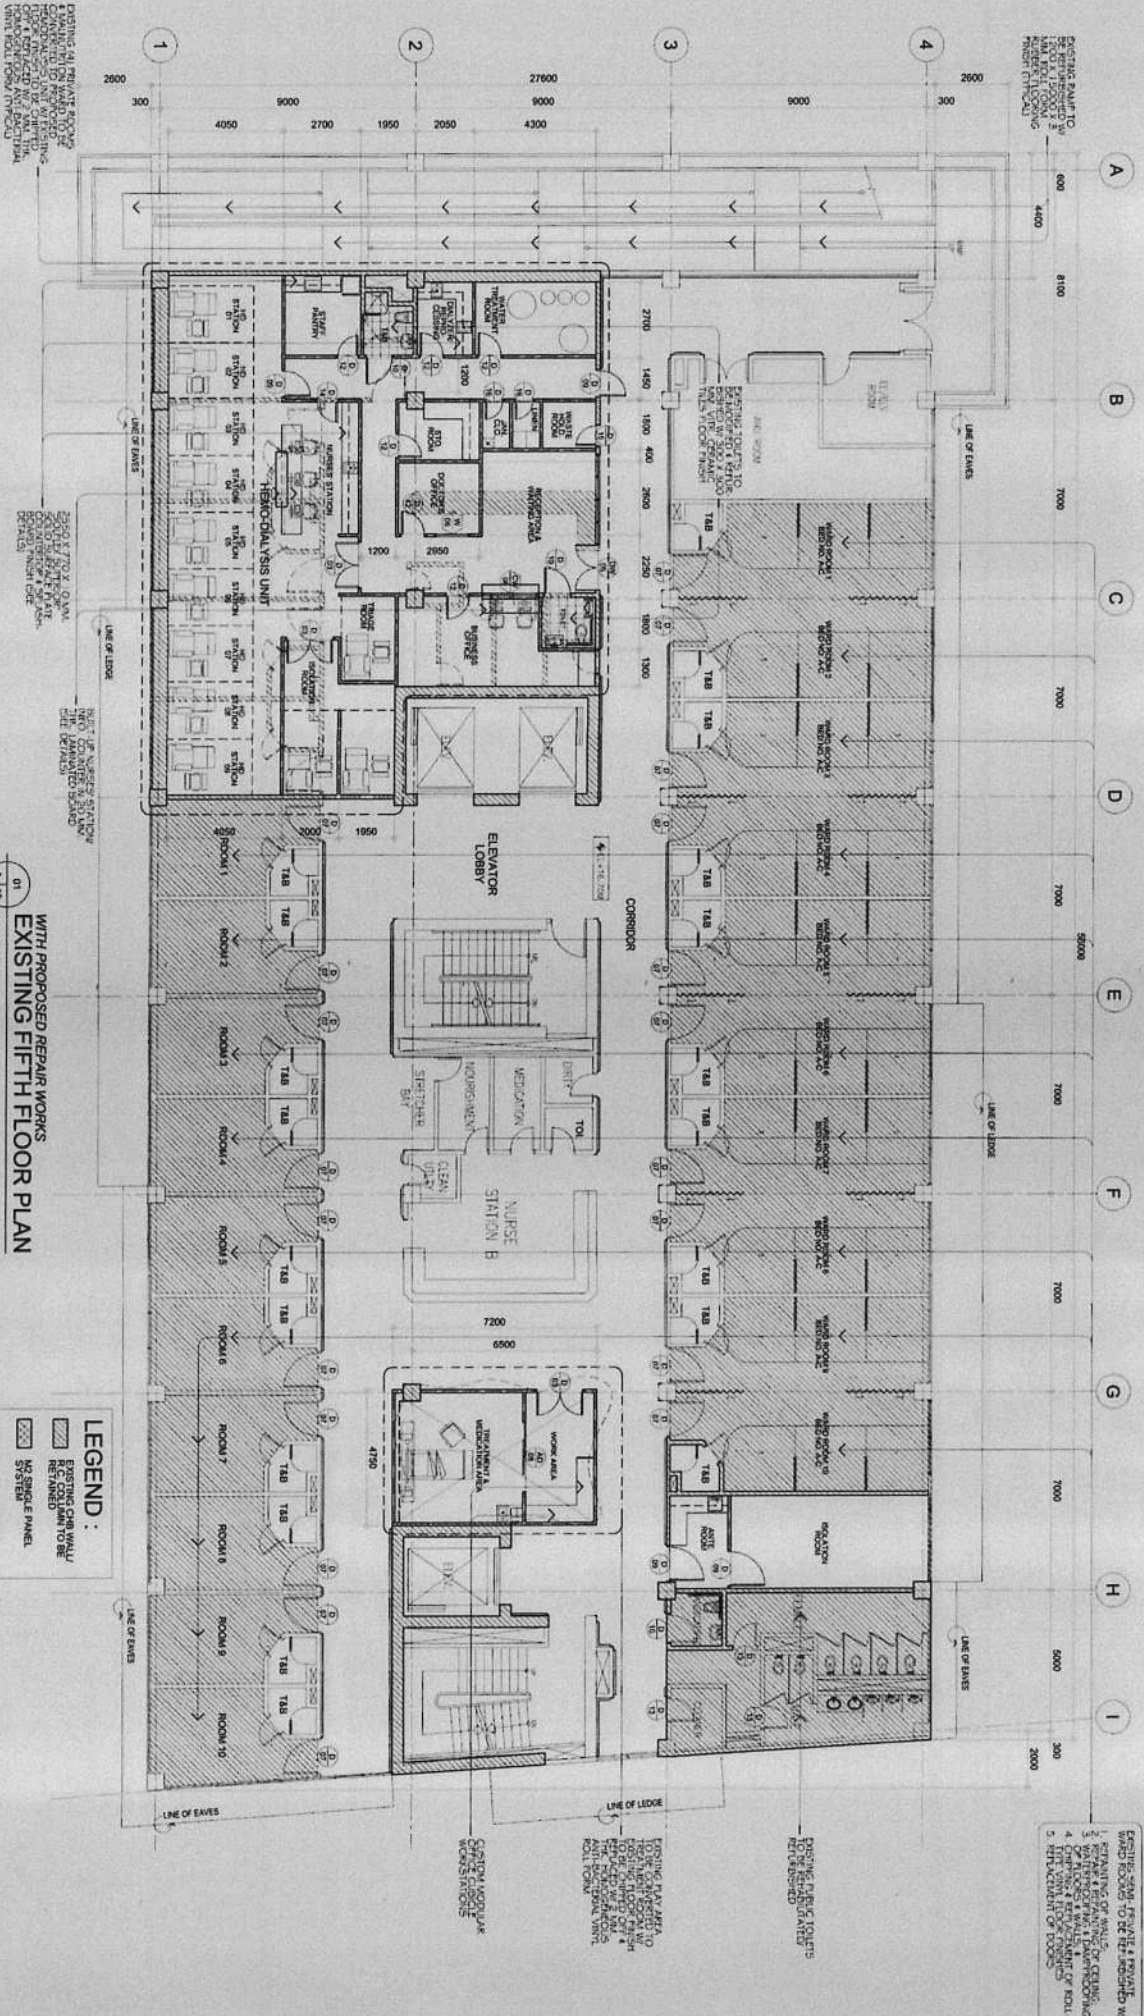

WITH PROPOSED REPAIR WORKS
EXISTING FIFTH FLOOR PLAN
 01 SCALE
 1:100 MM

LEGEND:
 [Hatched pattern] EXISTING CHAIR WALL
 [Dotted pattern] EXISTING WALL TO BE RETAINED TO BE
 [Solid pattern] NO SINGLE PANEL
 [Stippled pattern] EXISTING CHAIR WALL TO BE DEMOLISHED

EXISTING 4th, 5th & 6th FLOOR WITH
 WORK PROPOSED TO BE DEMOLISHED WITH
 1. REMAINING OF WALLS
 2. REMAINING OF FLOORING
 3. REMAINING OF WALLS & FLOORING
 4. FIFTH FLOOR FLOORING
 5. REPLACEMENT OF FLOORING



REPUBLIC OF THE PHILIPPINES
 CITY OF PASIG
 OFFICE OF THE MAYOR
 ENGINEERING DEPARTMENT

PROJECT TITLE:
**PROPOSED EXPANSION WITH
 IMPROVEMENT WORKS AT
 PASIG CITY CHILDREN'S HOSPITAL**

ARCHITECTURAL:
ARCH. TEL V. OLIVERA
 ARCHITECT
ARCH. ELMER ESTRADA
 ARCHITECT

PROGRAMMING & CONSTRUCTION:
ENR. ERIC R. RANESSES
 PROJECT MANAGER
ENR. JAY R. GARCIA
 PROJECT MANAGER


RECOMMENDING APPROVAL:
ENR. ERIC R. RANESSES
 PROJECT MANAGER
ENR. ARTAVERDES V. GERONIMO
 O.I.C. ENGINEERING DEPARTMENT

APPROVED BY:
VICTOR M. REGIS N. SOTTO
 CITY MAYOR

SHEET CONTENTS:
 EXISTING FIFTH FLOOR PLAN
 SHEET NO. **A**


13 | 39

IMPORTANT NOTES:
 1. NO ALTERATION OF WALLS & STRUCTURAL MEMBERS SHALL BE MADE WITHOUT THE WRITTEN APPROVAL OF THE ARCHITECT.
 2. IN ALL WORKS, THE CONTRACTOR SHALL BE RESPONSIBLE FOR OBTAINING ALL NECESSARY PERMITS AND APPROVALS FROM THE APPROPRIATE AGENCIES.
 3. THE CONTRACTOR SHALL BE RESPONSIBLE FOR OBTAINING ALL NECESSARY PERMITS AND APPROVALS FROM THE APPROPRIATE AGENCIES.
 4. THE CONTRACTOR SHALL BE RESPONSIBLE FOR OBTAINING ALL NECESSARY PERMITS AND APPROVALS FROM THE APPROPRIATE AGENCIES.
 5. THE CONTRACTOR SHALL BE RESPONSIBLE FOR OBTAINING ALL NECESSARY PERMITS AND APPROVALS FROM THE APPROPRIATE AGENCIES.
 6. THE CONTRACTOR SHALL BE RESPONSIBLE FOR OBTAINING ALL NECESSARY PERMITS AND APPROVALS FROM THE APPROPRIATE AGENCIES.
 7. THE CONTRACTOR SHALL BE RESPONSIBLE FOR OBTAINING ALL NECESSARY PERMITS AND APPROVALS FROM THE APPROPRIATE AGENCIES.
 8. THE CONTRACTOR SHALL BE RESPONSIBLE FOR OBTAINING ALL NECESSARY PERMITS AND APPROVALS FROM THE APPROPRIATE AGENCIES.
 9. THE CONTRACTOR SHALL BE RESPONSIBLE FOR OBTAINING ALL NECESSARY PERMITS AND APPROVALS FROM THE APPROPRIATE AGENCIES.
 10. THE CONTRACTOR SHALL BE RESPONSIBLE FOR OBTAINING ALL NECESSARY PERMITS AND APPROVALS FROM THE APPROPRIATE AGENCIES.

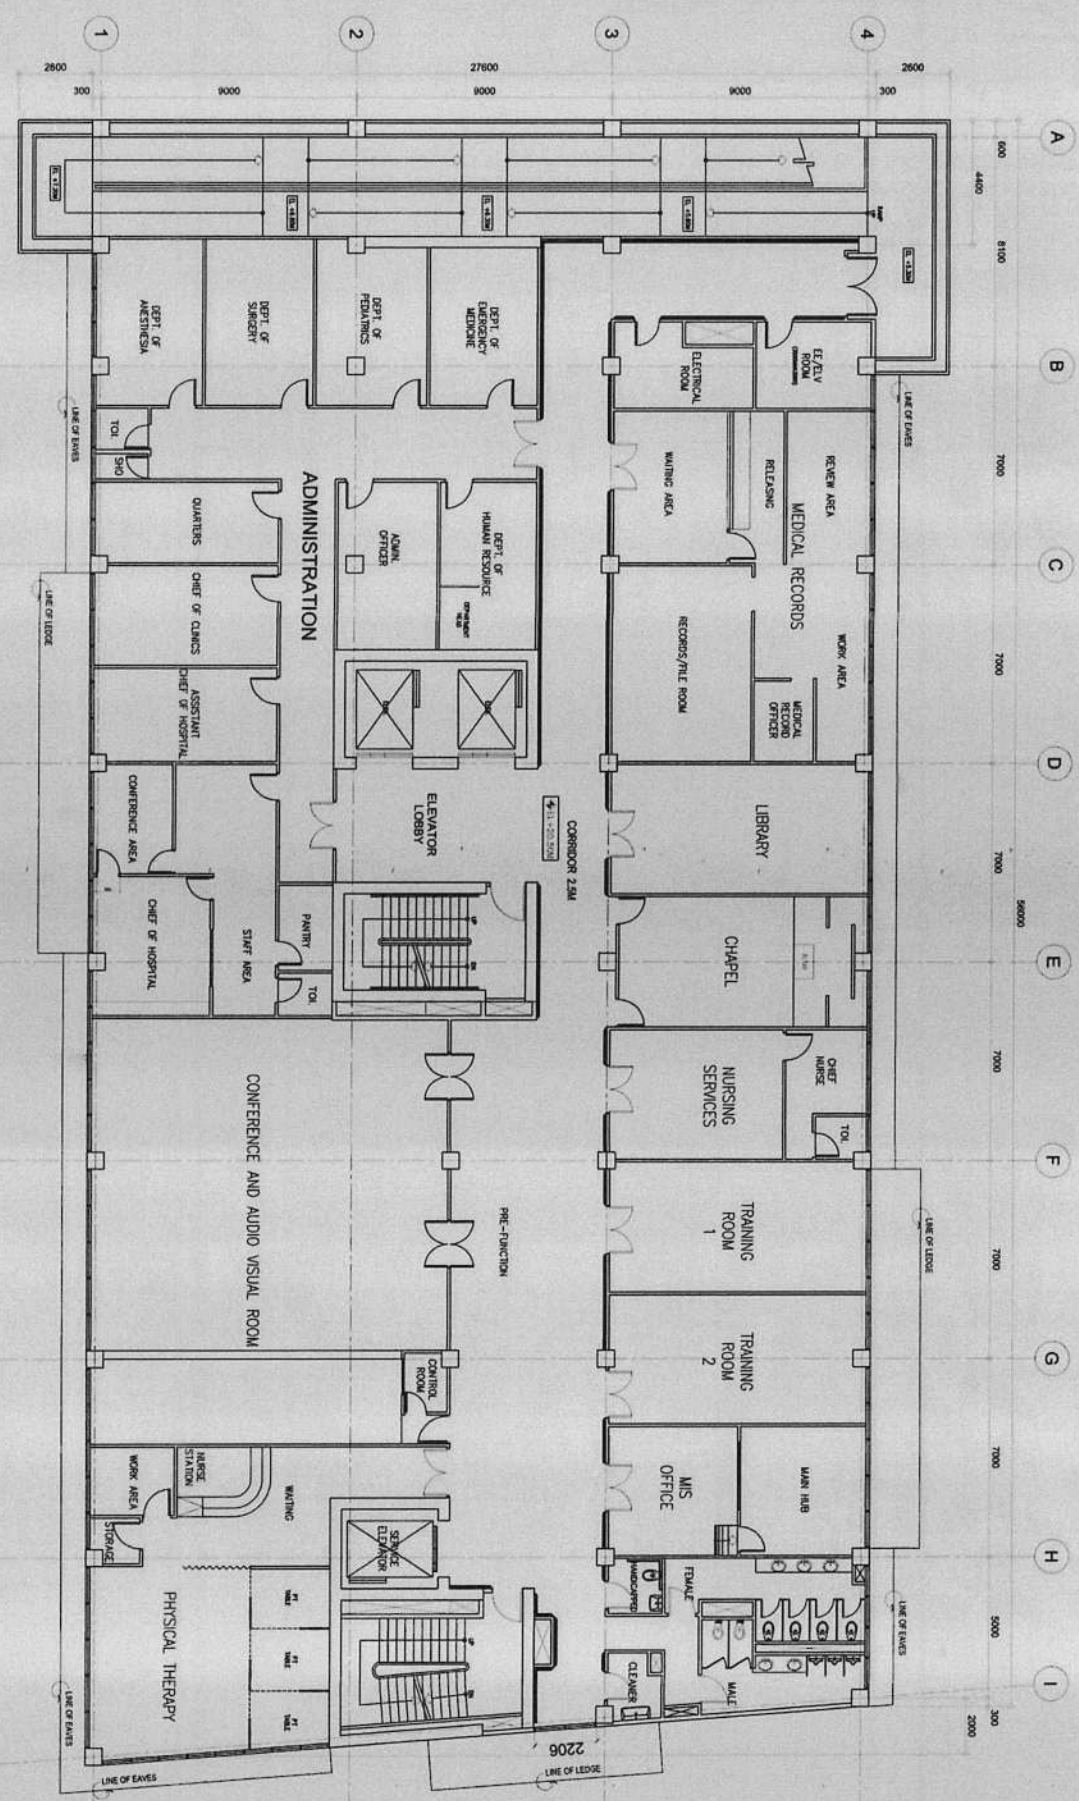

01
A 14
SCALE
EXISTING SIXTH FLOOR PLAN
1:100 MAX.

	PROJECT TITLE: PROPOSED EXPANSION W/ IMPROVEMENT WORKS AT PASIG CITY CHILDREN'S HOSPITAL	ARCHITECTURAL: ARCH. REY V. OLIVAR CHIEF ARCHITECTURAL DESIGNER ARCH. ELMER C. ESTRADA ARCHITECT	PROGRAMMING & CONSTRUCTION: ENGR. ROBERTO S. BARRALES CHIEF ARCHITECTURAL PROJECTS ENGR. JUAN RIVERA ENGR. JOSEPH S. ARBO	RECOMMENDING APPROVAL: ENGR. FRUDESCO ENGR. ARTXKERSSEY GERONIMO	APPROVED BY: VICTOR MA. REGIS N. SOTTO CITY MAYOR	SHEET CONTENTS: EXISTING 6TH FLOOR PLAN	SHEET NO.: A 14 39
	LOCATION: INDUSTRIAL ZONE, ALCADE, JOSE STS., KAYANGAN PASIG CITY	IMPORTANT NOTES: 1. THE CONTRACTOR SHALL BE RESPONSIBLE FOR THE PROTECTION OF THE EXISTING STRUCTURE. 2. THE CONTRACTOR SHALL BE RESPONSIBLE FOR THE PROTECTION OF THE EXISTING UTILITIES. 3. THE CONTRACTOR SHALL BE RESPONSIBLE FOR THE PROTECTION OF THE EXISTING EQUIPMENT. 4. THE CONTRACTOR SHALL BE RESPONSIBLE FOR THE PROTECTION OF THE EXISTING LANDSCAPE. 5. THE CONTRACTOR SHALL BE RESPONSIBLE FOR THE PROTECTION OF THE EXISTING ADJACENT PROPERTIES. 6. THE CONTRACTOR SHALL BE RESPONSIBLE FOR THE PROTECTION OF THE EXISTING NEIGHBORHOOD. 7. THE CONTRACTOR SHALL BE RESPONSIBLE FOR THE PROTECTION OF THE EXISTING ENVIRONMENT. 8. THE CONTRACTOR SHALL BE RESPONSIBLE FOR THE PROTECTION OF THE EXISTING CULTURAL HERITAGE. 9. THE CONTRACTOR SHALL BE RESPONSIBLE FOR THE PROTECTION OF THE EXISTING HISTORICAL MONUMENTS. 10. THE CONTRACTOR SHALL BE RESPONSIBLE FOR THE PROTECTION OF THE EXISTING NATIONAL LANDMARKS.	RECOMMENDING APPROVAL: ENGR. FRUDESCO ENGR. ARTXKERSSEY GERONIMO	APPROVED BY: VICTOR MA. REGIS N. SOTTO CITY MAYOR	SHEET CONTENTS: EXISTING 6TH FLOOR PLAN	SHEET NO.: A 14 39	

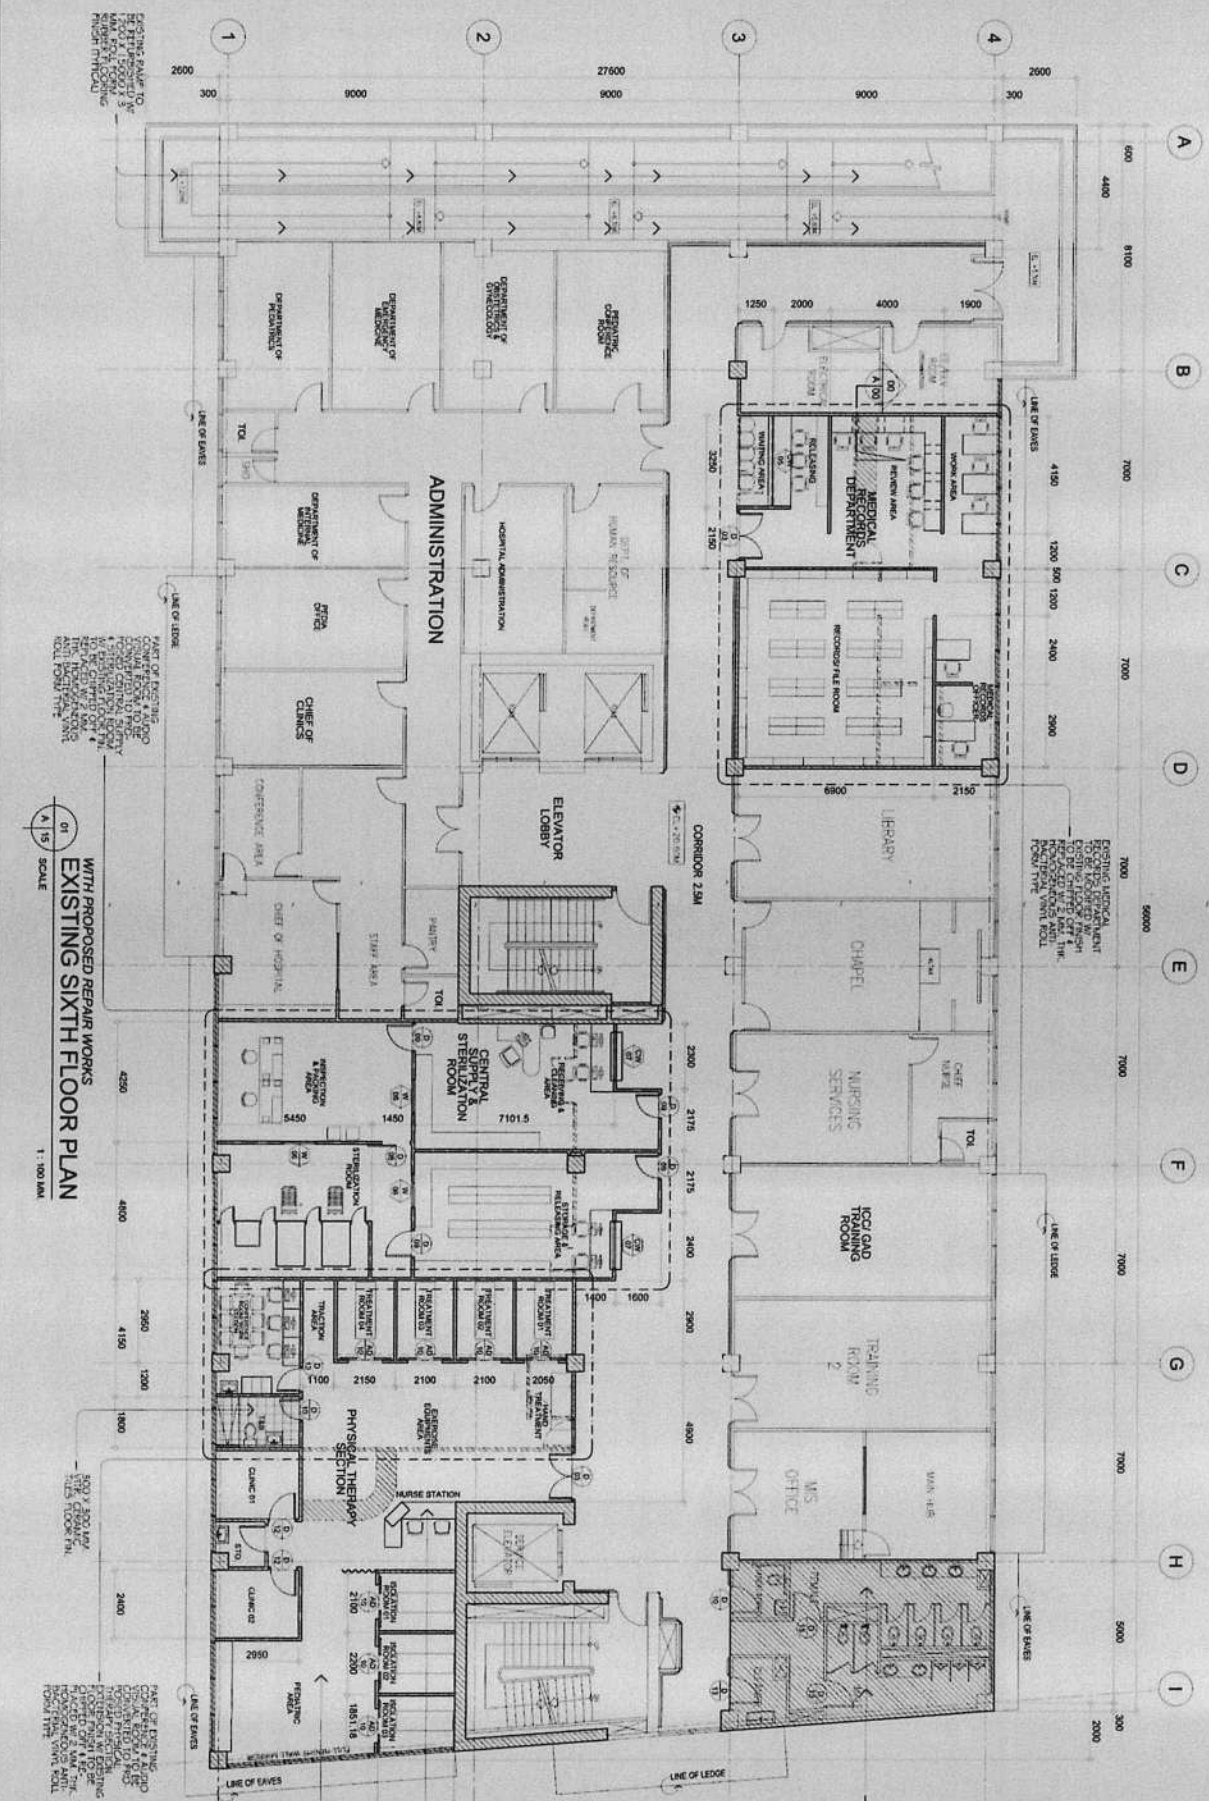


WITH PROPOSED REPAIR WORKS
 EXISTING SIXTH FLOOR PLAN
 1:100 MM SCALE

LEGEND:

- EXISTING WORK TO BE RETAINED
- EXISTING WORK TO BE DEMOLISHED
- EXISTING WORK TO BE REPLACED
- NEW SINGLE PANEL SYSTEM
- NEW PARTITION SYSTEM
- EXISTING WORK TO BE REPLACED WITH A NEW SYSTEM

	REPUBLIC OF THE PHILIPPINES CITY OF PASIG ENGINEERING DEPARTMENT	PROJECT TITLE: PROPOSED EXPANSION AND IMPROVEMENT WORKS AT PASIG CITY CHILDREN'S HOSPITAL	ARCHITECTURAL: ARCH-TERY OLIVAR CHIEF ARCHITECTURAL SECTION ARCH-EMERSON ESTRADA ARCHITECT	PROGRAMMING & CONSTRUCTION: ENGR. RICHARD GANSES CHIEF OF PROJECTS ENGR. JUAN PABLO SERRA SENIOR PROJECT MANAGER	RECOMMENDING APPROVAL: ENGR. JUAN PABLO SERRA SENIOR PROJECT MANAGER ENGR. ARTAVERTES V. GERONIMO O.C. ENGINEERING DEPARTMENT	APPROVED BY: VICTOR M. REGIS N. SOTTO CITY MANAGER	SHEET CONTENTS: EXISTING SIXTH FLOOR PLAN SHEET NO.: A 15 39
	REPORTING NOTES: 1. THIS ARCHITECTURAL PLAN IS THE PROPERTY OF THE ENGINEERING DEPARTMENT OF THE CITY OF PASIG. IT IS TO BE USED ONLY FOR THE PROJECT AND SITE SPECIFICALLY IDENTIFIED HEREON. 2. THE ENGINEER HAS CONDUCTED VISUAL INSPECTION OF THE EXISTING STRUCTURE AND FOUND IT TO BE IN GOOD CONDITION. 3. THE PROPOSED WORKS SHALL BE CONDUCTED IN ACCORDANCE WITH THE NATIONAL BUILDING CODE AND ALL APPLICABLE LAWS, DECREES, REGULATIONS, ORDINANCES, AND RESOLUTIONS. 4. THE PROPOSED WORKS SHALL BE CONDUCTED IN ACCORDANCE WITH THE NATIONAL BUILDING CODE AND ALL APPLICABLE LAWS, DECREES, REGULATIONS, ORDINANCES, AND RESOLUTIONS. 5. THE PROPOSED WORKS SHALL BE CONDUCTED IN ACCORDANCE WITH THE NATIONAL BUILDING CODE AND ALL APPLICABLE LAWS, DECREES, REGULATIONS, ORDINANCES, AND RESOLUTIONS.	PROJECT TITLE: PROPOSED EXPANSION AND IMPROVEMENT WORKS AT PASIG CITY CHILDREN'S HOSPITAL	ARCHITECTURAL: ARCH-TERY OLIVAR CHIEF ARCHITECTURAL SECTION ARCH-EMERSON ESTRADA ARCHITECT	PROGRAMMING & CONSTRUCTION: ENGR. RICHARD GANSES CHIEF OF PROJECTS ENGR. JUAN PABLO SERRA SENIOR PROJECT MANAGER	RECOMMENDING APPROVAL: ENGR. JUAN PABLO SERRA SENIOR PROJECT MANAGER ENGR. ARTAVERTES V. GERONIMO O.C. ENGINEERING DEPARTMENT	APPROVED BY: VICTOR M. REGIS N. SOTTO CITY MANAGER	SHEET CONTENTS: EXISTING SIXTH FLOOR PLAN SHEET NO.: A 15 39

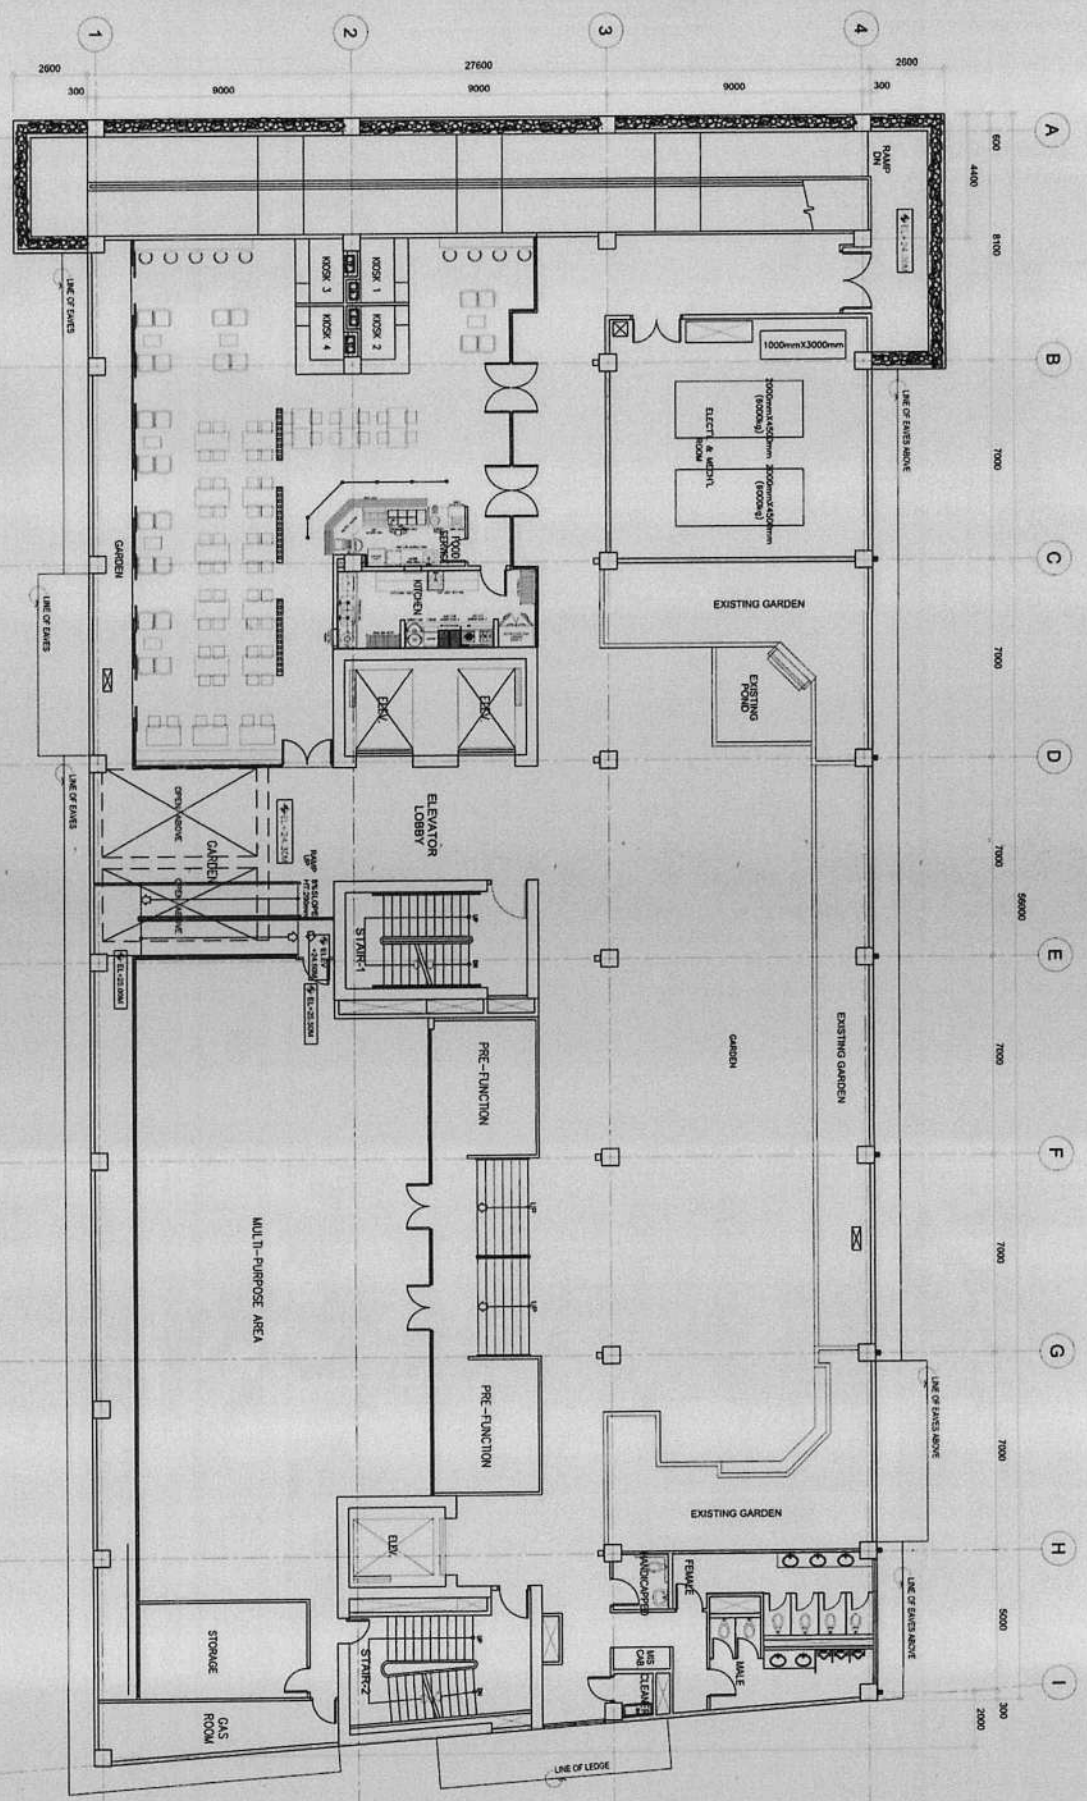

EXISTING LOWER ROOF DECK FLOOR PLAN
 SCALE 1:100



REPUBLIC OF THE PHILIPPINES
 CITY OF PASIG
 OFFICE OF THE MAYOR
 ENGINEERING DEPARTMENT

PROJECT TITLE:
**PROPOSED EXPANSION W/
 IMPROVEMENT WORKS AT
 PASIG CITY CHILDREN'S HOSPITAL**

ARCHITECTURAL:
ARCH. CELY OLIVAR
 CHIEF ARCHITECTURAL SECTION
ARCH. ELMER ESTRADA
 ARCHITECT

PROGRAMMING & CONSTRUCTION:
ENGR. JESPER BALANES
 CHIEF PROGRAMMING & CONSTRUCTION
ENGR. JUAN VEREZ
 ARCHITECT


RECOMMENDING APPROVAL:
ENGR. ROBERTO TENDILLO
 CHIEF ENGINEERING DEPARTMENT

APPROVED BY:
VICTOR MA REGIS N. SOTTO
 CITY MAYOR

SHEET CONTENTS:
ENGINEERING DEPARTMENT
SECTION 100

SHEET NO.:
A
16 / **39**

1. THIS PLAN IS THE PROPERTY OF THE ENGINEERING DEPARTMENT OF THE CITY OF PASIG. IT IS TO BE USED ONLY FOR THE PROJECT AND SITE SPECIFICALLY IDENTIFIED HEREIN. ANY REUSE OR MODIFICATION OF THIS PLAN WITHOUT THE WRITTEN PERMISSION OF THE ENGINEERING DEPARTMENT IS STRICTLY PROHIBITED.
 2. THE ENGINEER ASSUMES NO LIABILITY FOR THE ACCURACY OF THE INFORMATION PROVIDED IN THIS PLAN. THE USER OF THIS PLAN SHALL BE RESPONSIBLE FOR VERIFYING THE ACCURACY OF THE INFORMATION PROVIDED.
 3. IN CASE OF ANY DISCREPANCY BETWEEN THIS PLAN AND ANY OTHER PLAN, THIS PLAN SHALL PREVAIL.
 4. ANY MODIFICATION OF THIS PLAN SHALL BE SUBJECT TO THE APPROVAL OF THE ENGINEERING DEPARTMENT.
 5. THE ENGINEER ASSUMES NO LIABILITY FOR THE ACCURACY OF THE INFORMATION PROVIDED IN THIS PLAN. THE USER OF THIS PLAN SHALL BE RESPONSIBLE FOR VERIFYING THE ACCURACY OF THE INFORMATION PROVIDED.
 6. THE PROGRAM OF WORKS IS FOR INFORMATION PURPOSES ONLY.

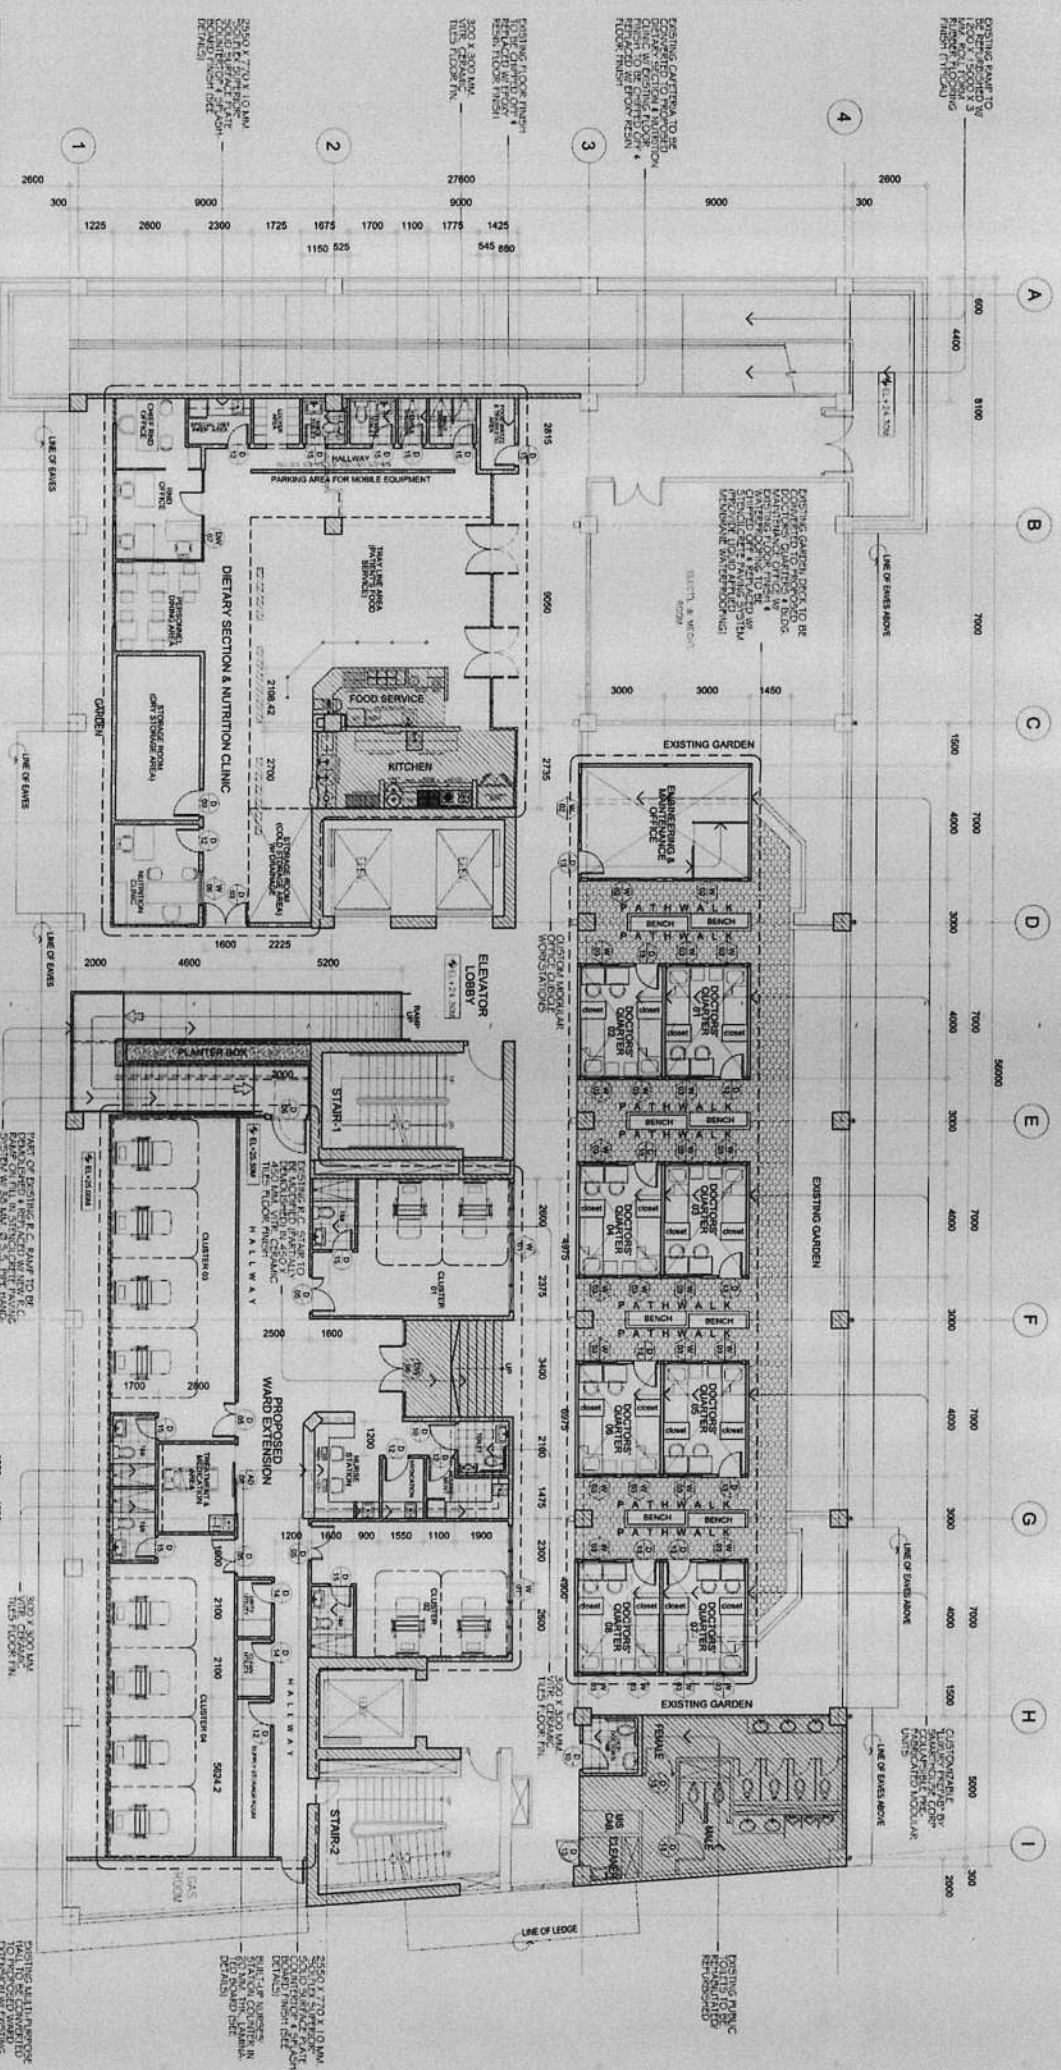

LEGEND:
 [Symbol] EXISTING CHIMNEY/RETAINED SYSTEM
 [Symbol] M2 SINGLE PANEL
 [Symbol] EXISTING OR NEW TO BE DEMOLISHED

**WITH PROPOSED REPAIR WORKS
 EXISTING LOWER ROOF DECK FLOOR PLAN**
 1:100 MBL


REPUBLIC OF THE PHILIPPINES
CITY OF PASIG
ENGINEERING DEPARTMENT

PROJECT TITLE: PROPOSED EXPANSION W/ IMPROVEMENT WORKS AT PASIG CITY CHILDREN'S HOSPITAL
ARCHITECTURAL: ARCH. ELMER C. ESTRADA
PROGRAMMING & CONSTRUCTION: ENGR. LEONARDO M. BARRALES
RECOMMENDING APPROVAL: ENGR. GERONIMO G. GONZALEZ
APPROVED BY: VICTOR M. REGIS N. SOTTO



IMPORTANT NOTES:
 1. THE CONTRACTOR SHALL BE RESPONSIBLE FOR THE ACCURACY OF THE DIMENSIONS AND THE LOCATION OF THE STRUCTURAL MEMBERS.
 2. THE CONTRACTOR SHALL BE RESPONSIBLE FOR THE ACCURACY OF THE DIMENSIONS AND THE LOCATION OF THE STRUCTURAL MEMBERS.
 3. THE CONTRACTOR SHALL BE RESPONSIBLE FOR THE ACCURACY OF THE DIMENSIONS AND THE LOCATION OF THE STRUCTURAL MEMBERS.
 4. THE CONTRACTOR SHALL BE RESPONSIBLE FOR THE ACCURACY OF THE DIMENSIONS AND THE LOCATION OF THE STRUCTURAL MEMBERS.
 5. THE CONTRACTOR SHALL BE RESPONSIBLE FOR THE ACCURACY OF THE DIMENSIONS AND THE LOCATION OF THE STRUCTURAL MEMBERS.
 6. THE CONTRACTOR SHALL BE RESPONSIBLE FOR THE ACCURACY OF THE DIMENSIONS AND THE LOCATION OF THE STRUCTURAL MEMBERS.
 7. THE CONTRACTOR SHALL BE RESPONSIBLE FOR THE ACCURACY OF THE DIMENSIONS AND THE LOCATION OF THE STRUCTURAL MEMBERS.
 8. THE CONTRACTOR SHALL BE RESPONSIBLE FOR THE ACCURACY OF THE DIMENSIONS AND THE LOCATION OF THE STRUCTURAL MEMBERS.
 9. THE CONTRACTOR SHALL BE RESPONSIBLE FOR THE ACCURACY OF THE DIMENSIONS AND THE LOCATION OF THE STRUCTURAL MEMBERS.
 10. THE CONTRACTOR SHALL BE RESPONSIBLE FOR THE ACCURACY OF THE DIMENSIONS AND THE LOCATION OF THE STRUCTURAL MEMBERS.

SHEET CONTENTS: EXISTING LOWER ROOF DECK FLOOR PLAN
SHEET NO.: A
17/39

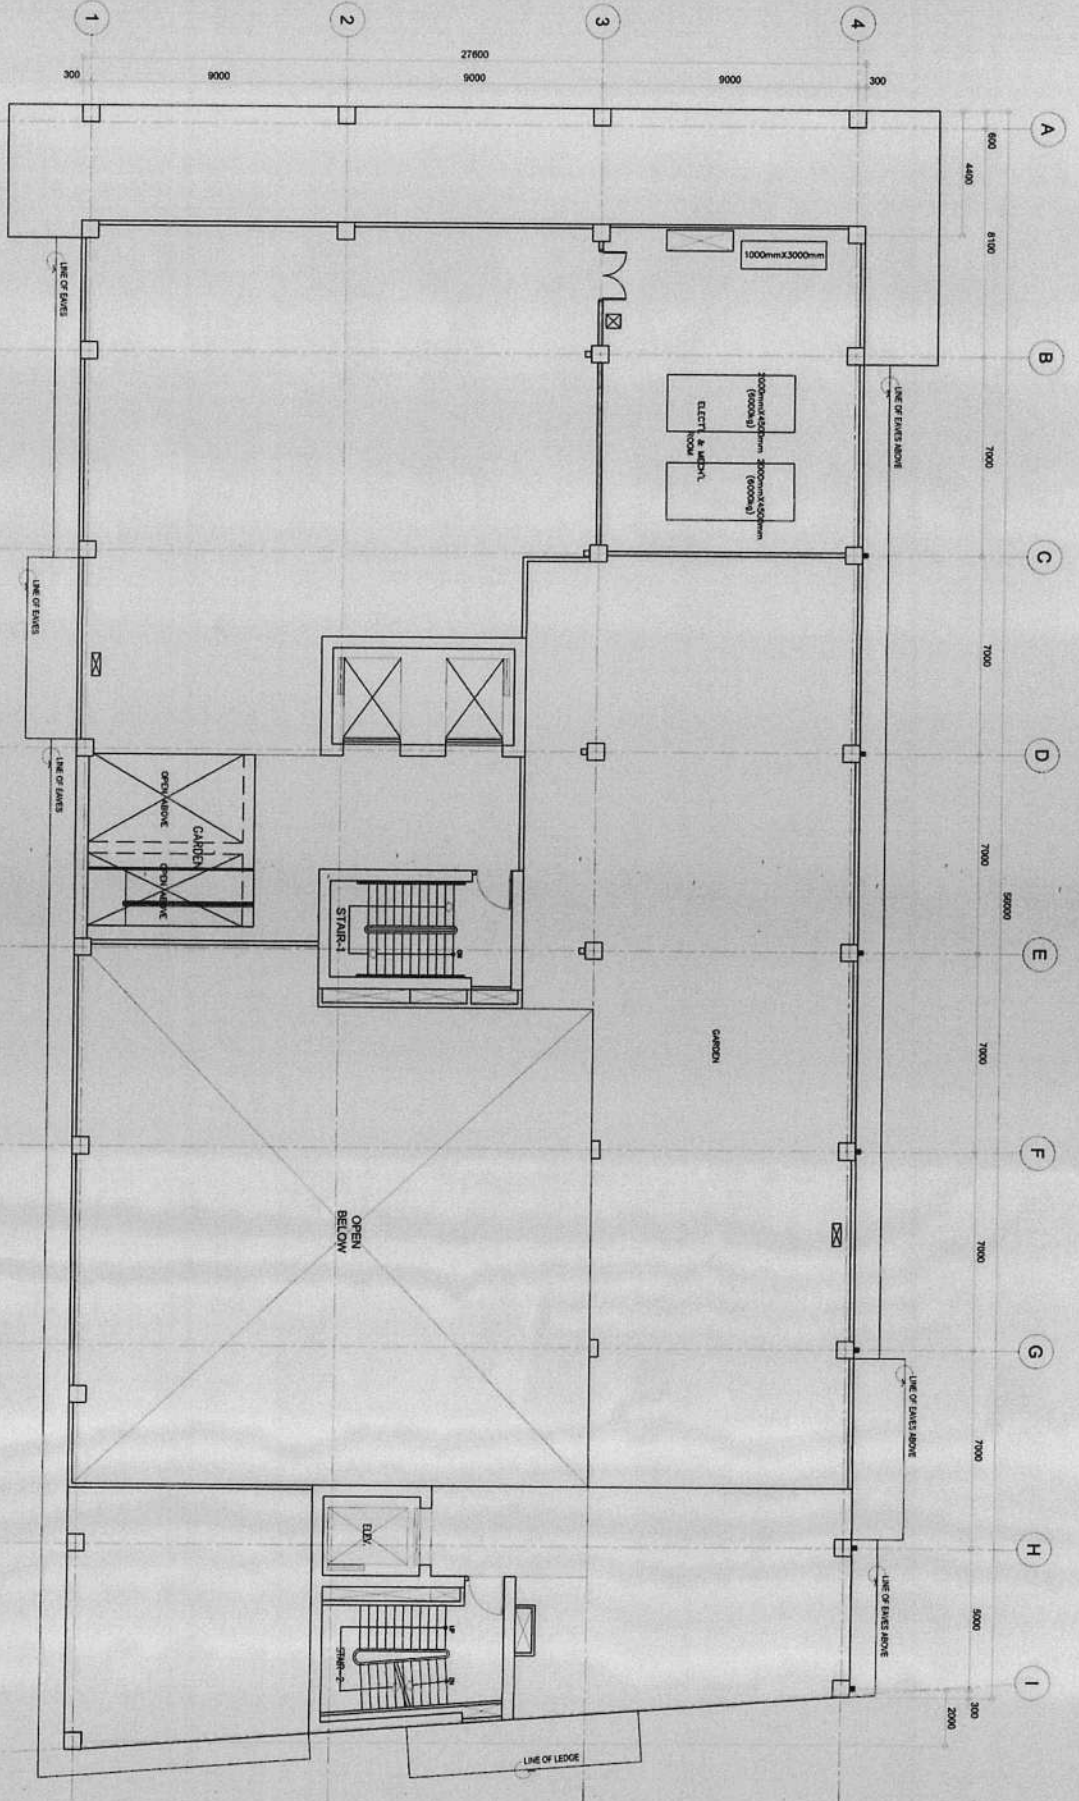

01 EXISTING UPPER ROOF DECK FLOOR PLAN
1:100 IMA



REPUBLIC OF THE PHILIPPINES
CITY OF PASIG
OFFICE OF THE MAYOR
ENGINEERING DEPARTMENT

PROJECT TITLE:
PROPOSED EXPANSION W/
IMPROVEMENT WORKS AT
PASIG CITY CHILDREN'S HOSPITAL
LOCATION: INDUSTRIAL CORP. ALICIA ST. JOSE STR.
INDUSTRIAL PARK CITY

ARCHITECTURAL:
ARCH. JEFF OLMAR
CHIEF ARCHITECT
ARCH. ELMER ESTRADA
ARCHITECT II

PROGRAMMING & CONSTRUCTION:
ENGR. JERRY SORRESES
ENGR. JERRY SORRESES
ENGR. JERRY SORRESES
ENGR. JERRY SORRESES


RECOMMENDING APPROVAL:
ENGR. ARTAXERVES V. GERONIMO
O.C. ENGINEERING DEPARTMENT

APPROVED BY:
VICTOR MA. REGIS N. SOTTO
CITY MAYOR

ADDITIONAL NOTES:
01. GOVERNING CODE SHALL BE ENGR. APPROVED PLANS & SPECIFICATIONS
02. THE PLANS SHALL BE ENGR. APPROVED PLANS & SPECIFICATIONS
03. THE PLANS SHALL BE ENGR. APPROVED PLANS & SPECIFICATIONS


SHEET CONTENTS:
UPPER ROOF DECK
SHEET NO.:
A
18 | 39

IMPORTANT NOTES:
1. THE CONTRACTOR SHALL BE RESPONSIBLE FOR OBTAINING ALL NECESSARY PERMITS AND APPROVALS FROM THE RELEVANT AGENCIES AND DEPARTMENTS.
2. THE CONTRACTOR SHALL BE RESPONSIBLE FOR OBTAINING ALL NECESSARY PERMITS AND APPROVALS FROM THE RELEVANT AGENCIES AND DEPARTMENTS.
3. THE CONTRACTOR SHALL BE RESPONSIBLE FOR OBTAINING ALL NECESSARY PERMITS AND APPROVALS FROM THE RELEVANT AGENCIES AND DEPARTMENTS.
4. THE CONTRACTOR SHALL BE RESPONSIBLE FOR OBTAINING ALL NECESSARY PERMITS AND APPROVALS FROM THE RELEVANT AGENCIES AND DEPARTMENTS.

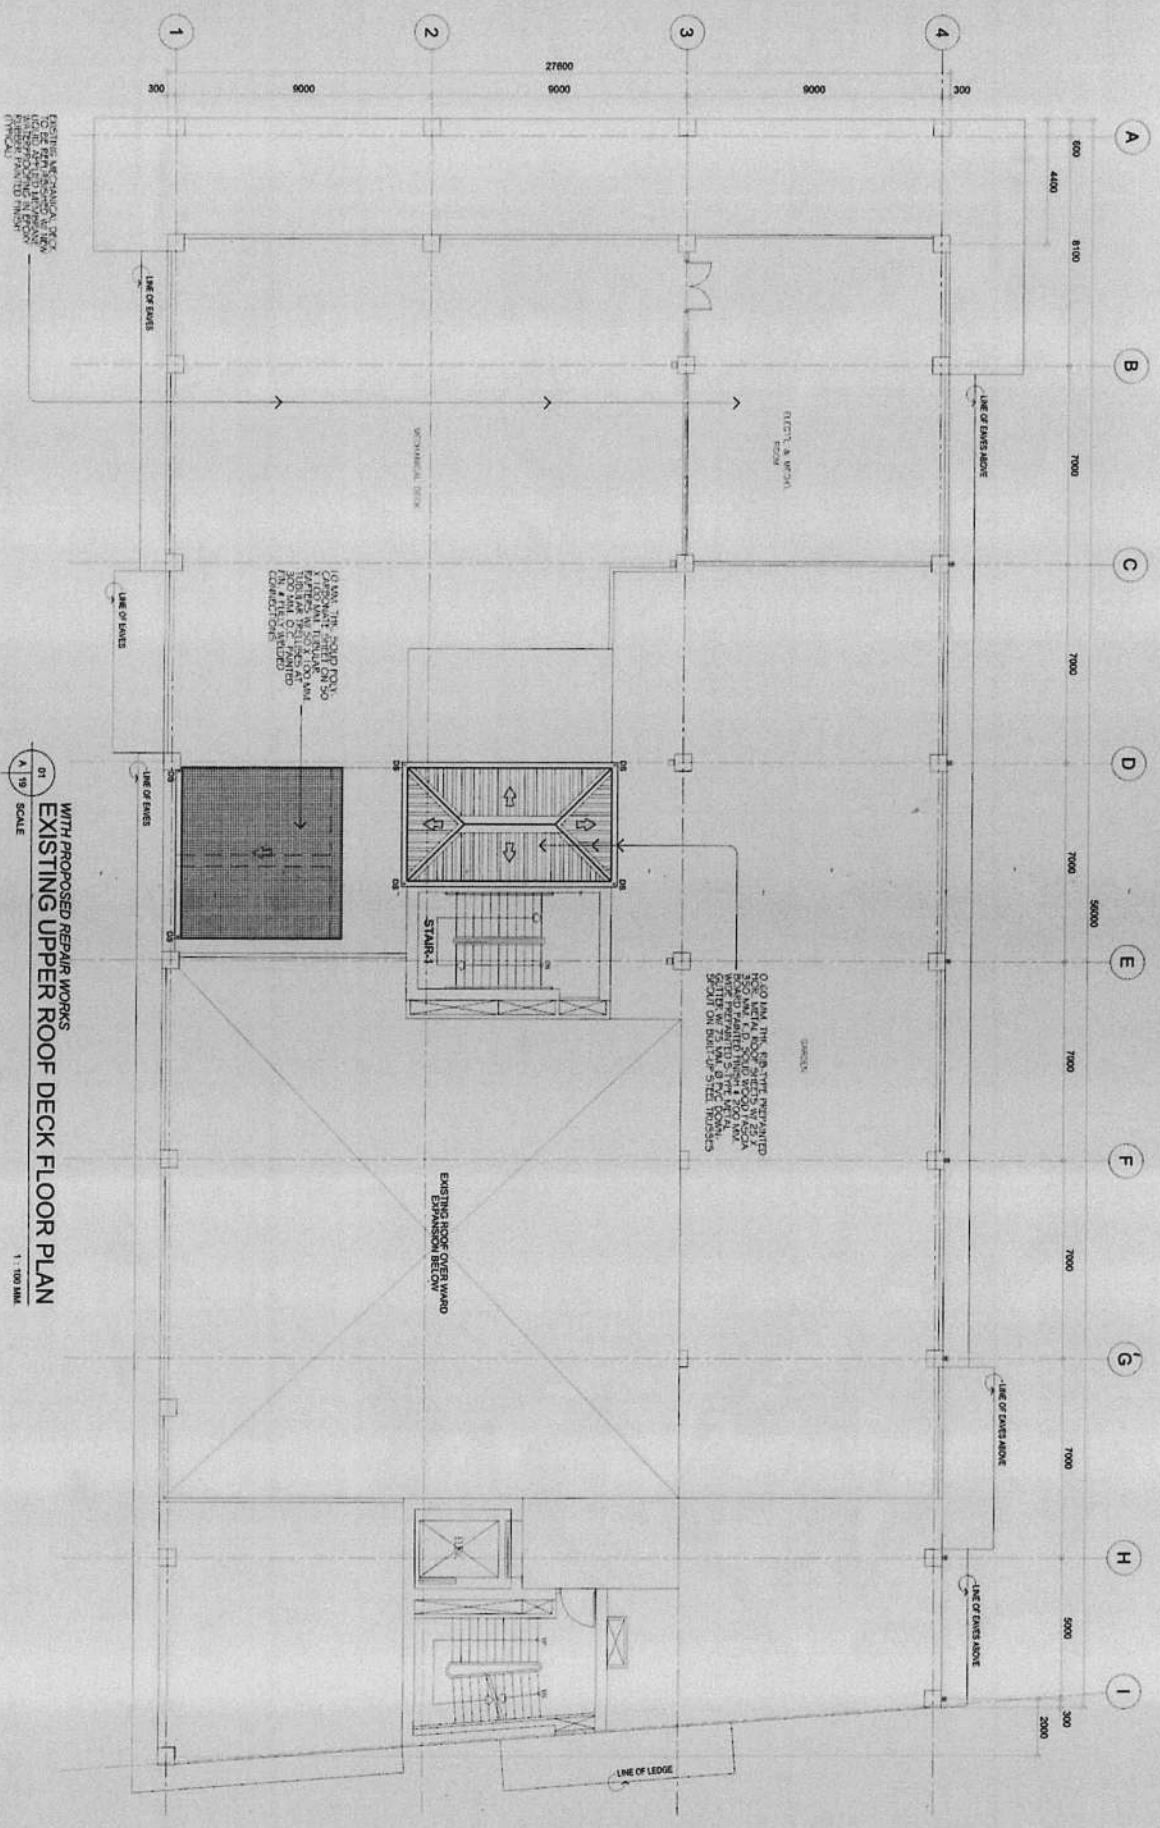


WITH PROPOSED REPAIR WORKS
 EXISTING UPPER ROOF DECK FLOOR PLAN
 SCALE 1:100 MAX

	REPUBLIC OF THE PHILIPPINES OFFICE OF THE MAYOR ENGINEERING DEPARTMENT	PROJECT TITLE: PROPOSED EXPANSION W/ IMPROVEMENT WORKS AT PASIG CITY CHILDREN'S HOSPITAL	ARCHITECTURAL: ARCH. GENY OLIVAR CHIEF ARCHITECTURAL ACTION ARCH. EDMUND ESTRADA ARCHITECT	PROGRAMMING & CONSTRUCTION: ENGR. JOSE M. GABRIEL CHIEF PROGRAMMING & CONSTRUCTION ENGR. JOSE M. GABRIEL CHIEF PROGRAMMING & CONSTRUCTION	RECOMMENDING APPROVAL: ENGR. EMILIO M. RIVERA CHIEF RECOMMENDING APPROVAL ENGR. EMILIO M. RIVERA CHIEF RECOMMENDING APPROVAL	APPROVED BY: VICTOR M. REGIS N. SOTTO CITY MAYOR	SHEET CONTENTS: EXISTING UPPER ROOF DECK FLOOR PLAN WITH PROPOSED REPAIR WORKS	SHEET NO.: A 19 39
	IMPORTANT NOTES: 1. NO ALTERATIONS SHALL BE MADE TO THE ORIGINAL PLAN WITHOUT THE WRITTEN PERMISSION OF THE ARCHITECT. 2. THE CONTRACTOR SHALL BE RESPONSIBLE FOR OBTAINING ALL NECESSARY PERMITS AND APPROVALS FROM THE APPROPRIATE AGENCIES. 3. THE CONTRACTOR SHALL BE RESPONSIBLE FOR OBTAINING ALL NECESSARY PERMITS AND APPROVALS FROM THE APPROPRIATE AGENCIES. 4. THE CONTRACTOR SHALL BE RESPONSIBLE FOR OBTAINING ALL NECESSARY PERMITS AND APPROVALS FROM THE APPROPRIATE AGENCIES. 5. THE CONTRACTOR SHALL BE RESPONSIBLE FOR OBTAINING ALL NECESSARY PERMITS AND APPROVALS FROM THE APPROPRIATE AGENCIES. 6. THE CONTRACTOR SHALL BE RESPONSIBLE FOR OBTAINING ALL NECESSARY PERMITS AND APPROVALS FROM THE APPROPRIATE AGENCIES. 7. THE CONTRACTOR SHALL BE RESPONSIBLE FOR OBTAINING ALL NECESSARY PERMITS AND APPROVALS FROM THE APPROPRIATE AGENCIES. 8. THE CONTRACTOR SHALL BE RESPONSIBLE FOR OBTAINING ALL NECESSARY PERMITS AND APPROVALS FROM THE APPROPRIATE AGENCIES. 9. THE CONTRACTOR SHALL BE RESPONSIBLE FOR OBTAINING ALL NECESSARY PERMITS AND APPROVALS FROM THE APPROPRIATE AGENCIES. 10. THE CONTRACTOR SHALL BE RESPONSIBLE FOR OBTAINING ALL NECESSARY PERMITS AND APPROVALS FROM THE APPROPRIATE AGENCIES.							

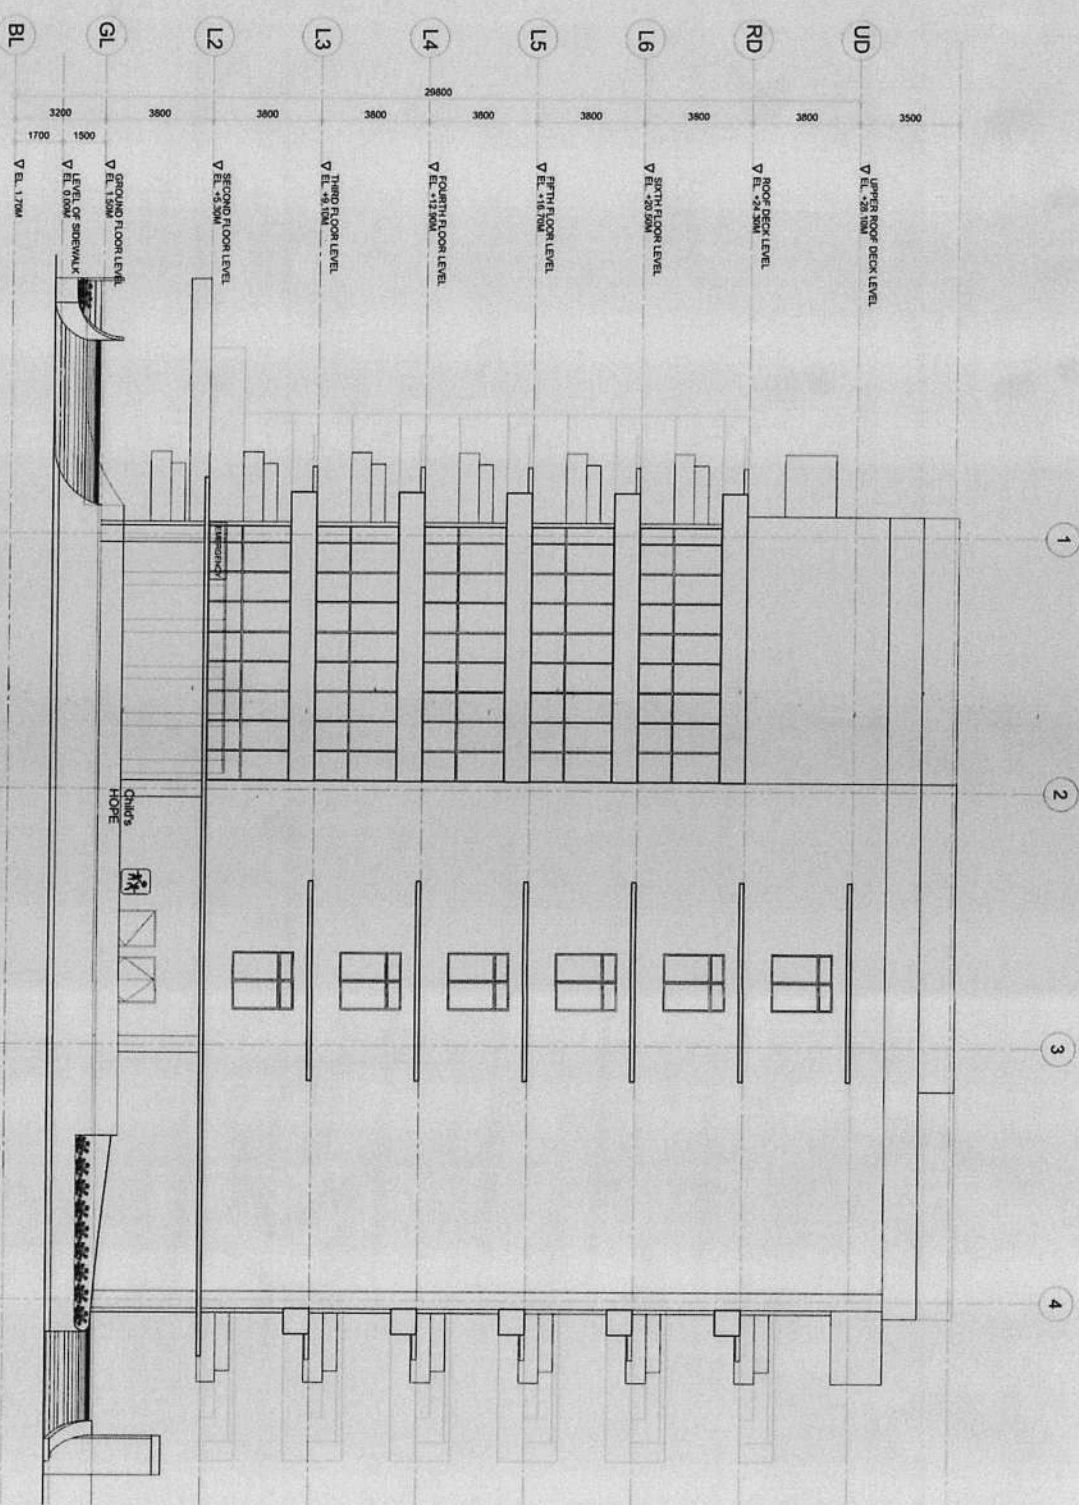


RIGHT SIDE ELEVATION
SCALE 1:100 MM

 <p>REPUBLIC OF THE PHILIPPINES CITY OF PASIG OFFICE OF THE MAYOR ENGINEERING DEPARTMENT</p>	<p>PROJECT TITLE: PROPOSED EXPANSION W/ IMPROVEMENT WORKS AT PASIG CITY CHILDREN'S HOSPITAL</p> <p>LOCATION: NORTHERN CROSS ALICIA JOSE STS. MARIANAS, PASIG CITY</p>	<p>ARCHITECTURAL: ARCHITECT: ARCH. ENR. OLVAR O. ESTERUA</p>	<p>PROGRAMMING & CONSTRUCTION: ENGR. ENR. ERNESTO V. RANESSES</p>	<p>RECOMMENDING APPROVAL: ENGR. ENR. GERMARDO V. GONZALEZ</p>	<p>ENGR. ENR. ARTAVERDES V. GERONIMO</p>	<p>APPROVED BY: VICTOR MA. REGIS M. SOTTO CITY MAYOR</p>	<p>SHEET CONTENTS: RIGHT SIDE ELEVATION</p> <p>SHEET NO.: A 21 39</p>
---	--	---	--	--	---	---	--


IMPORTANT NOTES:

1. ALL MATERIALS, FINISHES AND WORKMANSHIP SHALL BE IN ACCORDANCE WITH THE SPECIFICATIONS AND STANDARDS OF THE ARCHITECT AND ENGINEER.
2. THE CONTRACTOR SHALL BE RESPONSIBLE FOR OBTAINING ALL NECESSARY PERMITS AND APPROVALS FROM THE CITY ENGINEERING DEPARTMENT AND THE CITY PLANNING AND ZONING OFFICE.
3. THE CONTRACTOR SHALL BE RESPONSIBLE FOR OBTAINING ALL NECESSARY PERMITS AND APPROVALS FROM THE CITY ENGINEERING DEPARTMENT AND THE CITY PLANNING AND ZONING OFFICE.
4. THE CONTRACTOR SHALL BE RESPONSIBLE FOR OBTAINING ALL NECESSARY PERMITS AND APPROVALS FROM THE CITY ENGINEERING DEPARTMENT AND THE CITY PLANNING AND ZONING OFFICE.
5. THE CONTRACTOR SHALL BE RESPONSIBLE FOR OBTAINING ALL NECESSARY PERMITS AND APPROVALS FROM THE CITY ENGINEERING DEPARTMENT AND THE CITY PLANNING AND ZONING OFFICE.
6. THE CONTRACTOR SHALL BE RESPONSIBLE FOR OBTAINING ALL NECESSARY PERMITS AND APPROVALS FROM THE CITY ENGINEERING DEPARTMENT AND THE CITY PLANNING AND ZONING OFFICE.
7. THE CONTRACTOR SHALL BE RESPONSIBLE FOR OBTAINING ALL NECESSARY PERMITS AND APPROVALS FROM THE CITY ENGINEERING DEPARTMENT AND THE CITY PLANNING AND ZONING OFFICE.
8. THE CONTRACTOR SHALL BE RESPONSIBLE FOR OBTAINING ALL NECESSARY PERMITS AND APPROVALS FROM THE CITY ENGINEERING DEPARTMENT AND THE CITY PLANNING AND ZONING OFFICE.
9. THE CONTRACTOR SHALL BE RESPONSIBLE FOR OBTAINING ALL NECESSARY PERMITS AND APPROVALS FROM THE CITY ENGINEERING DEPARTMENT AND THE CITY PLANNING AND ZONING OFFICE.
10. THE CONTRACTOR SHALL BE RESPONSIBLE FOR OBTAINING ALL NECESSARY PERMITS AND APPROVALS FROM THE CITY ENGINEERING DEPARTMENT AND THE CITY PLANNING AND ZONING OFFICE.

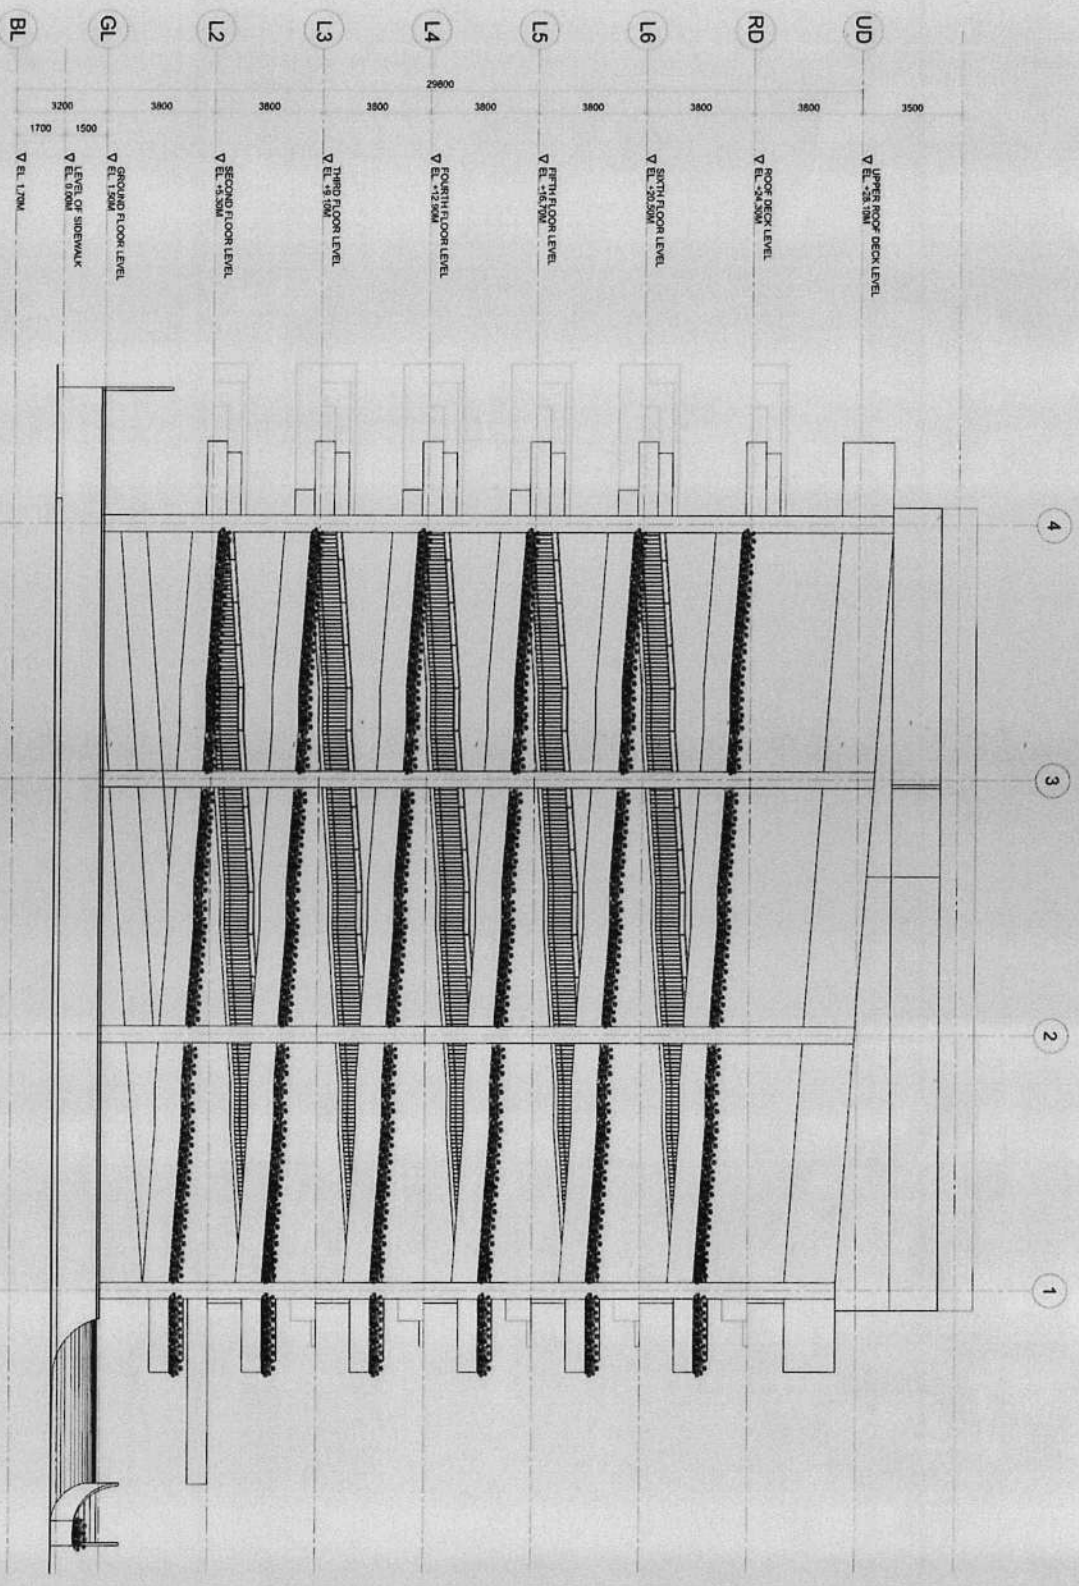



01
A 22
SCALE
LEFT SIDE ELEVATION
1 : 100 MM

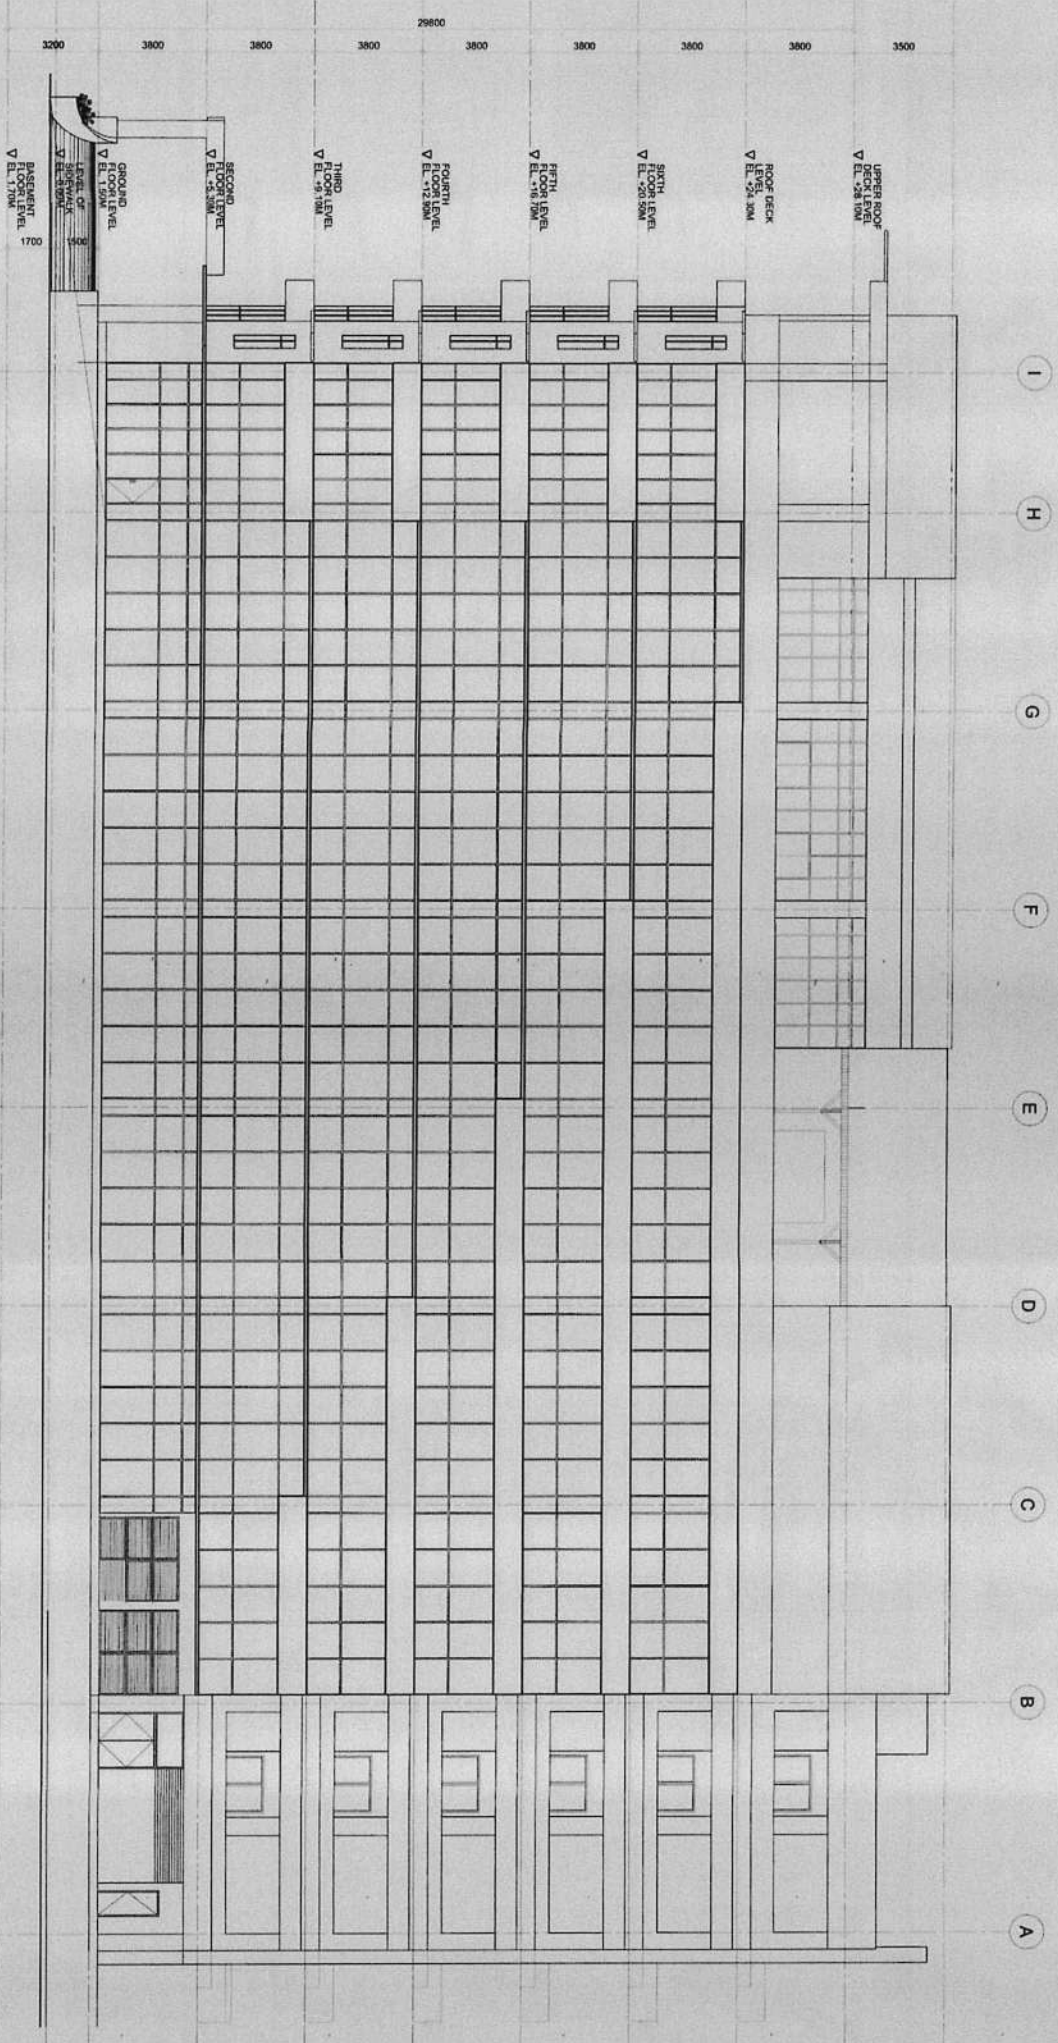
<p>REPUBLIC OF THE PHILIPPINES CITY OF PASIG OFFICE OF THE MAYOR ENGINEERING DEPARTMENT</p>	<p>PROJECT TITLE: PROPOSED EXPANSION W/ IMPROVEMENT WORKS AT PASIG CITY CHILDREN'S HOSPITAL</p>	<p>ARCHITECTURAL: ARCH. LEYLA OLIVAR CHIEF ARCHITECTURAL SECTION <i>[Signature]</i></p>	<p>PROGRAMMING & CONSTRUCTION: ENGR. ISMAEL V. BRANDES CHIEF TECHNICAL PROJECT <i>[Signature]</i></p>	<p>RECOMMENDING APPROVAL: ENGR. FREDERICO V. FERRER CHIEF ENGINEER <i>[Signature]</i></p>	<p>APPROVED BY: VICTOR MA. REGIS N. SOTTO CITY MAYOR <i>[Signature]</i></p>	<p>SHEET CONTENTS: LEFT SIDE ELEVATION</p>	<p>SHEET NO.: A 22 39</p>
	<p>LOCATION: INDUSTRIAL COR. ALCALDE JOSE STS. PASIG CITY</p>	<p>1. CONSULTATION OF ALL APPLICABLE SPECIFICATIONS SHALL BE MADE PRIOR TO THE SUBMISSION OF THE PROJECT TO THE ENGINEERING DEPARTMENT. 2. CONSULTATION OF THE CITY ENGINEER SHALL BE MADE PRIOR TO THE SUBMISSION OF THE PROJECT TO THE CITY ENGINEER. 3. TO THE EXTENT OF THE PROJECT, THE CONTRACTOR SHALL BE RESPONSIBLE FOR THE PROVISION OF ALL NECESSARY PERMITS AND APPROVALS. 4. THE PROVISION OF WORKS IS FOR INFORMATION PURPOSES ONLY.</p>	<p>1. THE CONTRACTOR SHALL BE RESPONSIBLE FOR THE PROVISION OF ALL NECESSARY PERMITS AND APPROVALS. 2. THE CONTRACTOR SHALL BE RESPONSIBLE FOR THE PROVISION OF ALL NECESSARY PERMITS AND APPROVALS. 3. THE CONTRACTOR SHALL BE RESPONSIBLE FOR THE PROVISION OF ALL NECESSARY PERMITS AND APPROVALS. 4. THE CONTRACTOR SHALL BE RESPONSIBLE FOR THE PROVISION OF ALL NECESSARY PERMITS AND APPROVALS.</p>				



01 REAR ELEVATION
SCALE 1:100 MAX

 REPUBLIC OF THE PHILIPPINES CITY OF PASIG ENGINEERING DEPARTMENT	PROJECT TITLE	ARCHITECTURAL	PROGRAMMING & CONSTRUCTION	RECOMMENDING APPROVAL	APPROVED BY	SHEET CONTENTS	SHEET NO.
	PROPOSED EXPANSION W/ IMPROVEMENT WORKS AT PASIG CITY CHILDREN'S HOSPITAL LOCATION: INDUSTRIAL COR. ALCALDE JOSE STS. NARISAL PASIG CITY	ARCH. LEVI OLIVAR CHIEF ARCHITECTURAL SECTION ARCH. EDUARDO ESTRADA ARCHITECT	ENGR. ISABEL BARRALES CHIEF ARCHITECTURAL SECTION ENGR. EDUARDO PEREZ ARCHITECT	ENGR. ARTABERRES Y GERONIMO OIC, Engineering Department	VICTOR MA. REGIS N. SOTTO CITY MAYOR	REAR ELEVATION 	A 23 39


1. NO ALTERATION IN THE ORIGINAL DESIGN SHALL BE MADE WITHOUT THE WRITTEN APPROVAL OF THE ARCHITECT AND ENGINEER IN CHARGE.
 2. THE CONTRACTOR SHALL BE RESPONSIBLE FOR THE PROTECTION OF THE EXISTING UTILITIES AND STRUCTURES.
 3. THE CONTRACTOR SHALL BE RESPONSIBLE FOR THE PROTECTION OF THE EXISTING UTILITIES AND STRUCTURES.
 4. THE CONTRACTOR SHALL BE RESPONSIBLE FOR THE PROTECTION OF THE EXISTING UTILITIES AND STRUCTURES.
 5. THE CONTRACTOR SHALL BE RESPONSIBLE FOR THE PROTECTION OF THE EXISTING UTILITIES AND STRUCTURES.
 6. THE CONTRACTOR SHALL BE RESPONSIBLE FOR THE PROTECTION OF THE EXISTING UTILITIES AND STRUCTURES.
 7. THE CONTRACTOR SHALL BE RESPONSIBLE FOR THE PROTECTION OF THE EXISTING UTILITIES AND STRUCTURES.
 8. THE CONTRACTOR SHALL BE RESPONSIBLE FOR THE PROTECTION OF THE EXISTING UTILITIES AND STRUCTURES.
 9. THE CONTRACTOR SHALL BE RESPONSIBLE FOR THE PROTECTION OF THE EXISTING UTILITIES AND STRUCTURES.

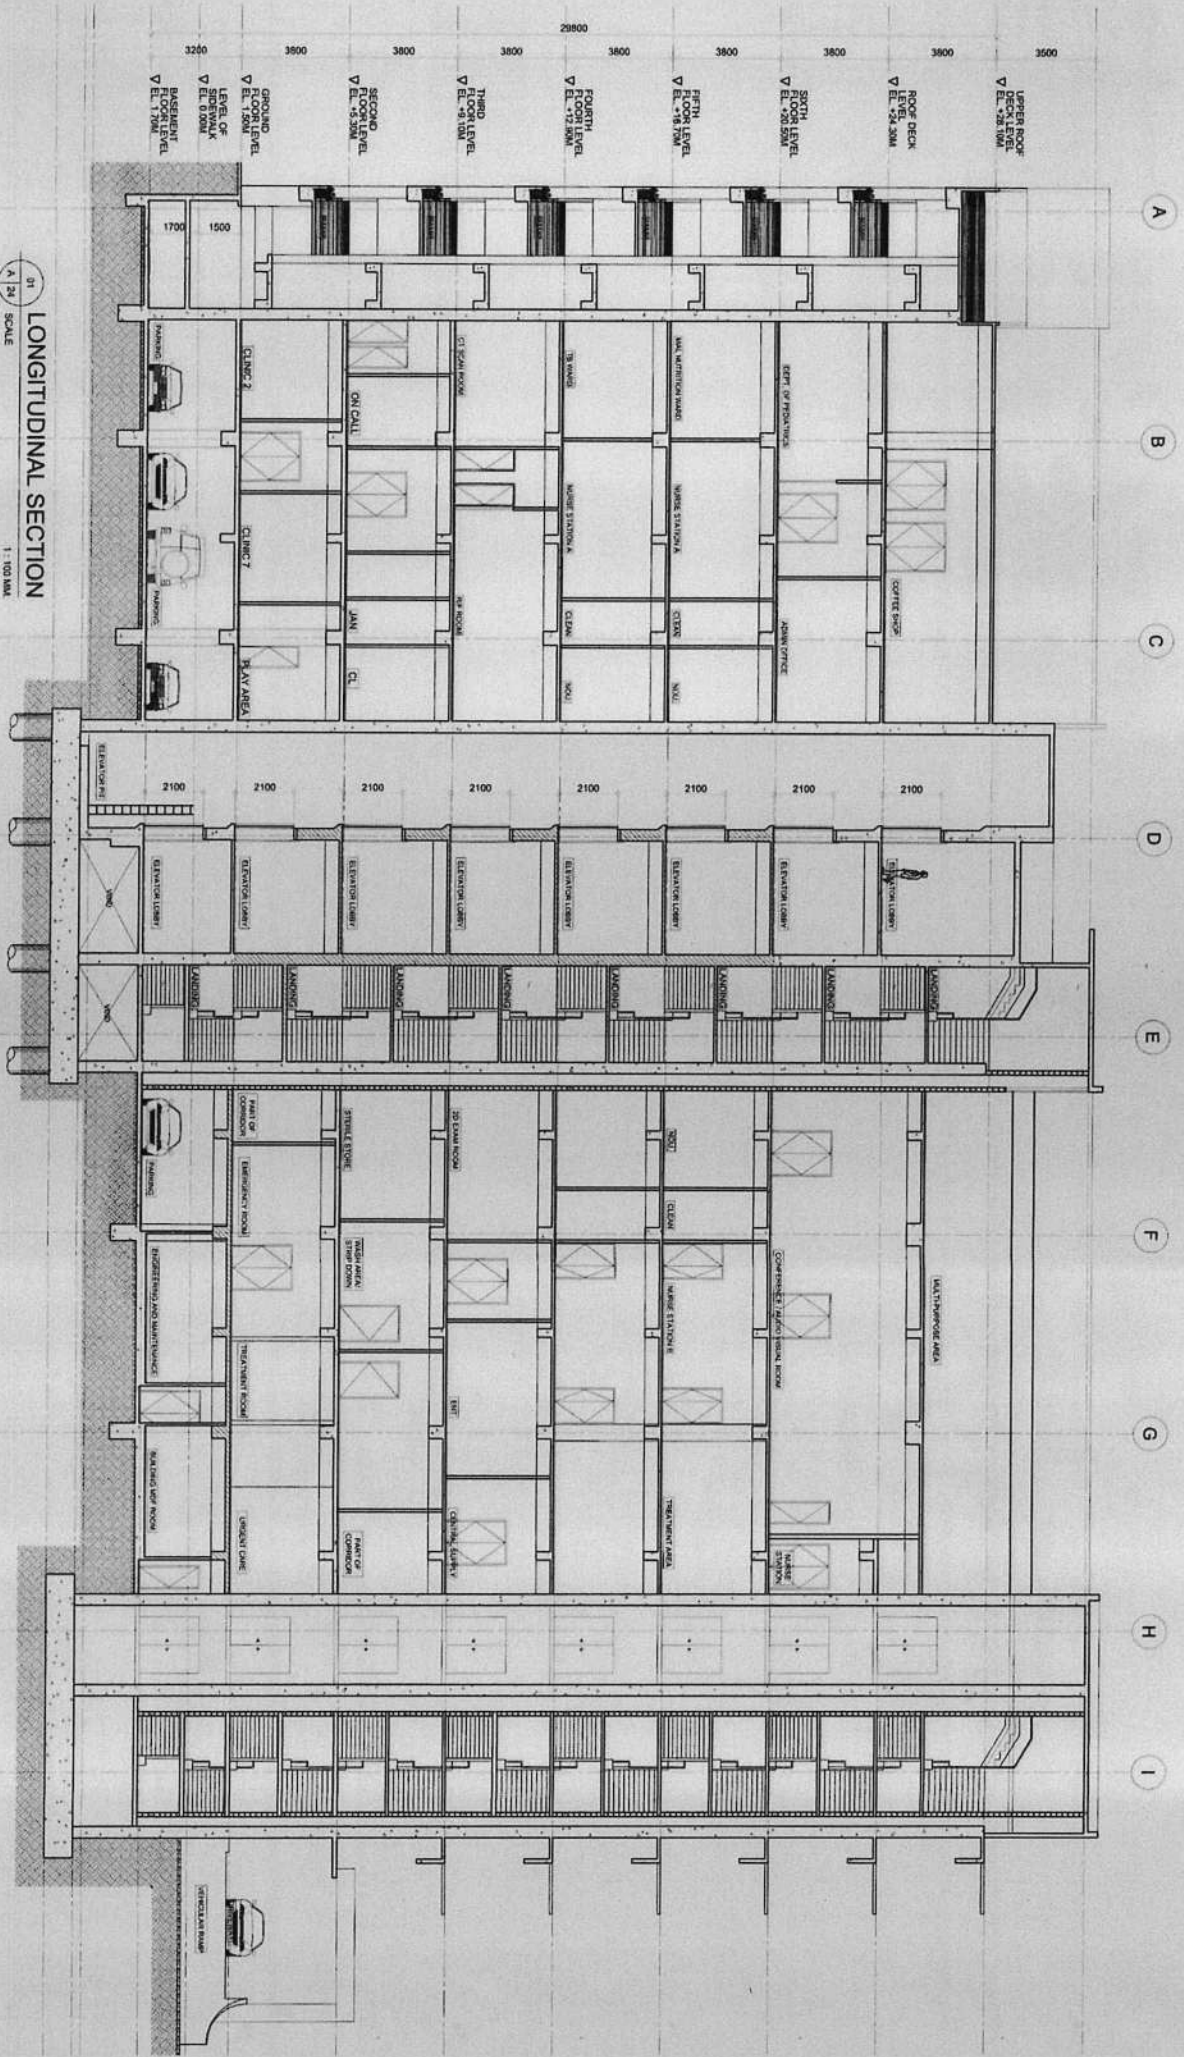

REPUBLIC OF THE PHILIPPINES CITY OF PASIG OFFICE OF THE MAYOR ENGINEERING DEPARTMENT		PROJECT TITLE: PROPOSED EXPANSION WITH IMPROVEMENT WORKS AT PASIG CITY CHILDREN'S HOSPITAL		ARCHITECTURAL: ARCHITECT: ARCH. ENGR. V. OLIVAR PROJECT ARCHITECT: ARCH. ENGR. C. ESTRADA		PROGRAMMING & CONSTRUCTION: ENGR. ISABEL PANSESES ENGR. JUAN MANUEL TORRES ENGR. JONATHAN V. TORRES ENGR. JONATHAN V. TORRES		RECOMMENDING APPROVAL: ENGR. ERIC C. PRUDENCIO ENGR. ARTAVERTES V. GERONIMO		APPROVED BY: VICTOR M.A. REGAS N. SOTTO CITY MAYOR	
RECOMMENDATIONS: 1. NO ALTERATION IN AREA & PERCENTAGE SHALL BE MADE IN THE ORIGINAL PLAN. 2. THE CONTRACTOR SHALL BE RESPONSIBLE FOR THE PROTECTION OF THE EXISTING UTILITIES AND STRUCTURES.		LOCATION: INDUSTRIAL COR. ALONSO JOSUE STS. PASIG CITY		ARCHITECTURAL: ARCHITECT: ARCH. ENGR. V. OLIVAR PROJECT ARCHITECT: ARCH. ENGR. C. ESTRADA		PROGRAMMING & CONSTRUCTION: ENGR. ISABEL PANSESES ENGR. JUAN MANUEL TORRES ENGR. JONATHAN V. TORRES ENGR. JONATHAN V. TORRES		RECOMMENDING APPROVAL: ENGR. ERIC C. PRUDENCIO ENGR. ARTAVERTES V. GERONIMO		APPROVED BY: VICTOR M.A. REGAS N. SOTTO CITY MAYOR	
RECOMMENDATIONS: 1. NO ALTERATION IN AREA & PERCENTAGE SHALL BE MADE IN THE ORIGINAL PLAN. 2. THE CONTRACTOR SHALL BE RESPONSIBLE FOR THE PROTECTION OF THE EXISTING UTILITIES AND STRUCTURES.		LOCATION: INDUSTRIAL COR. ALONSO JOSUE STS. PASIG CITY		ARCHITECTURAL: ARCHITECT: ARCH. ENGR. V. OLIVAR PROJECT ARCHITECT: ARCH. ENGR. C. ESTRADA		PROGRAMMING & CONSTRUCTION: ENGR. ISABEL PANSESES ENGR. JUAN MANUEL TORRES ENGR. JONATHAN V. TORRES ENGR. JONATHAN V. TORRES		RECOMMENDING APPROVAL: ENGR. ERIC C. PRUDENCIO ENGR. ARTAVERTES V. GERONIMO		APPROVED BY: VICTOR M.A. REGAS N. SOTTO CITY MAYOR	
RECOMMENDATIONS: 1. NO ALTERATION IN AREA & PERCENTAGE SHALL BE MADE IN THE ORIGINAL PLAN. 2. THE CONTRACTOR SHALL BE RESPONSIBLE FOR THE PROTECTION OF THE EXISTING UTILITIES AND STRUCTURES.		LOCATION: INDUSTRIAL COR. ALONSO JOSUE STS. PASIG CITY		ARCHITECTURAL: ARCHITECT: ARCH. ENGR. V. OLIVAR PROJECT ARCHITECT: ARCH. ENGR. C. ESTRADA		PROGRAMMING & CONSTRUCTION: ENGR. ISABEL PANSESES ENGR. JUAN MANUEL TORRES ENGR. JONATHAN V. TORRES ENGR. JONATHAN V. TORRES		RECOMMENDING APPROVAL: ENGR. ERIC C. PRUDENCIO ENGR. ARTAVERTES V. GERONIMO		APPROVED BY: VICTOR M.A. REGAS N. SOTTO CITY MAYOR	

RECOMMENDATIONS:


- NO ALTERATION IN AREA & PERCENTAGE SHALL BE MADE IN THE ORIGINAL PLAN.
- THE CONTRACTOR SHALL BE RESPONSIBLE FOR THE PROTECTION OF THE EXISTING UTILITIES AND STRUCTURES.
- NO ALTERATION IN AREA & PERCENTAGE SHALL BE MADE IN THE ORIGINAL PLAN.
- THE CONTRACTOR SHALL BE RESPONSIBLE FOR THE PROTECTION OF THE EXISTING UTILITIES AND STRUCTURES.
- NO ALTERATION IN AREA & PERCENTAGE SHALL BE MADE IN THE ORIGINAL PLAN.
- THE CONTRACTOR SHALL BE RESPONSIBLE FOR THE PROTECTION OF THE EXISTING UTILITIES AND STRUCTURES.
- NO ALTERATION IN AREA & PERCENTAGE SHALL BE MADE IN THE ORIGINAL PLAN.
- THE CONTRACTOR SHALL BE RESPONSIBLE FOR THE PROTECTION OF THE EXISTING UTILITIES AND STRUCTURES.

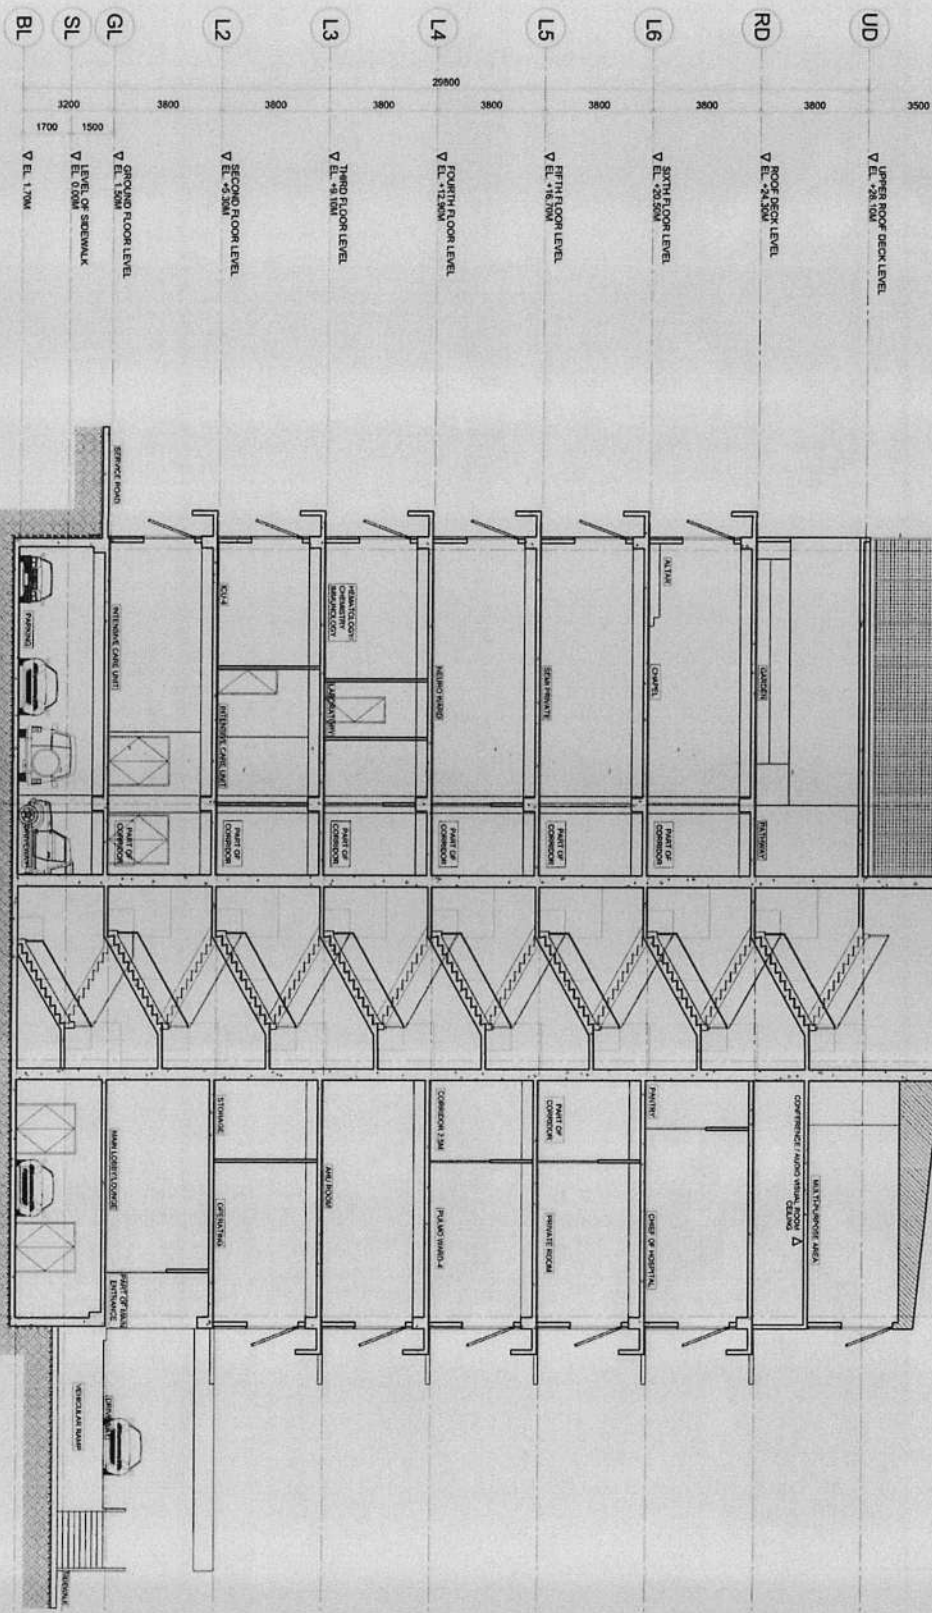


CROSS SECTION
 01
 A 25 / SCALE
 1:100 MM

	REPUBLIC OF THE PHILIPPINES CITY OF PASIG OFFICE OF THE MAYOR ENGINEERING DEPARTMENT	PROJECT TITLE: PROPOSED EXPANSION W/ IMPROVEMENT WORKS AT PASIG CITY CHILDREN'S HOSPITAL	ARCHITECTURAL: ARCH. EMMANUEL C. ESTRADE ARCHITECT	PROGRAMMING & CONSTRUCTION: ENGR. GREGORIO R. RANESSES ARCHITECT	RECOMMENDING APPROVAL: ENGR. EDUARDO S. PRUDENCIO CIVIL ENGINEER	APPROVED BY: VICTOR MA. REGIS N. SOTTO CITY MAYOR	SHEET CONTENTS: CROSS SECTION	SHEET NO.: A 25 39
	LOCATION: INDUSTRIAL COR. AT CALCE JOSE STS.	1. REVISIONS TO THE DRAWING SHALL BE MADE IN THE MANNER AND FORM APPROVED BY THE ARCHITECT AND THE ENGINEER. 2. IN THE EVENT OF A DISCREPANCY BETWEEN THE DRAWING AND THE SPECIFICATIONS, THE DRAWING SHALL TAKE PRECEDENCE. 3. ALL WORK SHALL BE DONE IN ACCORDANCE WITH THE LATEST EDITIONS OF THE NATIONAL BUILDING CODE AND OTHER APPLICABLE LAWS AND REGULATIONS. 4. THE CONTRACTOR SHALL BE RESPONSIBLE FOR OBTAINING ALL NECESSARY PERMITS AND APPROVALS FROM THE APPROPRIATE AGENCIES. 5. THE CONTRACTOR SHALL BE RESPONSIBLE FOR THE PROTECTION OF ALL EXISTING UTILITIES AND STRUCTURES. 6. THE CONTRACTOR SHALL BE RESPONSIBLE FOR THE PROTECTION OF ALL EXISTING TREES AND LANDSCAPE. 7. THE CONTRACTOR SHALL BE RESPONSIBLE FOR THE PROTECTION OF ALL EXISTING HISTORICAL MONUMENTS AND STRUCTURES. 8. THE CONTRACTOR SHALL BE RESPONSIBLE FOR THE PROTECTION OF ALL EXISTING CULTURAL HERITAGE. 9. THE CONTRACTOR SHALL BE RESPONSIBLE FOR THE PROTECTION OF ALL EXISTING ENVIRONMENTAL FEATURES. 10. THE CONTRACTOR SHALL BE RESPONSIBLE FOR THE PROTECTION OF ALL EXISTING SOCIAL SERVICES. 11. THE CONTRACTOR SHALL BE RESPONSIBLE FOR THE PROTECTION OF ALL EXISTING COMMUNITY ASSETS. 12. THE CONTRACTOR SHALL BE RESPONSIBLE FOR THE PROTECTION OF ALL EXISTING PUBLIC UTILITIES. 13. THE CONTRACTOR SHALL BE RESPONSIBLE FOR THE PROTECTION OF ALL EXISTING TRANSPORTATION NETWORKS. 14. THE CONTRACTOR SHALL BE RESPONSIBLE FOR THE PROTECTION OF ALL EXISTING INFRASTRUCTURE. 15. THE CONTRACTOR SHALL BE RESPONSIBLE FOR THE PROTECTION OF ALL EXISTING UTILITIES AND STRUCTURES.						


10) MAX. THE CLEAR GLASS DOUBLE SLING TYPE DOOR WITHED SHIF. GLASS TRANSPARENT WINDOW PANELS BY 100 MM. WITH GLASS RAIL STRIPS AT 150 MM. O.C. + 30 MM. Ø ON POWDER COATED EXTRUDED ALUMINIUM (1-1-SECT)

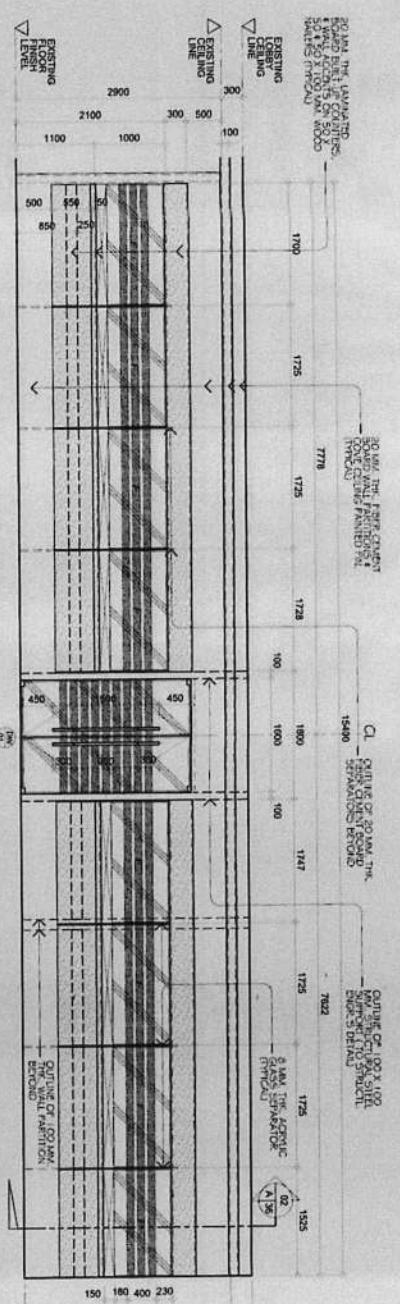


11) MAX. THE CLEAR GLASS DOUBLE SLING TYPE DOOR WITHED SHIF. GLASS TRANSPARENT WINDOW PANELS BY 100 MM. WITH GLASS RAIL STRIPS AT 150 MM. O.C. + 30 MM. Ø ON POWDER COATED EXTRUDED ALUMINIUM (1-1-SECT)

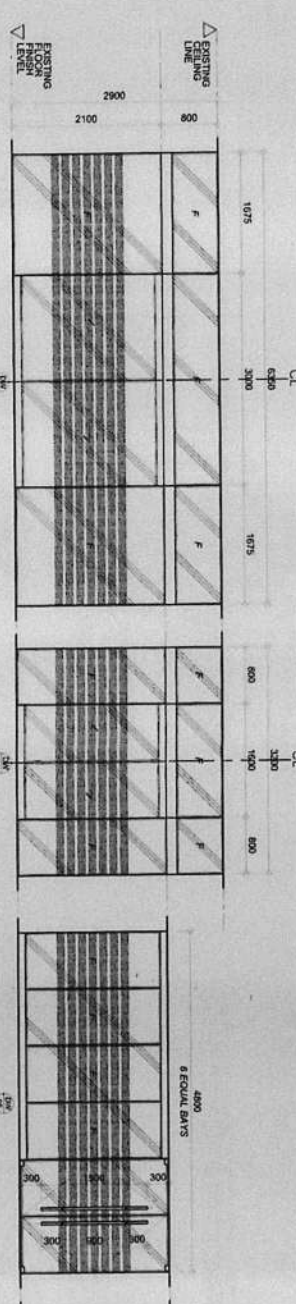

12) MAX. THE CLEAR GLASS DOUBLE SLING TYPE DOOR WITHED SHIF. GLASS TRANSPARENT WINDOW PANELS BY 100 MM. WITH GLASS RAIL STRIPS AT 150 MM. O.C. + 30 MM. Ø ON POWDER COATED EXTRUDED ALUMINIUM (1-1-SECT)

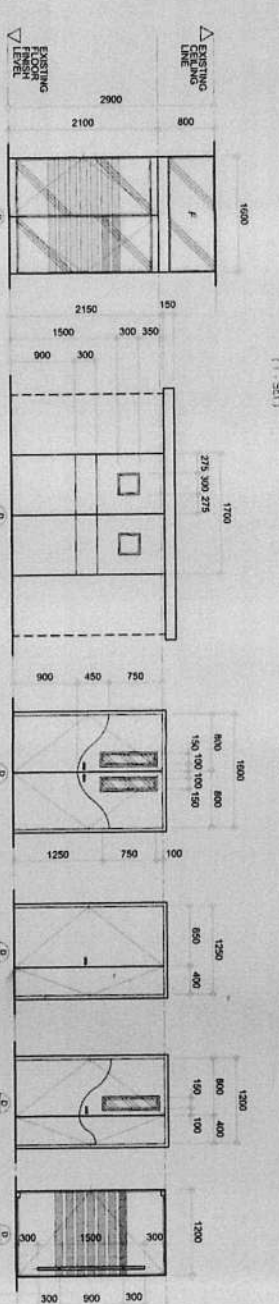

13) MAX. THE CLEAR GLASS DOUBLE SLING TYPE DOOR WITHED SHIF. GLASS TRANSPARENT WINDOW PANELS BY 100 MM. WITH GLASS RAIL STRIPS AT 150 MM. O.C. + 30 MM. Ø ON POWDER COATED EXTRUDED ALUMINIUM (1-1-SECT)

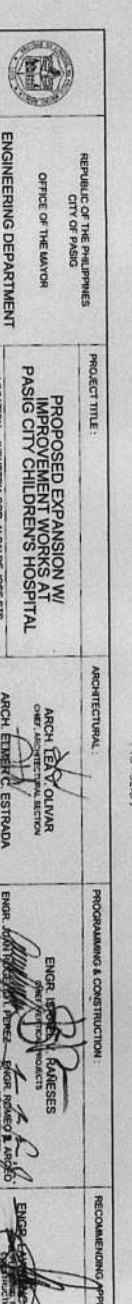

SCHEDULE OF DOORS
1:40 MM.
SCALE



REPUBLIC OF THE PHILIPPINES
CITY OF PASIG
OFFICE OF THE MAYOR
ENGINEERING DEPARTMENT

PROJECT TITLE:
**PROPOSED EXPANSION W/
IMPROVEMENT WORKS AT
PASIG CITY CHILDREN'S HOSPITAL**

ARCHITECTURAL:
ARCH. IENY OLIVAR
CHIEF ARCHITECTURAL SECTION
ARCH. EMMERICH ESTRADA
ARCHITECT




PROGRAMMING & CONSTRUCTION:
ENGR. JEROME BARRALES
CHIEF PROGRAMMING & CONSTRUCTION SECTION
ENGR. ARNOLD PINEA
ARCHITECT

RECOMMENDING APPROVAL:
ENGR. CARLOS B. PRUDENCIO
CHIEF ENGINEERING SECTION
ENGR. ARTAVARDES V. GERONIMO
O.I.C. ENGINEERING DEPARTMENT



APPROVED BY:
VICTOR MA. REGIS N. SOTTO
CITY MAYOR
CAPO ECESTRADA
CHIEF ENGINEER

SHEET CONTENTS: SCHEDULE OF DOORS
SHEET NO.: **A**
26 / **39**

1. THIS DRAWING IS A PART OF THE PROJECT AND SHALL BE USED ONLY FOR THE PROJECT AND NOT FOR ANY OTHER PURPOSE.
2. THE CONTRACTOR SHALL BE RESPONSIBLE FOR THE CONSTRUCTION OF THE PROJECT.
3. THE CONTRACTOR SHALL BE RESPONSIBLE FOR THE MAINTENANCE OF THE PROJECT.
4. THE CONTRACTOR SHALL BE RESPONSIBLE FOR THE REPAIRS OF THE PROJECT.
5. THE CONTRACTOR SHALL BE RESPONSIBLE FOR THE REPLACEMENT OF THE PROJECT.
6. THE CONTRACTOR SHALL BE RESPONSIBLE FOR THE REMOVAL OF THE PROJECT.
7. THE CONTRACTOR SHALL BE RESPONSIBLE FOR THE DISPOSAL OF THE PROJECT.
8. THE CONTRACTOR SHALL BE RESPONSIBLE FOR THE PROTECTION OF THE PROJECT.
9. THE CONTRACTOR SHALL BE RESPONSIBLE FOR THE SAFETY OF THE PROJECT.
10. THE CONTRACTOR SHALL BE RESPONSIBLE FOR THE QUALITY OF THE PROJECT.

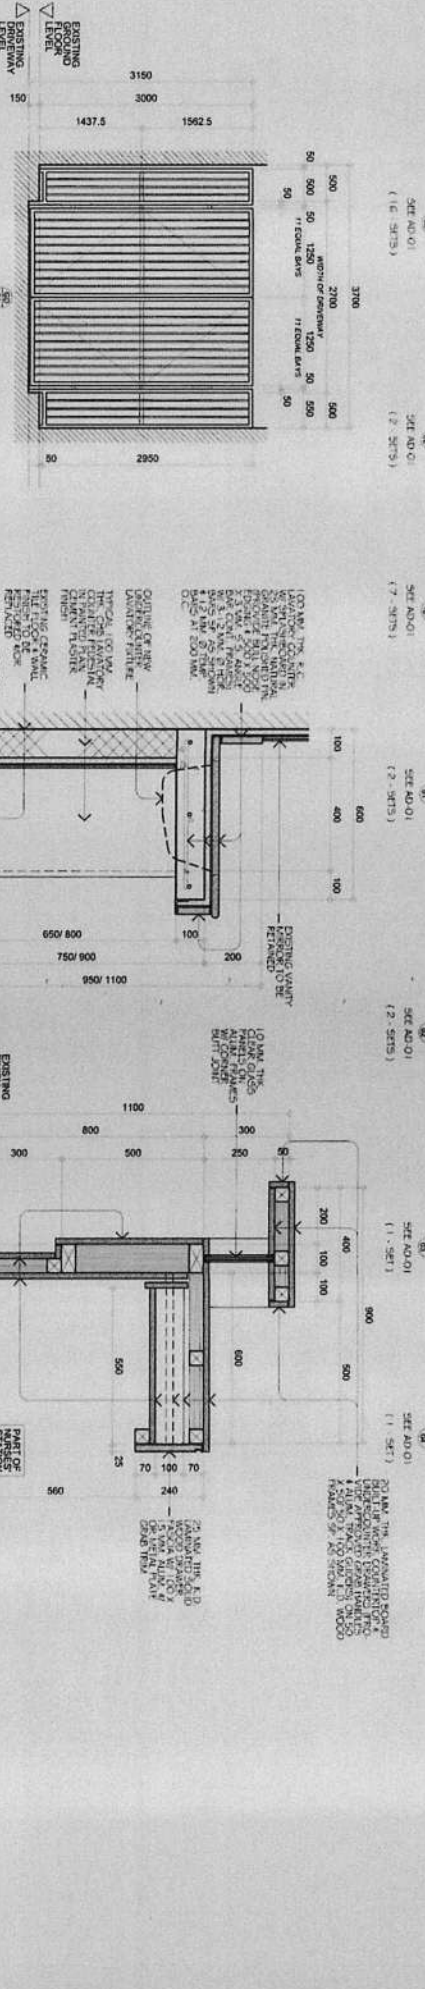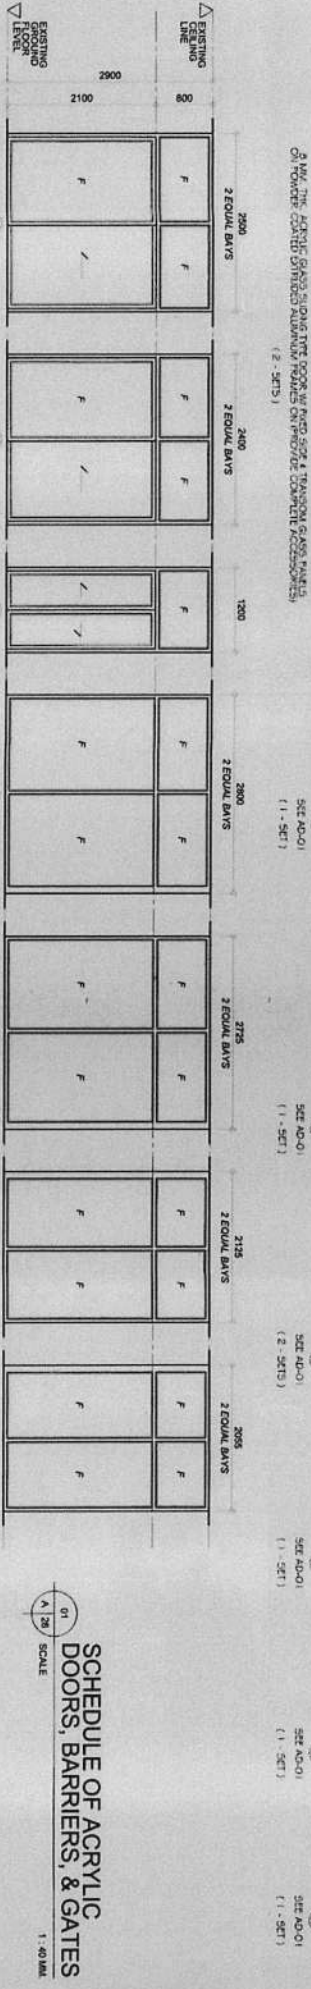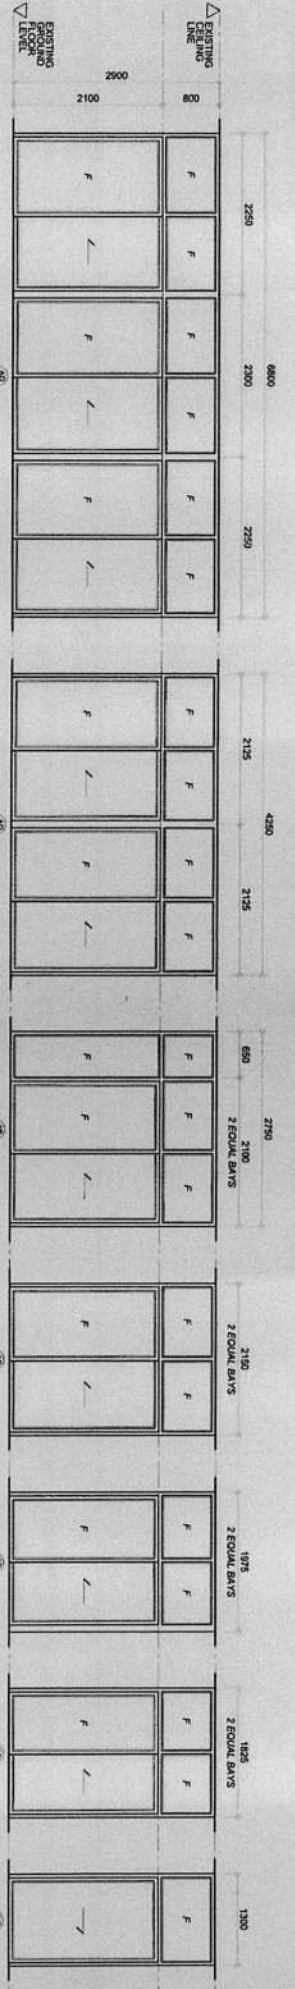

DETAIL SECTION OF NEW LAVATORY COUNTER TOP
DETAIL SECTION

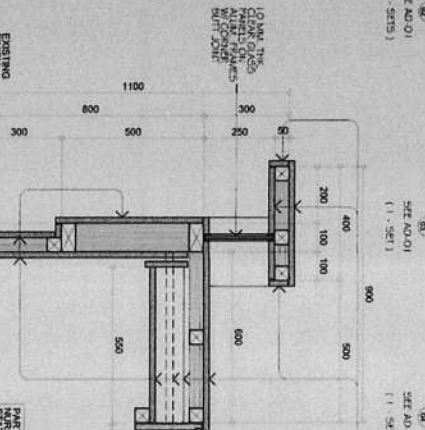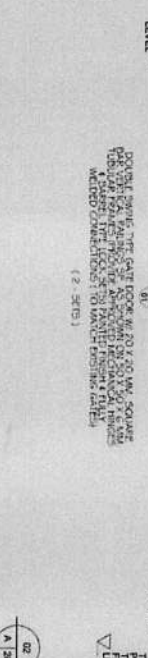

SCHEDULE OF ACRYLIC DOORS, BARRIERS, & GATES
 1:40 MAIL
 A 28 SCALE



REPUBLIC OF THE PHILIPPINES
 CITY OF PASIG
 OFFICE OF THE MAYOR
 ENGINEERING DEPARTMENT

PROJECT TITLE:
PROPOSED EXPANSION WITH IMPROVEMENT WORKS AT PASIG CITY CHILDREN'S HOSPITAL

ARCHITECTURAL:
ARCH. EMMERIT ESTRADA
 ARCHITECT

PROGRAMMING & CONSTRUCTION:
ENGR. RICHARD B. BERNARDES
ENGR. RICHARD B. BERNARDES
ENGR. RICHARD B. BERNARDES


RECOMMENDING APPROVAL:
ENGR. GERONIMO G. GERONIMO
ENGR. ARTAVEXES V. GERONIMO
ENGR. ARTAVEXES V. GERONIMO

APPROVED BY:
VICTOR M. TRIGOS N. SOTTO
 CITY MAYOR

SHEET CONTENTS:
 SCHEDULE OF ACRYLIC DOORS, BARRIERS, & GATES
 DETAIL SECTIONS

SHEET NO.:
A
28 / **39**

1. THE CONTRACTOR SHALL BE RESPONSIBLE FOR OBTAINING ALL NECESSARY PERMITS AND APPROVALS FROM THE APPROPRIATE AGENCIES.
 2. THE CONTRACTOR SHALL BE RESPONSIBLE FOR OBTAINING ALL NECESSARY PERMITS AND APPROVALS FROM THE APPROPRIATE AGENCIES.
 3. THE CONTRACTOR SHALL BE RESPONSIBLE FOR OBTAINING ALL NECESSARY PERMITS AND APPROVALS FROM THE APPROPRIATE AGENCIES.
 4. THE CONTRACTOR SHALL BE RESPONSIBLE FOR OBTAINING ALL NECESSARY PERMITS AND APPROVALS FROM THE APPROPRIATE AGENCIES.
 5. THE CONTRACTOR SHALL BE RESPONSIBLE FOR OBTAINING ALL NECESSARY PERMITS AND APPROVALS FROM THE APPROPRIATE AGENCIES.
 6. THE CONTRACTOR SHALL BE RESPONSIBLE FOR OBTAINING ALL NECESSARY PERMITS AND APPROVALS FROM THE APPROPRIATE AGENCIES.
 7. THE CONTRACTOR SHALL BE RESPONSIBLE FOR OBTAINING ALL NECESSARY PERMITS AND APPROVALS FROM THE APPROPRIATE AGENCIES.
 8. THE CONTRACTOR SHALL BE RESPONSIBLE FOR OBTAINING ALL NECESSARY PERMITS AND APPROVALS FROM THE APPROPRIATE AGENCIES.
 9. THE CONTRACTOR SHALL BE RESPONSIBLE FOR OBTAINING ALL NECESSARY PERMITS AND APPROVALS FROM THE APPROPRIATE AGENCIES.
 10. THE CONTRACTOR SHALL BE RESPONSIBLE FOR OBTAINING ALL NECESSARY PERMITS AND APPROVALS FROM THE APPROPRIATE AGENCIES.

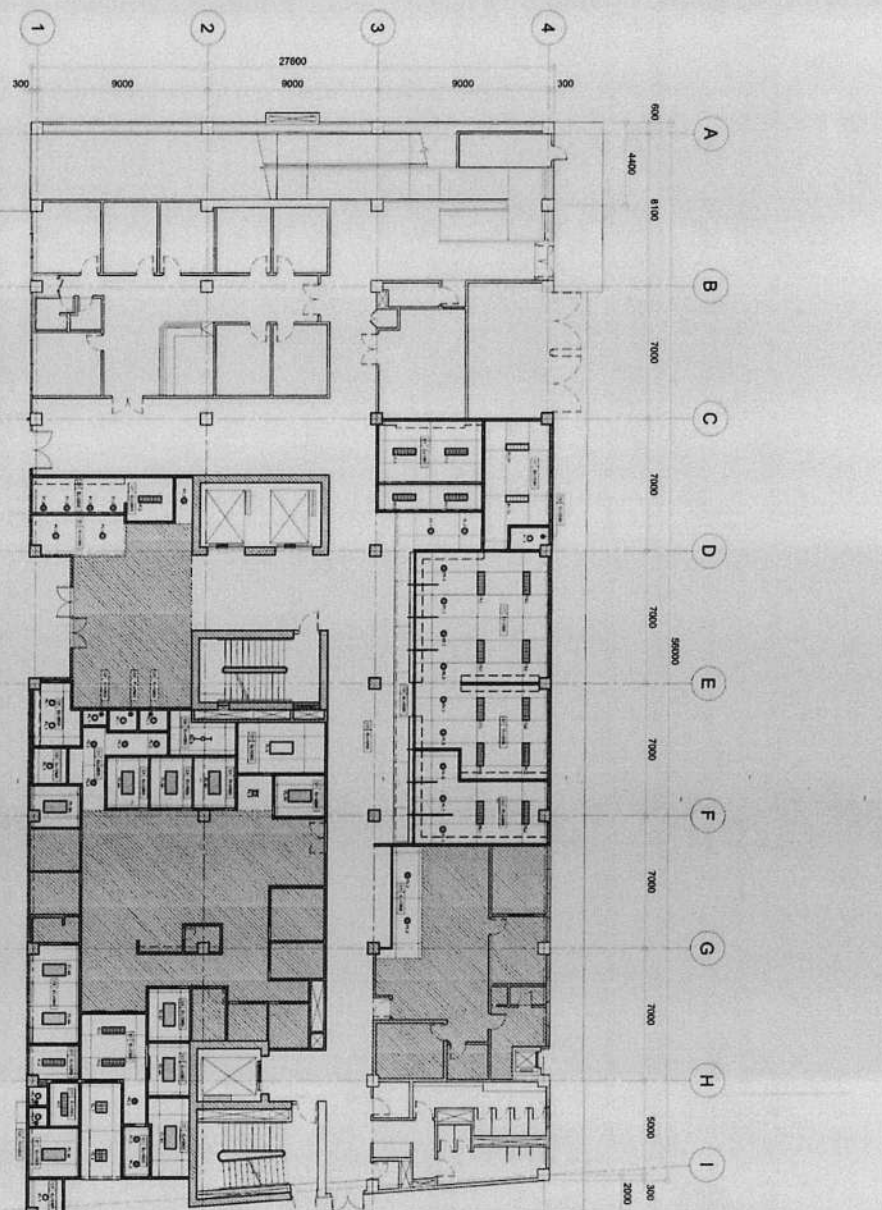

GROUND FLOOR REFLECTED CEILING PLAN
 1:150 M.A.
 1/25

CEILING FINISHES :

C-1	13 MIL THK ANTI BACTERIAL GYPSUM BOARD, ON METAL FRAMING SYSTEM, PAINTED FINISH (WITHOUT TOP CORNER)
C-2	13 MIL THK MOISTURE RESISTANCE GYPSUM BOARD, ON METAL FRAMING SYSTEM, PAINTED FINISH W/ ANTI BACTERIAL

LIGHTING LEGEND :

	SURFACE/ RECESSED MOUNTED 800 X 600 T.M. LOW GLARE ALUMINUM BODY FINISH (1 X 28W T.C. COOL WHITE)
	FULLY RECESSED MOUNTED 800 X 600 T.M. LOW GLARE ALUMINUM BODY FINISH (1 X 28W T.C. COOL WHITE)
	FULLY RECESSED MOUNTED 800 X 600 T.M. LOW GLARE ALUMINUM BODY FINISH (1 X 28W T.C. COOL WHITE)
LEGEND :


- EXISTING OR WALL/ REFLECTED
- NO SINGLE PANEL SYSTEM
- GRAYWALL PARTITION SYSTEM
- EXISTING OR WALL TO BE DEMOLISHED

REPUBLIC OF THE PHILIPPINES
 CITY OF PASIG
 OFFICE OF THE MAYOR
ENGINEERING DEPARTMENT

PROPOSED EXPANSION W/ INTERIOR RENOVATIONS PASIG CITY CHILDREN'S HOSPITAL
 LOCATION: INDUSTRIAL COR. ALCALDE JOSE STS. KAWASAKAN, PASIG CITY

ARCHITECTURAL: **ARCH. EMER C. ESTRADA**
 PROGRAMMING & CONSTRUCTION: **ENGR. GERONIMO GABRILES**
 RECOMMENDING APPROVAL: **ENGR. ARTAZHERY V. GERONIMO**
 APPROVED BY: **VICTOR M.F. REGIS N. SOTTO**
 SHEET CONTENTS: **CAJED ECSTRADA**
 SHEET NO.: **29/39**

REMARKS: 1. THIS PROJECT WILL BE BASED ON APPROVED PLANS & SPECIFICATIONS. 2. THE CONTRACTOR SHALL BE RESPONSIBLE FOR OBTAINING ALL NECESSARY PERMITS. 3. THE CONTRACTOR SHALL BE RESPONSIBLE FOR OBTAINING ALL NECESSARY PERMITS. 4. THE CONTRACTOR SHALL BE RESPONSIBLE FOR OBTAINING ALL NECESSARY PERMITS.

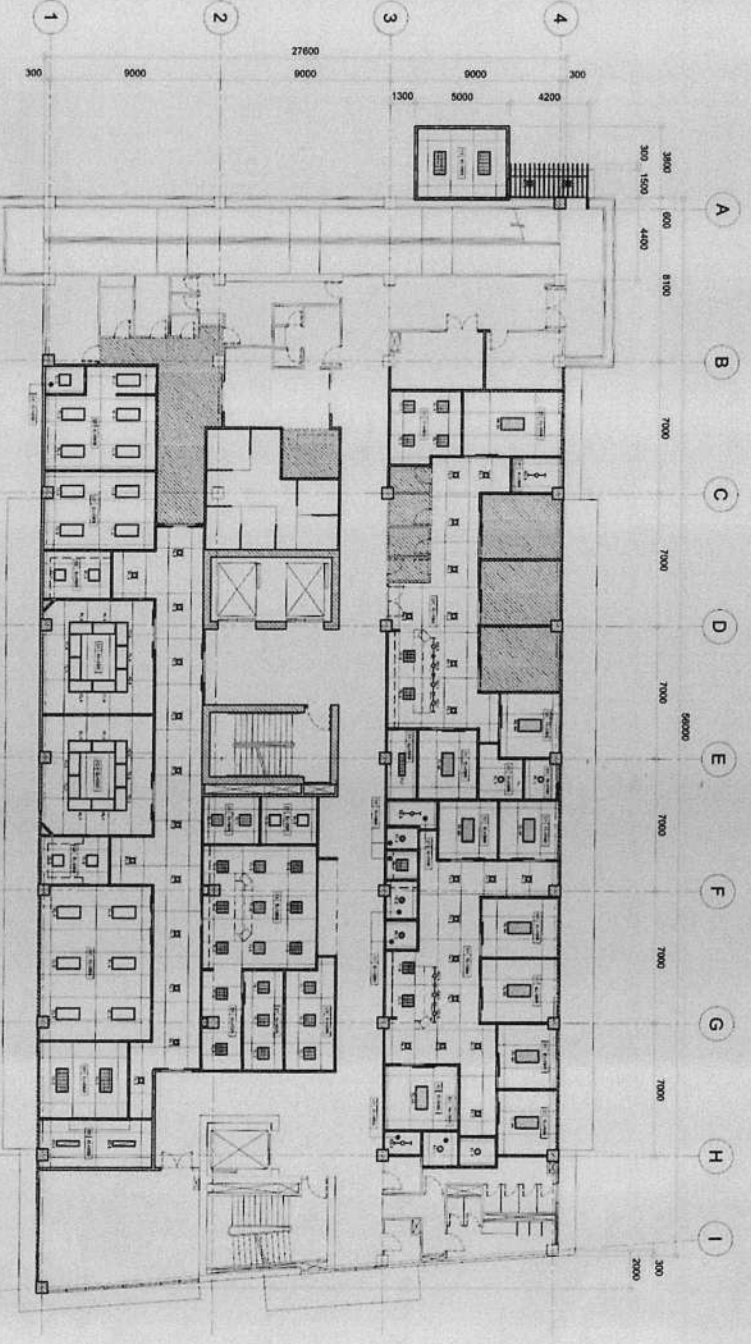

SECOND FLOOR REFLECTED CEILING PLAN
 1:150 MM

LEGEND :

- REINFORCED CONCRETE TO BE RETAINED
- NO SINGLE PANEL SYSTEM
- EXISTING CUR WALL TO BE DEMOLISHED

CEILING FINISHES :

C-1	13 MM THK. AIR SYSTEM, GYPSUM BOARD ON METAL FRAMING SYSTEM PAINTED FINISH (WITHOUT PAINT COVERAGE)
C-2	13 MM THK. MOISTURE RESISTANCE GYPSUM BOARD, ON METAL FRAMING SYSTEM PAINTED FINISH WITH ANTI BACTERIAL

LIGHTING LEGEND :

	SURFACE MOUNTED RECESSED MOUNTED 600 X 600 MM LOW GLARE ALUMINUM BODY FINISH (1.2 X 2MM T.C. COOL DAYLIGHT)
	FULLY RECESSED MOUNTED 300 X 300 MM ALUMINUM LAMPS OR WHITE FINISH (1.2 X 2MM T.C. COOL)
	FULLY RECESSED MOUNTED 600 X 600 MM FIXTURES, LOW GLARE FINISH (1.2 X 2MM T.C. COOL)
	FULLY RECESSED MOUNTED 600 X 1200 MM DIE CAST ALUMINUM & CLEAR GLASS PROTECTION COVER TO COOL (WHITE)
	FULLY RECESSED MOUNTED 600 X 1200 MM DIE CAST ALUMINUM & CLEAR GLASS PROTECTION COVER TO COOL (WHITE)
	FULLY RECESSED MOUNTED BRUTE ALUMINUM LAMPS & WHITE PANELS (1 X 1MM T.C. COOL)
	FULLY RECESSED MOUNTED 600 X 600 MM DIE CAST ALUMINUM & CLEAR GLASS PROTECTION COVER TO COOL (WHITE)
	FULLY RECESSED MOUNTED 600 X 600 MM DIE CAST ALUMINUM & CLEAR GLASS PROTECTION COVER TO COOL (WHITE)
	FULLY RECESSED MOUNTED DOWN LIGHT ONLY CARTRIDGE REFINED POLISHED ALUMINUM FINISH (1.2 X 2MM T.C. WARM DAYLIGHT)
	FULLY RECESSED MOUNTED DOWN LIGHT ONLY CARTRIDGE REFINED POLISHED ALUMINUM FINISH (1.2 X 2MM T.C. WARM DAYLIGHT)
	FULLY RECESSED MOUNTED DOWN LIGHT ONLY CARTRIDGE REFINED POLISHED ALUMINUM FINISH (1.2 X 2MM T.C. WARM DAYLIGHT)
	FULLY RECESSED MOUNTED DOWN LIGHT ONLY CARTRIDGE REFINED POLISHED ALUMINUM FINISH (1.2 X 2MM T.C. WARM DAYLIGHT)
	SURFACE MOUNTED RECESSED MOUNTED 600 X 600 MM LOW GLARE ALUMINUM BODY FINISH (1.2 X 2MM T.C. COOL)

	REPUBLIC OF THE PHILIPPINES CITY OF PASIG ENGINEERING DEPARTMENT	PROJECT TITLE: PROPOSED EXPANSION WITH IMPROVEMENT WORKS AT PASIG CITY CHILDREN'S HOSPITAL	ARCHITECTURAL: ARCH. ELMER P. OLIVAR ARCH. ELMER P. OLIVAR
LOCATION: MONTECristO CENTRAL AVENUE, JOSE STIL, MONTECristO		PROGRAMMING & CONSTRUCTION: ENGR. ERIC M. RANSES ENGR. ERIC M. RANSES	
RECOMMENDING APPROVAL: ENGR. ART AXERXES V. GERONIMO ENGR. ART AXERXES V. GERONIMO		APPROVED BY: VICTOR M. REGIS N. SOTTO CITY MANOR	

IMPORTANT NOTES :

- NO ALTERATION OR ADDITION OF WORK SHALL BE MADE WITHOUT THE WRITTEN APPROVAL OF THE ARCHITECT.
- FOR ALL WORK, THE CONTRACTOR SHALL BE RESPONSIBLE FOR OBTAINING ALL NECESSARY PERMITS AND APPROVALS FROM THE APPROPRIATE AGENCIES.
- THE CONTRACTOR SHALL BE RESPONSIBLE FOR OBTAINING ALL NECESSARY PERMITS AND APPROVALS FROM THE APPROPRIATE AGENCIES.
- THE CONTRACTOR SHALL BE RESPONSIBLE FOR OBTAINING ALL NECESSARY PERMITS AND APPROVALS FROM THE APPROPRIATE AGENCIES.
- THE CONTRACTOR SHALL BE RESPONSIBLE FOR OBTAINING ALL NECESSARY PERMITS AND APPROVALS FROM THE APPROPRIATE AGENCIES.
- THE CONTRACTOR SHALL BE RESPONSIBLE FOR OBTAINING ALL NECESSARY PERMITS AND APPROVALS FROM THE APPROPRIATE AGENCIES.
- THE CONTRACTOR SHALL BE RESPONSIBLE FOR OBTAINING ALL NECESSARY PERMITS AND APPROVALS FROM THE APPROPRIATE AGENCIES.
- THE CONTRACTOR SHALL BE RESPONSIBLE FOR OBTAINING ALL NECESSARY PERMITS AND APPROVALS FROM THE APPROPRIATE AGENCIES.
- THE CONTRACTOR SHALL BE RESPONSIBLE FOR OBTAINING ALL NECESSARY PERMITS AND APPROVALS FROM THE APPROPRIATE AGENCIES.
- THE CONTRACTOR SHALL BE RESPONSIBLE FOR OBTAINING ALL NECESSARY PERMITS AND APPROVALS FROM THE APPROPRIATE AGENCIES.



REPUBLIC OF THE PHILIPPINES
CITY OF PASIG
OFFICE OF THE MAYOR
ENGINEERING DEPARTMENT

PROJECT TITLE:
**PROPOSED EXPANSION W/
IMPROVEMENT WORKS AT
PASIG CITY CHILDREN'S HOSPITAL**

ARCHITECTURAL:
ARCHT. ENGR. OLIVAR
RANESSES
ENGR. EDUARDO
ESTRADA

PROGRAMMING & CONSTRUCTION:
ENGR. ISABEL
RANESSES
ENGR. RAFAEL
PEREZ ENGR. ROMEO
MENDOZA

RECOMMENDING APPROVAL:
ENGR. JUAN
DE LA CRUZ
ENGR. JOSE
M. CALDERON

ENGR. ARTAVERDE
V. GERONIMO
O.I.C. ENGINEERING DEPARTMENT

APPROVED BY:
VICTOR M. REGIS N. SOTTO
CITY MAYOR

SHEET CONTENTS:
THIRD FLOOR
REFLECTED
CEILING
A


SHEET NO.:
31
39

IMPORTANT NOTES:
1. NO ALTERATION IN DIMENSIONS & SPECIFICATIONS SHALL BE MADE WITHOUT THE WRITTEN APPROVAL OF THE ARCHITECT AND ENGINEER.
2. ALL WORK SHALL BE DONE IN ACCORDANCE WITH THE LATEST EDITIONS OF THE PHILIPPINE NATIONAL STANDARDS.
3. THE CONTRACTOR SHALL BE RESPONSIBLE FOR THE PROTECTION AND PRESERVATION OF ALL EXISTING UTILITIES AND STRUCTURES.
4. THE CONTRACTOR SHALL BE RESPONSIBLE FOR THE PROTECTION AND PRESERVATION OF ALL EXISTING UTILITIES AND STRUCTURES.
5. THE CONTRACTOR SHALL BE RESPONSIBLE FOR THE PROTECTION AND PRESERVATION OF ALL EXISTING UTILITIES AND STRUCTURES.
6. THE CONTRACTOR SHALL BE RESPONSIBLE FOR THE PROTECTION AND PRESERVATION OF ALL EXISTING UTILITIES AND STRUCTURES.
7. THE CONTRACTOR SHALL BE RESPONSIBLE FOR THE PROTECTION AND PRESERVATION OF ALL EXISTING UTILITIES AND STRUCTURES.
8. THE CONTRACTOR SHALL BE RESPONSIBLE FOR THE PROTECTION AND PRESERVATION OF ALL EXISTING UTILITIES AND STRUCTURES.
9. THE CONTRACTOR SHALL BE RESPONSIBLE FOR THE PROTECTION AND PRESERVATION OF ALL EXISTING UTILITIES AND STRUCTURES.
10. THE CONTRACTOR SHALL BE RESPONSIBLE FOR THE PROTECTION AND PRESERVATION OF ALL EXISTING UTILITIES AND STRUCTURES.

LEGEND :

	EXISTING CURB WALL REF. TO BE PRESERVED
	NO SINGLE PANEL SYSTEM
	EXISTING CURB WALL TO BE DEMOLISHED

01
A 1/31 SCALE
THIRD FLOOR REFLECTED CEILING PLAN
1 : 150 MM

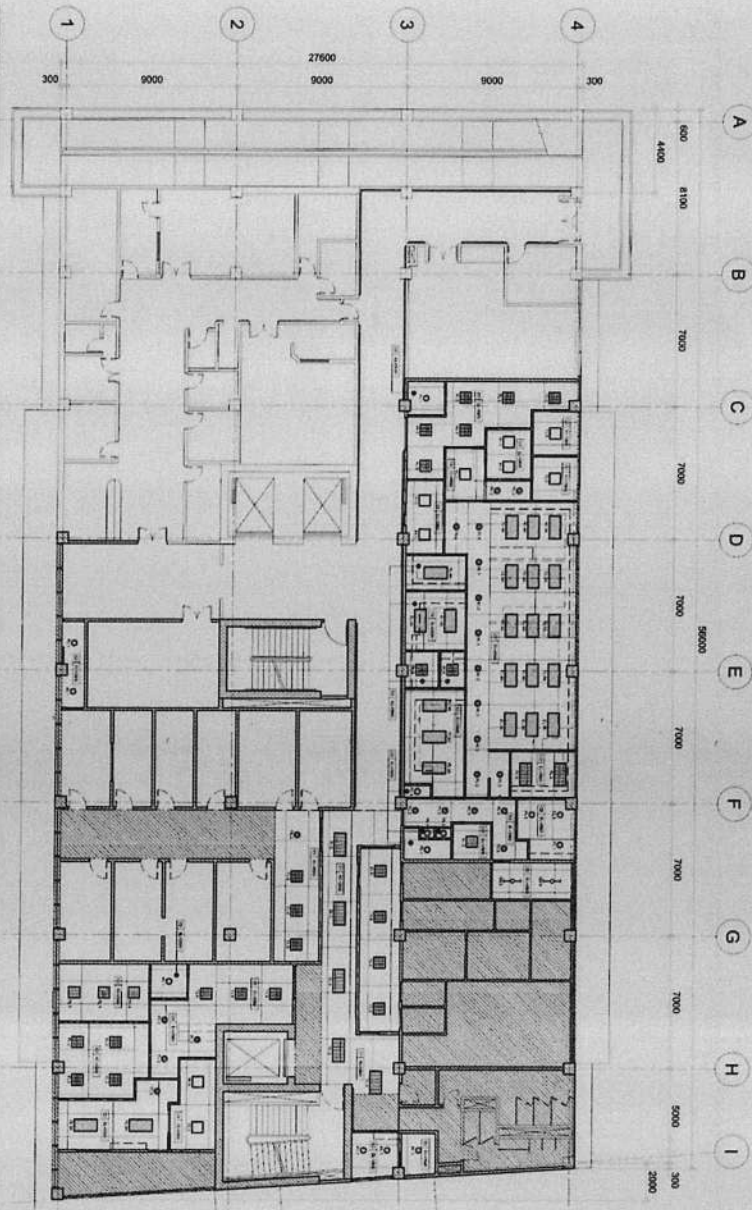


CEILING FINISHES :

C-1	12 MM THK. ANTI BACTERIAL GYPSUM BOARD, ON METAL FRAMING SYSTEM.
C-2	13 MM THK. MOSTURE RESISTANCE GYPSUM BOARD, ON METAL FRAMING SYSTEM.

LIGHTING LEGEND :

	SURFACE MOUNTED, 600 X 600 MM, LOW GLARE ALUMINUM BODY FINISH (1 X 2WV FL. COOL WHITE)
	RECESSED MOUNTED, 600 X 600 MM, LOW GLARE ALUMINUM BODY FINISH (1 X 2WV FL. COOL WHITE)
	RECESSED MOUNTED, 600 X 600 MM, MODULAR W/ AMBROSE M.A.L. PANELS (1 X 1WV FL. COOL WHITE)
	RECESSED MOUNTED, 600 X 600 MM, MODULAR W/ AMBROSE M.A.L. PANELS (1 X 2WV FL. COOL WHITE)
	RECESSED MOUNTED, 600 X 600 MM, ALUMINUM BODY FINISH (1 X 1WV FL. COOL WHITE)
	RECESSED MOUNTED, 600 X 600 MM, ALUMINUM BODY FINISH (1 X 2WV FL. COOL WHITE)
	RECESSED MOUNTED, 600 X 600 MM, ALUMINUM BODY FINISH (1 X 2WV FL. COOL WHITE)
	RECESSED MOUNTED, 600 X 600 MM, ALUMINUM BODY FINISH (1 X 2WV FL. COOL WHITE)
	RECESSED MOUNTED, 600 X 600 MM, ALUMINUM BODY FINISH (1 X 2WV FL. COOL WHITE)
	RECESSED MOUNTED, 600 X 600 MM, ALUMINUM BODY FINISH (1 X 2WV FL. COOL WHITE)
	RECESSED MOUNTED, 600 X 600 MM, ALUMINUM BODY FINISH (1 X 2WV FL. COOL WHITE)


01. THE PROGRAM OF WORKS FOR BIDDING PURPOSES ONLY.

 REPUBLIC OF THE PHILIPPINES OFFICE OF THE MAJOR ENGINEERING DEPARTMENT	PROJECT TITLE:	ARCHITECTURAL:	PROGRAMMING & CONSTRUCTION:	RECOMMENDING APPROVAL:	APPROVED BY:	SHEET CONTENTS:	SHEET NO.:
	PROPOSED EXPANSION W/ IMPROVEMENT WORKS AT PASIG CITY CHILDREN'S HOSPITAL LOCATION: INDUSTRIAL COR, ALCAJE JOSE STS. KAPUSUKAN, PASIG CITY	ARCH. LEA V. OLIVAR CHIEF ARCHITECTURAL OFFICER ARCH. EDWIN U. ESTRADA ARCHITECT IN CHARGE	ENGR. ISMAEL GABRESSES ENGR. RAFAEL J. MACEDA ENGR. ANTONIO VENEZ ENGR. JEROME B. MORALES	ENGR. JUAN B. BENDUENCO O.P.C. SUPERVISOR OF WORKS	ENGR. ARTAVERDES Y. GERONIMO O.P.C. SUPERVISOR OF WORKS	VICTOR M. REGIS N. SOTTO CITY MAJOR	REVISIONS: 1. CORRECTED DRAWING 2. CORRECTED DRAWING 3. CORRECTED DRAWING 4. CORRECTED DRAWING 5. CORRECTED DRAWING 6. CORRECTED DRAWING 7. CORRECTED DRAWING 8. CORRECTED DRAWING 9. CORRECTED DRAWING 10. CORRECTED DRAWING

LEGEND :

	EXISTING CHEM WALL REF. COLUMN TO BE REMOVED
	NO SINGLE PANEL SYSTEM
	EXISTING CHEM WALL TO BE DEMOLISHED

01
 1/32" SCALE
FOURTH FLOOR REFLECTED CEILING PLAN
 1" = 30 MM

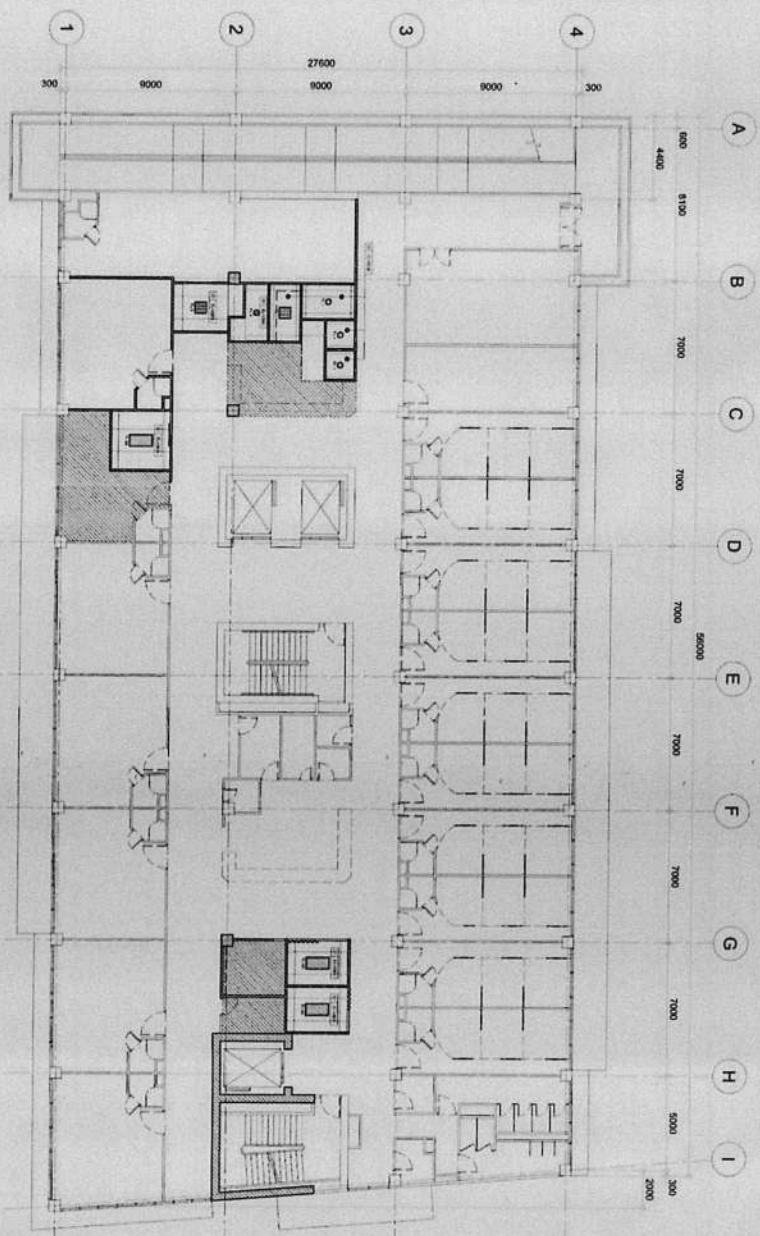


CEILING FINISHES :

C-1	12 MM THK. ANTI BACTERIAL GYPSUM BOARD ON METAL FRAMING SYSTEM PAINTED FINISH (WITHOUT MPF COBOLITE)
C-2	12 MM THK. MOISTURE RESISTANCE GYPSUM BOARD ON METAL FRAMING SYSTEM PAINTED FINISH (WITHOUT MPF COBOLITE)

LIGHTING LEGEND :

	SURFACE MOUNTED RECESSED MOUNTED 800 X 160 MM DE GRAY ALUMINUM BODY FINISH (1 X 28W T.C. COOL DAYLIGHT)
	PLY RECESSED MOUNTED 800 X 160 MM DE GRAY ALUMINUM BODY FINISH (1 X 28W T.C. COOL DAYLIGHT)
	PLY RECESSED MOUNTED 800 X 160 MM DE GRAY ALUMINUM BODY FINISH (1 X 28W T.C. COOL DAYLIGHT)
	PLY RECESSED MOUNTED 800 X 160 MM DE GRAY ALUMINUM BODY FINISH (1 X 28W T.C. COOL DAYLIGHT)
	PLY RECESSED MOUNTED 800 X 160 MM DE GRAY ALUMINUM BODY FINISH (1 X 28W T.C. COOL DAYLIGHT)
	PLY RECESSED MOUNTED 800 X 160 MM DE GRAY ALUMINUM BODY FINISH (1 X 28W T.C. COOL DAYLIGHT)
	PLY RECESSED MOUNTED 800 X 160 MM DE GRAY ALUMINUM BODY FINISH (1 X 28W T.C. COOL DAYLIGHT)
	PLY RECESSED MOUNTED 800 X 160 MM DE GRAY ALUMINUM BODY FINISH (1 X 28W T.C. COOL DAYLIGHT)

1. THIS DRAWING IS THE PROPERTY OF THE ARCHITECT AND SHALL BE KEPT IN HIS OFFICE. IT IS TO BE USED ONLY FOR THE PROJECT AND NOT TO BE REPRODUCED OR COPIED IN ANY MANNER WITHOUT THE WRITTEN PERMISSION OF THE ARCHITECT.

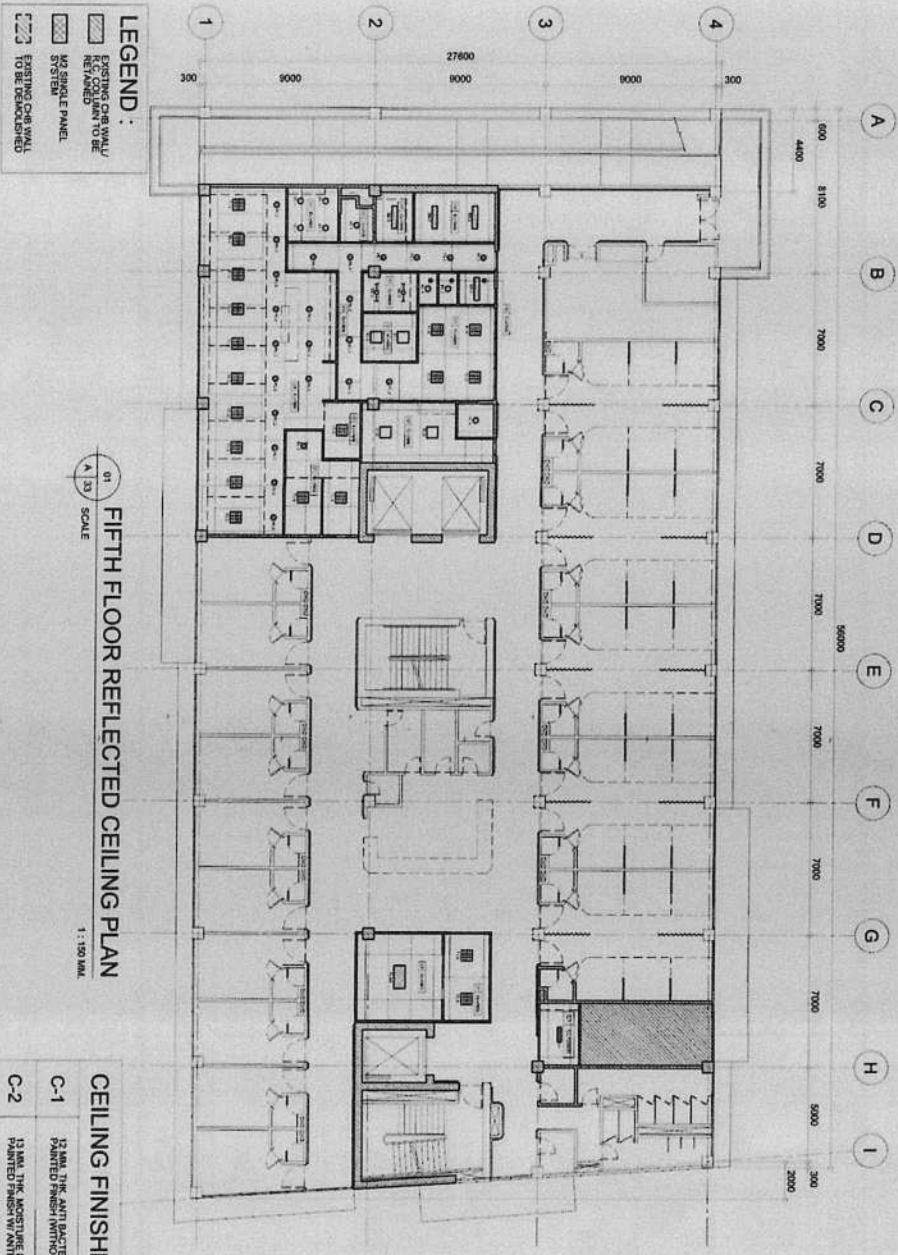

LEGEND:

	EXISTING CAR WALL RETAINED TO BE
	NO SINGLE PANEL SYSTEM
	EXISTING CAR WALL TO BE DEMOLISHED

FIFTH FLOOR REFLECTED CEILING PLAN
 1:100 IRL
 SCALE

CEILING FINISHES:

C-1	13 MIL. THK. ANTI-BACTERIAL GYPSUM BOARD, ON METAL FRAMING SYSTEM, PAINTED FINISH (MILK CHALK COLOR)
C-2	13 MIL. THK. MOISTURE RESISTANCE GYPSUM BOARD, ON METAL FRAMING SYSTEM, PAINTED FINISH W/ ANTI-BACTERIAL

LIGHTING LEGEND:

	FULLY RECESSED MOUNTED 600 X 1200 MM HIGHLY SPECULAR REFLECTOR IN 135° CL. EMBL. ROOM TYPE (2 X 28W 19 COOL WHITE)
	FULLY RECESSED MOUNTED 600 X 600 MM MODULAR W/ AMBRO WHITE PANELS (4 X 18W 19 COOL WHITE)
	FULLY RECESSED MOUNTED 600 X 600 MM MODULAR W/ AMBRO WHITE PANELS (3 X 18W 19 COOL WHITE)
	FULLY RECESSED MOUNTED DONNARSI POLY CARBONATE BODY REFLECTOR (2 X 18W CFL WARM DAYLIGHT)
	FULLY RECESSED MOUNTED DONNARSI POLY CARBONATE BODY REFLECTOR (1 X 18W CFL WARM DAYLIGHT)
	SPRIG ACCE. SUSPENDED MOUNTED FINE TITANIUM W/ POLY CARBONATE REFLECTOR (2 X 28W CFL COOL WHITE)
	SPRIG ACCE. MOUNTED (1 X 28W CFL 19 COOL WHITE)

	REPUBLIC OF THE PHILIPPINES CITY OF PASIG OFFICE OF THE MAYOR ENGINEERING DEPARTMENT	PROJECT TITLE PROPOSED EXPANSION W/ IMPROVEMENT WORKS AT PASIG CITY CHILDREN'S HOSPITAL	ARCHITECTURAL: ARCH. EDWIN C. ESTRADA CHIEF ARCHITECTURAL OFFICER	PROGRAMMING & CONSTRUCTION: ENGR. (SPECIALIST) KANESSES ENGR. (SPECIALIST) REYES ENGR. (SPECIALIST) REYES ENGR. (SPECIALIST) REYES ENGR. (SPECIALIST) REYES ENGR. (SPECIALIST) REYES	RECOMMENDING APPROVAL: ENGR. (SPECIALIST) REYES ENGR. (SPECIALIST) REYES ENGR. (SPECIALIST) REYES ENGR. (SPECIALIST) REYES ENGR. (SPECIALIST) REYES	APPROVED BY: VICTOR MACAREGAS N. SOTTO CITY MANAGER	SHEET CONTENTS: FIFTH FLOOR REFLECTED CEILING PLAN	SHEET NO.: 33 / 39 A
	LOCATION: INDUSTRIAL CORP. ALCADE JOSE STS. PASIG CITY	ARCHITECTURAL: ARCH. EDWIN C. ESTRADA CHIEF ARCHITECTURAL OFFICER	PROGRAMMING & CONSTRUCTION: ENGR. (SPECIALIST) KANESSES ENGR. (SPECIALIST) REYES ENGR. (SPECIALIST) REYES ENGR. (SPECIALIST) REYES ENGR. (SPECIALIST) REYES	RECOMMENDING APPROVAL: ENGR. (SPECIALIST) REYES ENGR. (SPECIALIST) REYES ENGR. (SPECIALIST) REYES ENGR. (SPECIALIST) REYES ENGR. (SPECIALIST) REYES	APPROVED BY: VICTOR MACAREGAS N. SOTTO CITY MANAGER	SHEET CONTENTS: FIFTH FLOOR REFLECTED CEILING PLAN	SHEET NO.: 33 / 39 A	

IMPORTANT NOTES:

- NO ALTERNATIVE TO THE PROPOSED WORKS SHALL BE MADE WITHOUT THE APPROVAL OF THE ARCHITECTURAL OFFICER.
- CONSTRUCTION OF THE PROPOSED WORKS SHALL BE COMPLETED WITHIN THE PERIOD OF 180 DAYS FROM THE DATE OF COMMENCEMENT OF THE PROPOSED WORKS.
- THE PROPOSED WORKS SHALL BE COMPLETED WITHIN THE PERIOD OF 180 DAYS FROM THE DATE OF COMMENCEMENT OF THE PROPOSED WORKS.
- CONSTRUCTION OF THE PROPOSED WORKS SHALL BE COMPLETED WITHIN THE PERIOD OF 180 DAYS FROM THE DATE OF COMMENCEMENT OF THE PROPOSED WORKS.
- CONSTRUCTION OF THE PROPOSED WORKS SHALL BE COMPLETED WITHIN THE PERIOD OF 180 DAYS FROM THE DATE OF COMMENCEMENT OF THE PROPOSED WORKS.

DATE: 03/15/2023



REPUBLIC OF THE PHILIPPINES
CITY OF PASIG
OFFICE OF THE MAYOR
ENGINEERING DEPARTMENT

PROJECT TITLE:
**PROPOSED EXPANSION W/
IMPROVEMENT WORKS AT
PASIG CITY CHILDREN'S HOSPITAL**

ARCHITECTURAL:
ARCHT. LEAVY OLIVAR
OPER. ARCHT. DIVISION
ARCHT. ENRICA
ALVARADO ESTRADA

PROGRAMMING & CONSTRUCTION:
ENGR. JEROME MANABES
PROJECT MANAGER
ENGR. SIXTON DE KESERZ
ENGR. ROYAL & ARCEO

RECOMMENDING APPROVAL:
ENGR. JOSE B. SERRANO
ENGR. ARTAXERYES V. GERONIMO

APPROVED BY:
VICTOR TAN REGIS N. SOTTO
CITY MANAGER


SHEET CONTENTS:
REVISIONS
NO. DESCRIPTION
DATE
1. 341 39

ADDITIONAL NOTES:
1. ALL MATERIALS SHALL BE OF THE HIGHEST QUALITY.
2. THE PROPOSAL OF WORKS IS FOR INFORMATION PURPOSES ONLY.

LEGEND:

	REFLECTIVE CEILING PANEL
	SINGLE PANEL SYSTEM
	PARTITION SYSTEM
	EXISTING CORE WALL TO BE DEMOLISHED

SIXTH FLOOR REFLECTED CEILING PLAN
SCALE: 1:100 MM

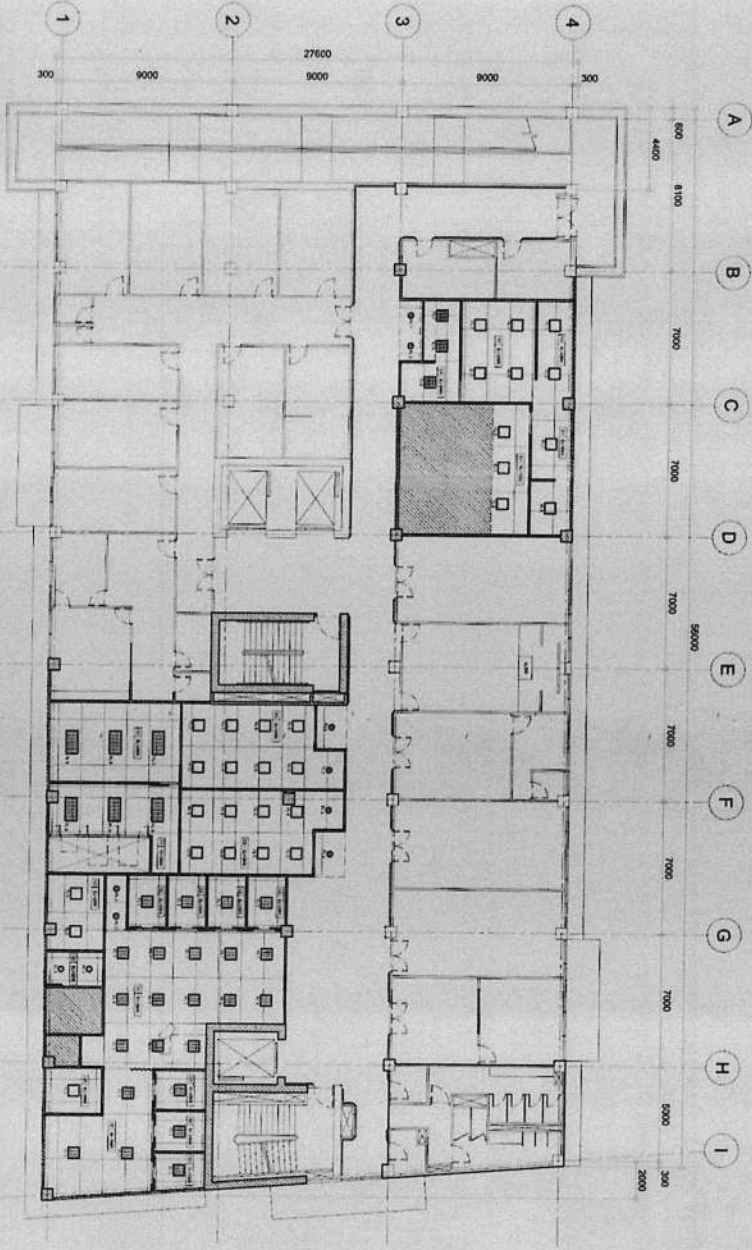


CEILING FINISHES:


C-1	12 MM THK. ANTI BACTERIAL OPSUM BOARD ON METAL FRAMING SYSTEM PAINTED FINISH (WITHOUT JOINT COMBES)
C-2	12 MM THK. MOISTURE RESISTANCE OPSUM BOARD ON METAL FRAMING SYSTEM PAINTED FINISH W/ ANTI BACTERIAL

LIGHTING LEGEND:

	FULLY RECESSED MOUNTED 600 X 600 MM FLAT PANEL LED DOWNLIGHT (2 X 20W 15 WARM DAYLIGHT)
	FULLY RECESSED MOUNTED 600 X 600 MM FLAT PANEL LED DOWNLIGHT (1 X 15W 15 COOL WHITE)
	FULLY RECESSED MOUNTED 600 X 600 MM FLAT PANEL LED DOWNLIGHT (1 X 15W 15 WARM WHITE)
	FULLY RECESSED MOUNTED 600 X 600 MM FLAT PANEL LED DOWNLIGHT (1 X 15W 15 WARM WHITE)
	FULLY RECESSED MOUNTED 600 X 600 MM FLAT PANEL LED DOWNLIGHT (1 X 15W 15 WARM WHITE)

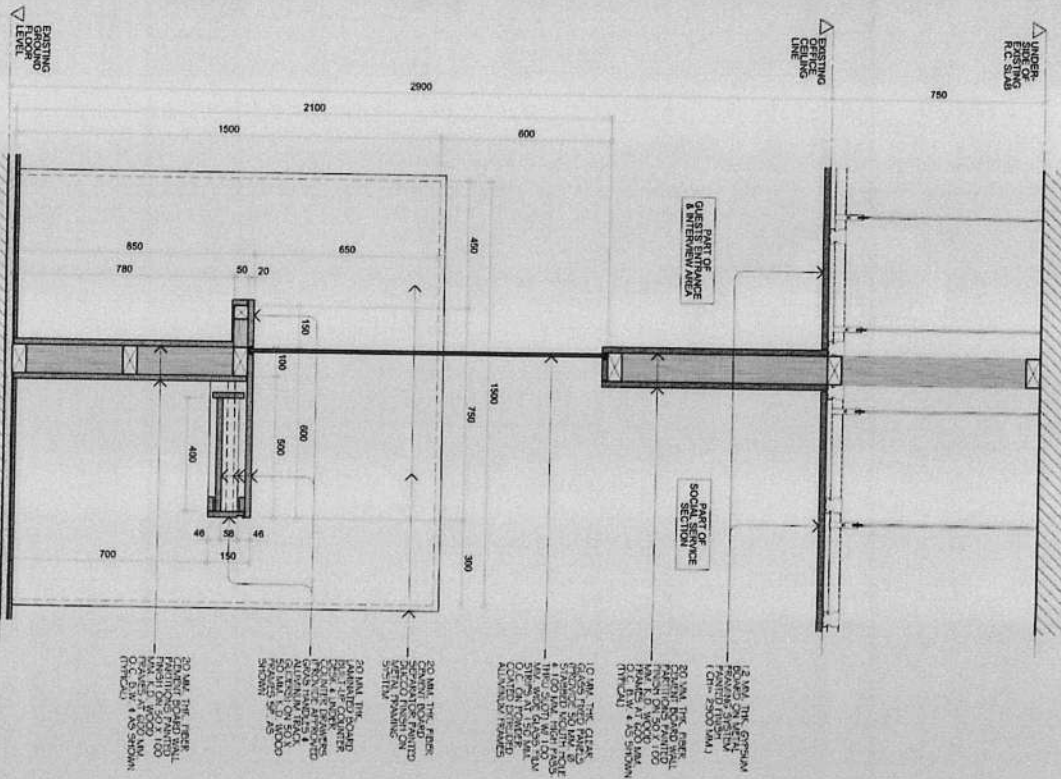

01
SCALE
1:10 MVA
GROUND FLOOR SOCIAL SERVICE
DETAIL SECTION

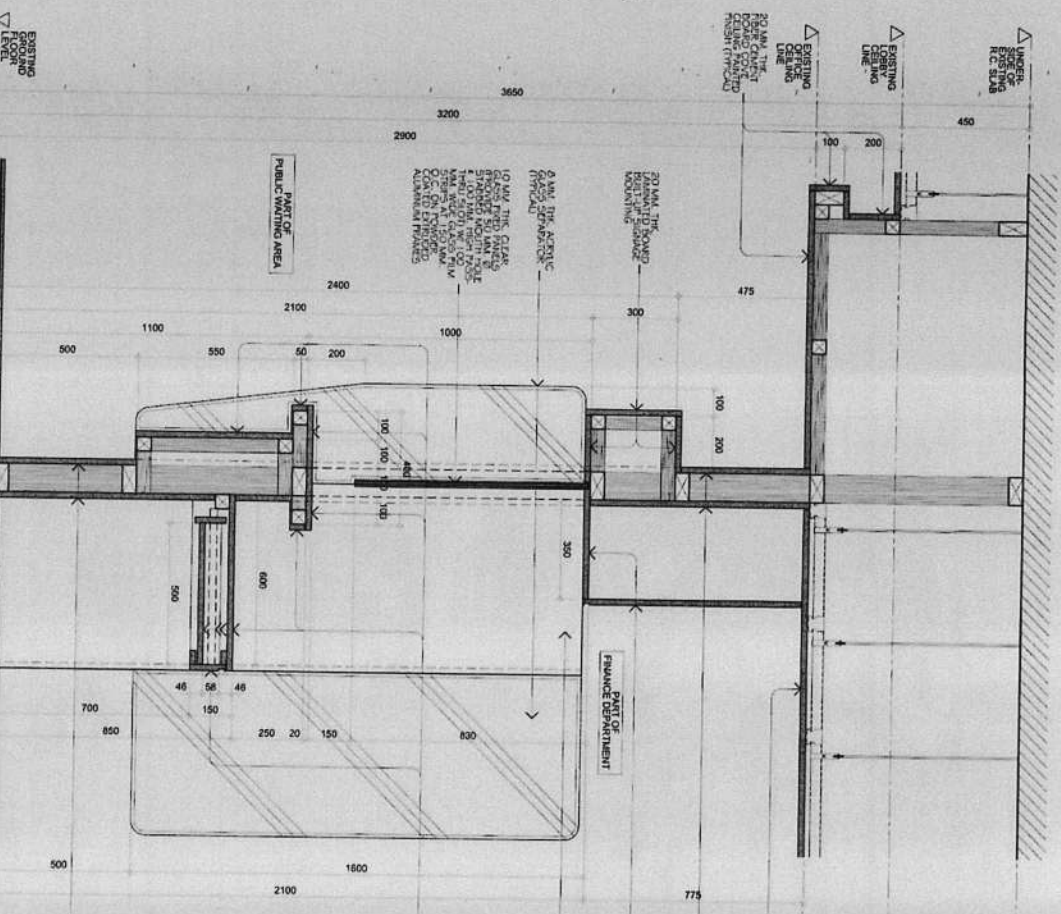

02
SCALE
1:10 MVA
GROUND FLOOR FINANCE DEPARTMENT
DETAIL SECTION



REPUBLIC OF THE PHILIPPINES
CITY OF PASIG
OFFICE OF THE MAYOR
ENGINEERING DEPARTMENT

PROJECT TITLE:
PROPOSED EXPANSION W/
IMPROVEMENT WORKS AT
PASIG CITY CHILDRENS HOSPITAL

ARCHITECTURAL:
ARCH. LEA V. QUILAR
CHIEF ARCHITECTURAL SUPERVISOR
ARCH. ELMER C. ESTRADA
ARCHITECT

PROGRAMMING & CONSTRUCTION:
ENGR. JEROME B. MANANES
PROJECT MANAGER
ENGR. JUAN M. SANCHEZ
SUPERVISOR


RECOMMENDING APPROVAL:
ENGR. JUAN M. SANCHEZ
SUPERVISOR

ENGR. ARTAVRERYS V. GERONIMO
O.C. ENGINEERING DEPARTMENT

APPROVED BY:
VICTOR MATTHEW R. SOTTO
CITY MAYOR

SHEET CONTENTS:
DETAIL SECTIONS
SHEET NO.:
A
38
39

REMARKS/NOTES:
1. NO ALTERATION IN LOADS & PRESENTATION SHALL BE MADE WITHOUT THE APPROVAL OF THE ARCHITECT AND ENGINEER.
2. CONTRACTOR SHALL BE RESPONSIBLE FOR THE PROTECTION OF EXISTING UTILITIES AND STRUCTURES.
3. THE CONTRACTOR SHALL BE RESPONSIBLE FOR THE PROTECTION OF EXISTING UTILITIES AND STRUCTURES.
4. THE CONTRACTOR SHALL BE RESPONSIBLE FOR THE PROTECTION OF EXISTING UTILITIES AND STRUCTURES.
5. THE CONTRACTOR SHALL BE RESPONSIBLE FOR THE PROTECTION OF EXISTING UTILITIES AND STRUCTURES.
6. THE CONTRACTOR SHALL BE RESPONSIBLE FOR THE PROTECTION OF EXISTING UTILITIES AND STRUCTURES.
7. THE CONTRACTOR SHALL BE RESPONSIBLE FOR THE PROTECTION OF EXISTING UTILITIES AND STRUCTURES.
8. THE CONTRACTOR SHALL BE RESPONSIBLE FOR THE PROTECTION OF EXISTING UTILITIES AND STRUCTURES.
9. THE CONTRACTOR SHALL BE RESPONSIBLE FOR THE PROTECTION OF EXISTING UTILITIES AND STRUCTURES.
10. THE CONTRACTOR SHALL BE RESPONSIBLE FOR THE PROTECTION OF EXISTING UTILITIES AND STRUCTURES.

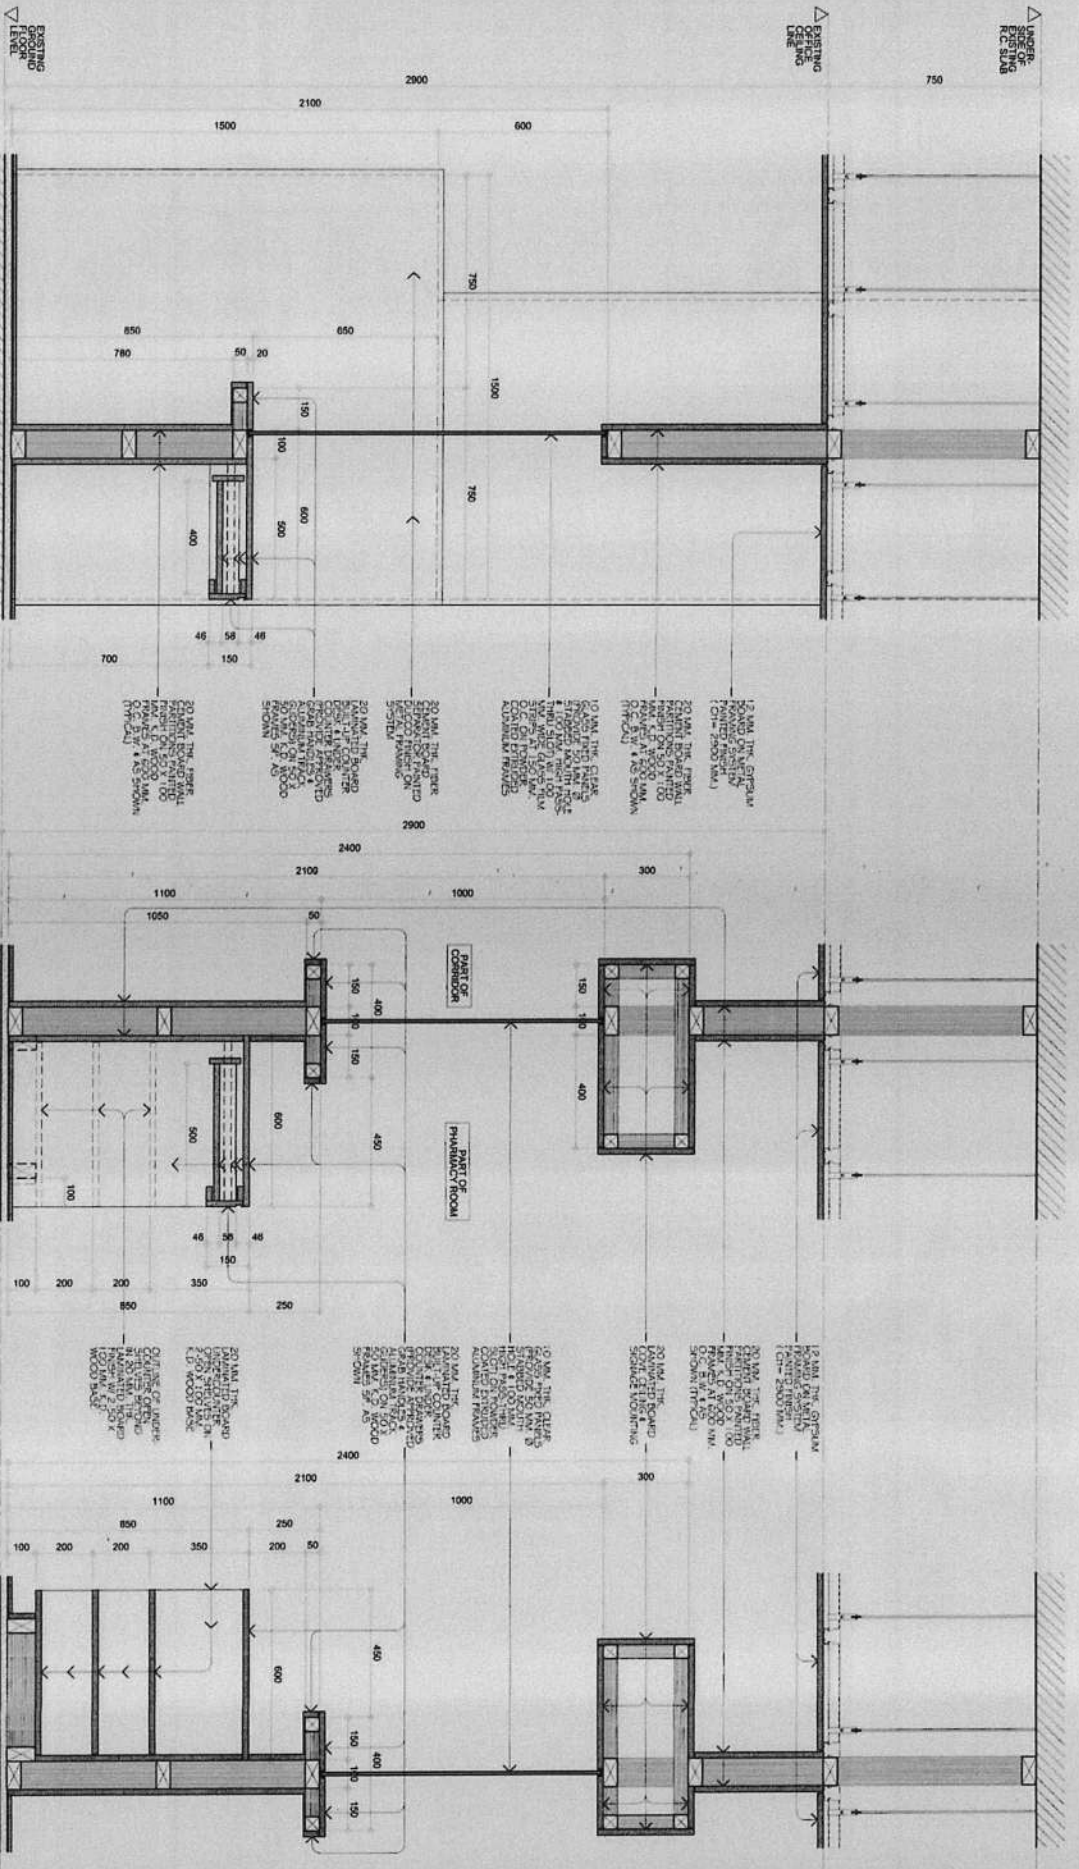

REPUBLIC OF THE PHILIPPINES
CITY OF PASIG
OFFICE OF THE MAYOR
ENGINEERING DEPARTMENT

PROJECT TITLE:
**PROPOSED EXPANSION W/
IMPROVEMENT WORKS AT
PASIG CITY CHILDREN'S HOSPITAL**

LOCATION:
INDUSTRIAL CORP. ALIQUOPE JOSE STS.
BAYANANG PASIG

ARCHITECTURAL:
ARCH. LEY V. OLIVAR
ARCHITECT

ARCH. ELMER ESTRADA
ARCHITECT

PROGRAMMING & CONSTRUCTION:
ENGR. ISABEL RAMIREZ
ENGR. JAYSON M. VILLO


RECOMMENDING APPROVAL:
ENGR. ARTAVENY V. GERONIMO
O.I.C. ENGINEERING DEPARTMENT

APPROVED BY:
VICTOR M. REGIS N. SOTTO
CITY MAYOR

SHEET CONTENTS:
DETAIL SECTIONS

SHEET NO.:
A
37 / **39**

IMPORTANT NOTES:
1. FOR ALL MATERIALS AND SPECIFICATIONS SHALL BE IN ACCORDANCE WITH THE NATIONAL BUREAU OF STANDARDS (BUREAU OF TECHNICAL STANDARDS) OF THE PHILIPPINES.
2. IN ANY CASE, THE CONTRACTOR SHALL BE RESPONSIBLE FOR THE QUALITY OF THE WORK AND THE COMPLETION OF THE PROJECT SHALL BE AT HIS OWN RISK.
3. IN CASE OF ANY DISCREPANCY BETWEEN THE DRAWINGS AND THE CONTRACT DOCUMENTS, THE CONTRACTOR SHALL BE RESPONSIBLE FOR THE CORRECTION OF THE SAME.
4. THE CONTRACTOR SHALL BE RESPONSIBLE FOR THE PROTECTION OF THE EXISTING UTILITIES AND STRUCTURES TO REMAIN.

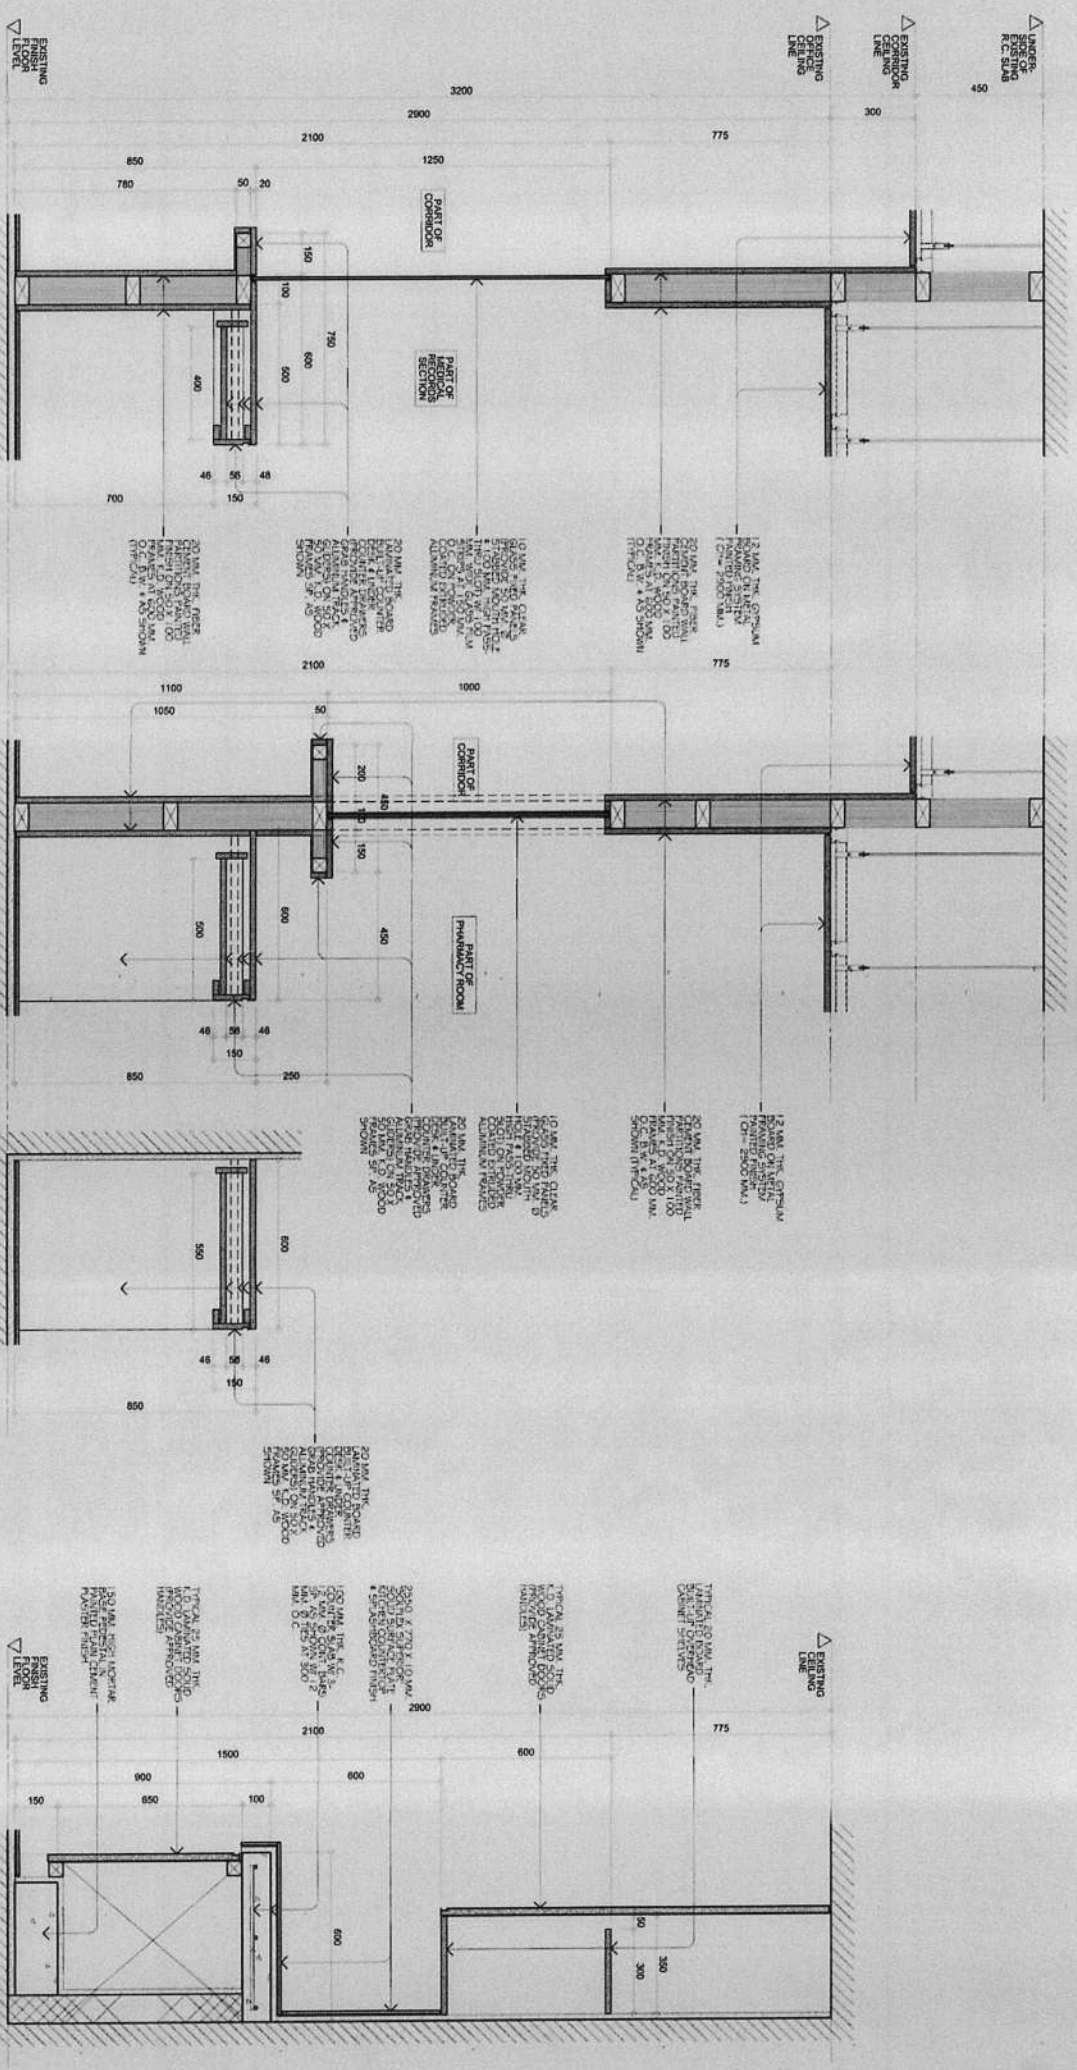

01
SCALE
1:10 MM

02
SCALE
1:10 MM

03
SCALE
1:10 MM

04
SCALE
1:10 MM



REPUBLIC OF THE PHILIPPINES
CITY OF PASIG

PROPOSED EXPANSION WITH
IMPROVED CHILDREN'S HOSPITAL
PASIG CITY CHILDREN'S HOSPITAL
LOCATION: INDUSTRIAL COR. ALCOVE JOSE STS.
PASIG CITY

ARCHITECTURAL:
ARCH. JERRY OLIVAR
ARCHITECTURAL DESIGNER
ARCH. ELMER ESTRADA
ARCHITECT

PROGRAMMING & CONSTRUCTION:
ENGR. JERRY MANSES
PROJECTS
ENGR. ROBERTO A. AGUIRO
PROJECTS


RECOMMENDING APPROVAL:
ENGR. RAFAEL BAQUEN
ENGR. RAFAEL BAQUEN
ENGR. RAFAEL BAQUEN

ENGR. ARTAVERDES BERONIMO
O.C. ENGINEERING DIVISION

APPROVED BY:
VICTOR M. REGIS N. SOTTO
CITY MAYOR


SHEET CONTENTS: DETAIL SECTIONS
SHEET NO.: A
38 39

IMPORTANT NOTES:
1. ALL MATERIALS SHALL BE USED AS SPECIFIED IN THE DRAWINGS.
2. ALL MATERIALS SHALL BE USED AS SPECIFIED IN THE DRAWINGS.
3. THE GOVERNING CODE WILL BE BASED ON APPROVED PLANS & SPECIFICATIONS.
4. ALL MATERIALS SHALL BE USED AS SPECIFIED IN THE DRAWINGS.
5. THE FINISHES OF WORKS IS FROM RECOMMENDED FINISHES ONLY.

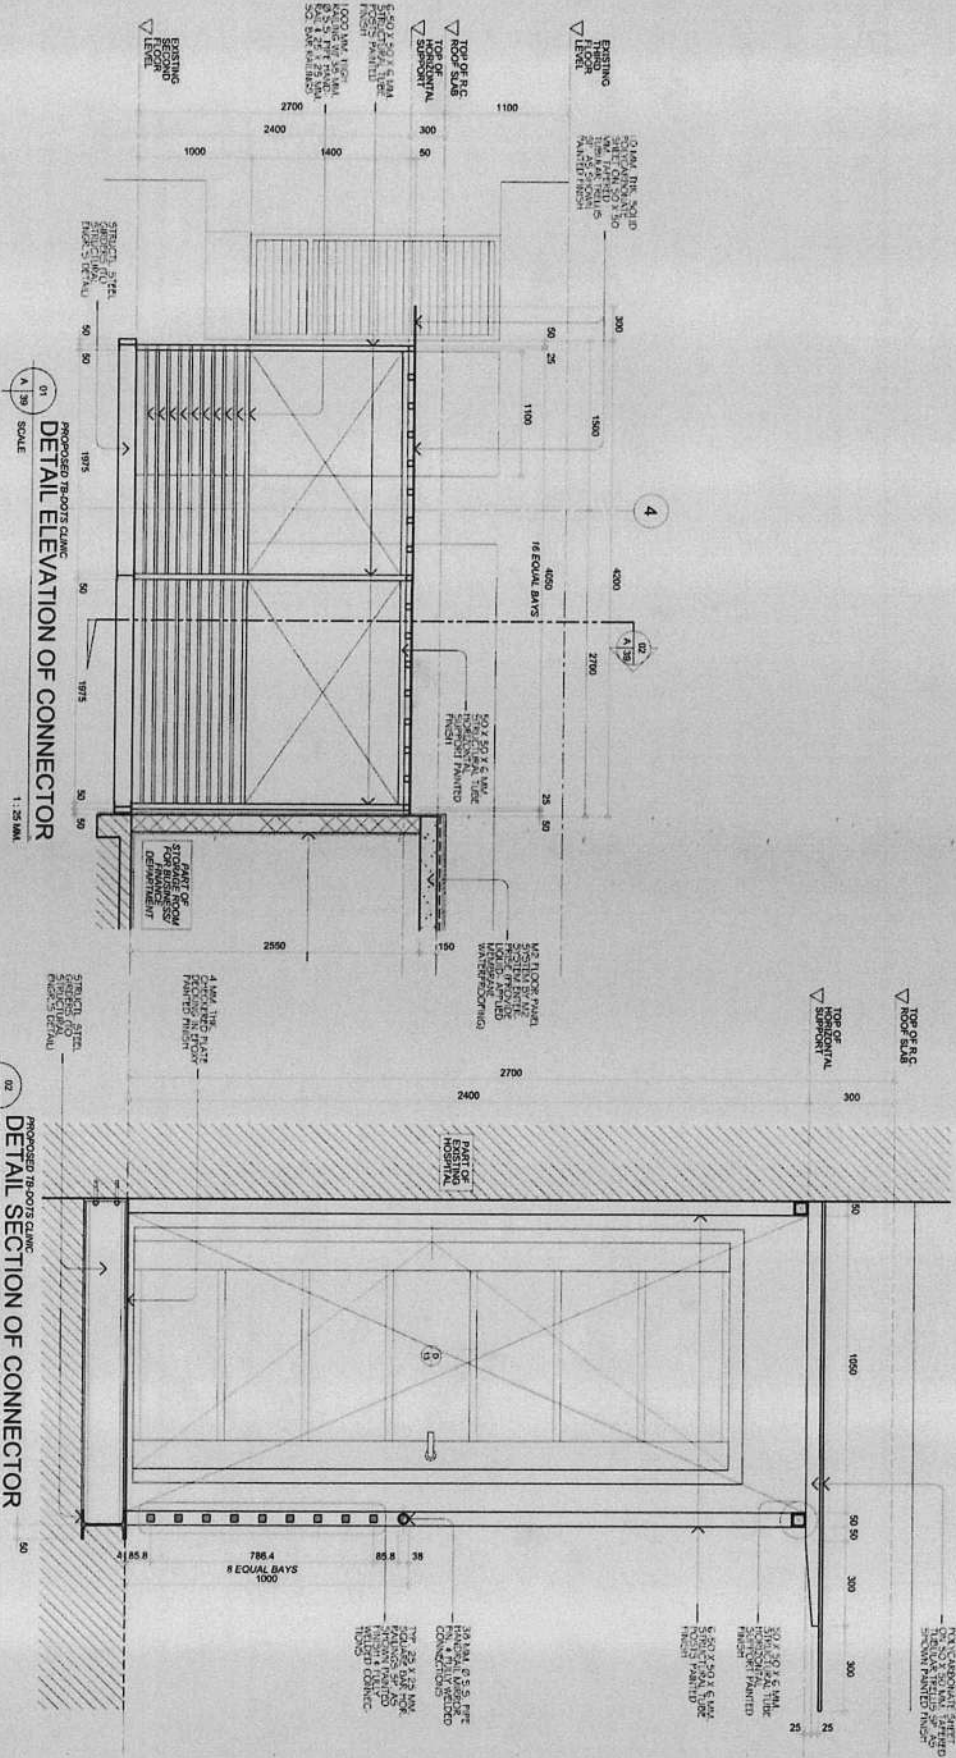

	REPUBLIC OF THE PHILIPPINES CITY OF MAKAO ENGINEERING DEPARTMENT	PROJECT TITLE: PROPOSED EXPANSION W/ IMPROVEMENT WORKS AT PASIG CITY CHILDREN'S HOSPITAL	ARCHITECTURAL: ARCHT. LEVI OLIVAR ARCHT. ELIENEC ESTRADA	PROGRAMMING & CONSTRUCTION: ENGR. ISABEL FRANCES ENGR. E. A. P. A.	RECOMMENDING APPROVAL: ENGR. FRANCISCO RAUJENDICO ENGR. ARTAVERKES V. GERONIMO	APPROVED BY: VICTOR M. REGIS 'N. SOTTO CITY MAYOR	SHEET CONTENTS: 03 A	SHEET NO.: 39 39
--	---	--	--	--	--	--	-----------------------------------	----------------------------

1. ALL WORK SHALL BE IN ACCORDANCE WITH THE PHILIPPINE NATIONAL STANDARD (PNS) AND THE PHILIPPINE ENGINEERING COUNCIL (PEC) RECOMMENDATIONS.
 2. ALL WORK SHALL BE IN ACCORDANCE WITH THE PHILIPPINE NATIONAL STANDARD (PNS) AND THE PHILIPPINE ENGINEERING COUNCIL (PEC) RECOMMENDATIONS.
 3. IN CASE OF DISCREPANCY IN THE DRAWINGS, THE CONTRACTOR SHALL BE RESPONSIBLE FOR THE CLARIFICATION AND CORRECTION OF THE DRAWINGS.
 4. THE CONTRACTOR SHALL BE RESPONSIBLE FOR THE PROTECTION OF ALL EXISTING UTILITIES AND STRUCTURES.
 5. THE CONTRACTOR SHALL BE RESPONSIBLE FOR THE PROTECTION OF ALL EXISTING UTILITIES AND STRUCTURES.
 6. THE CONTRACTOR SHALL BE RESPONSIBLE FOR THE PROTECTION OF ALL EXISTING UTILITIES AND STRUCTURES.
 7. THE CONTRACTOR SHALL BE RESPONSIBLE FOR THE PROTECTION OF ALL EXISTING UTILITIES AND STRUCTURES.
 8. THE CONTRACTOR SHALL BE RESPONSIBLE FOR THE PROTECTION OF ALL EXISTING UTILITIES AND STRUCTURES.
 9. THE CONTRACTOR SHALL BE RESPONSIBLE FOR THE PROTECTION OF ALL EXISTING UTILITIES AND STRUCTURES.
 10. THE CONTRACTOR SHALL BE RESPONSIBLE FOR THE PROTECTION OF ALL EXISTING UTILITIES AND STRUCTURES.

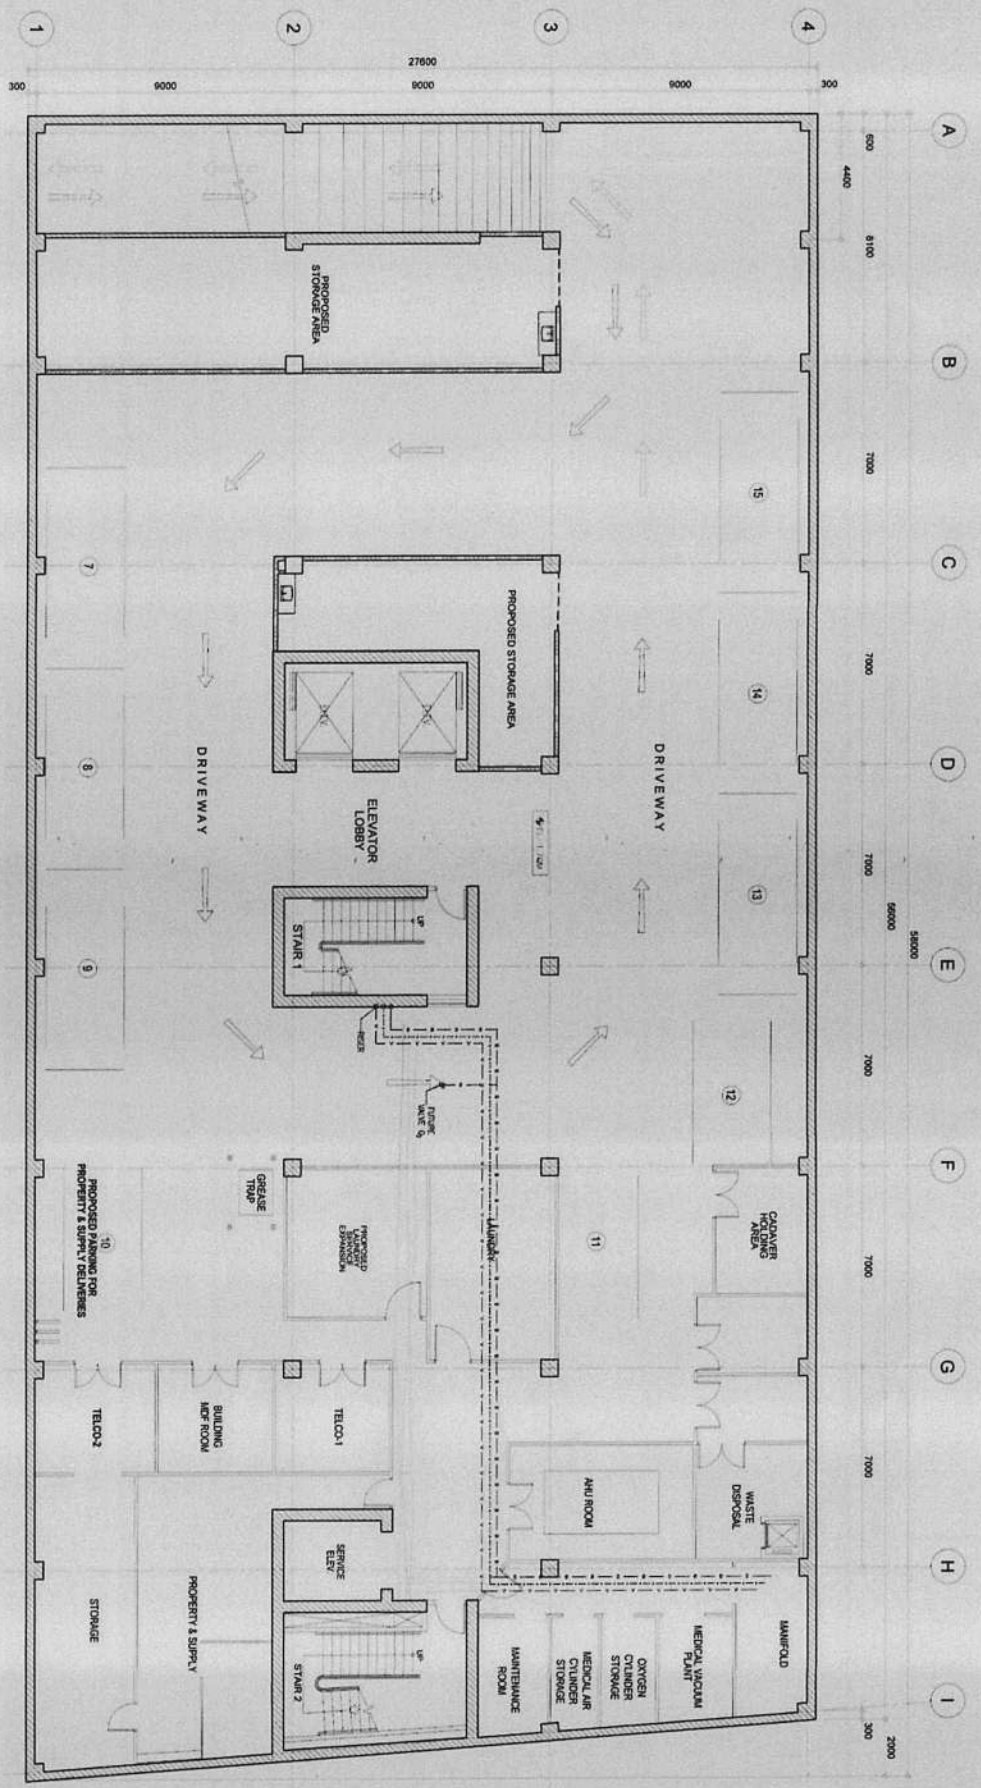


GAS PIPING LAYOUT
EXISTING BASEMENT FLOOR PLAN
SCALE 1:100 MM

	REPUBLIC OF THE PHILIPPINES OFFICE OF THE MAYOR ENGINEERING DEPARTMENT	PROJECT TITLE PROPOSED EXPANSION W/ IMPROVEMENT WORKS AT PASIG CITY CHILDREN'S HOSPITAL	PROJECT IN CHARGE ENGR. ROMER R. ANGELO, JR. ENGR. JAY R. ROSARIO, JR. ENGR. JAY R. ROSARIO, JR.	PROGRAMMING & CONSTRUCTION ENGR. ISABEL R. RAMOSSES ENGR. ISABEL R. RAMOSSES	RECOMMENDING APPROVAL ENGR. EDUARDO B. TRINIDAD ENGR. EDUARDO B. TRINIDAD	APPROVED BY VICTOR M. REGISIN SOTTO CITY MAYOR	SHEET COMMENTS EXISTING GAS PIPING LAYOUT	SHEET NO. M 01 09
	PROJECT TITLE PROPOSED EXPANSION W/ IMPROVEMENT WORKS AT PASIG CITY CHILDREN'S HOSPITAL	LOCATION INDUSTRIAL COR. ALCAQUE JOSE STS. PASIG CITY	PROJECT IN CHARGE ENGR. ROMER R. ANGELO, JR. ENGR. JAY R. ROSARIO, JR. ENGR. JAY R. ROSARIO, JR.	PROGRAMMING & CONSTRUCTION ENGR. ISABEL R. RAMOSSES ENGR. ISABEL R. RAMOSSES	RECOMMENDING APPROVAL ENGR. EDUARDO B. TRINIDAD ENGR. EDUARDO B. TRINIDAD	APPROVED BY VICTOR M. REGISIN SOTTO CITY MAYOR	SHEET COMMENTS EXISTING GAS PIPING LAYOUT	SHEET NO. M 01 09

APPROVAL NOTES

1. NO. 1. THE CONTRACTOR SHALL BE RESPONSIBLE FOR THE PROTECTION OF ALL EXISTING UTILITIES AND STRUCTURES TO REMAIN.
2. THE CONTRACTOR SHALL BE RESPONSIBLE FOR THE PROTECTION OF ALL EXISTING UTILITIES AND STRUCTURES TO REMAIN.
3. THE CONTRACTOR SHALL BE RESPONSIBLE FOR THE PROTECTION OF ALL EXISTING UTILITIES AND STRUCTURES TO REMAIN.
4. APPROVAL OF THIS INSTRUMENT SHALL BE CONSIDERED AT THE EXPENSE OF THE CONTRACTOR.
5. THE CONTRACTOR SHALL BE RESPONSIBLE FOR THE PROTECTION OF ALL EXISTING UTILITIES AND STRUCTURES TO REMAIN.
6. THE CONTRACTOR SHALL BE RESPONSIBLE FOR THE PROTECTION OF ALL EXISTING UTILITIES AND STRUCTURES TO REMAIN.

CONTRACTOR

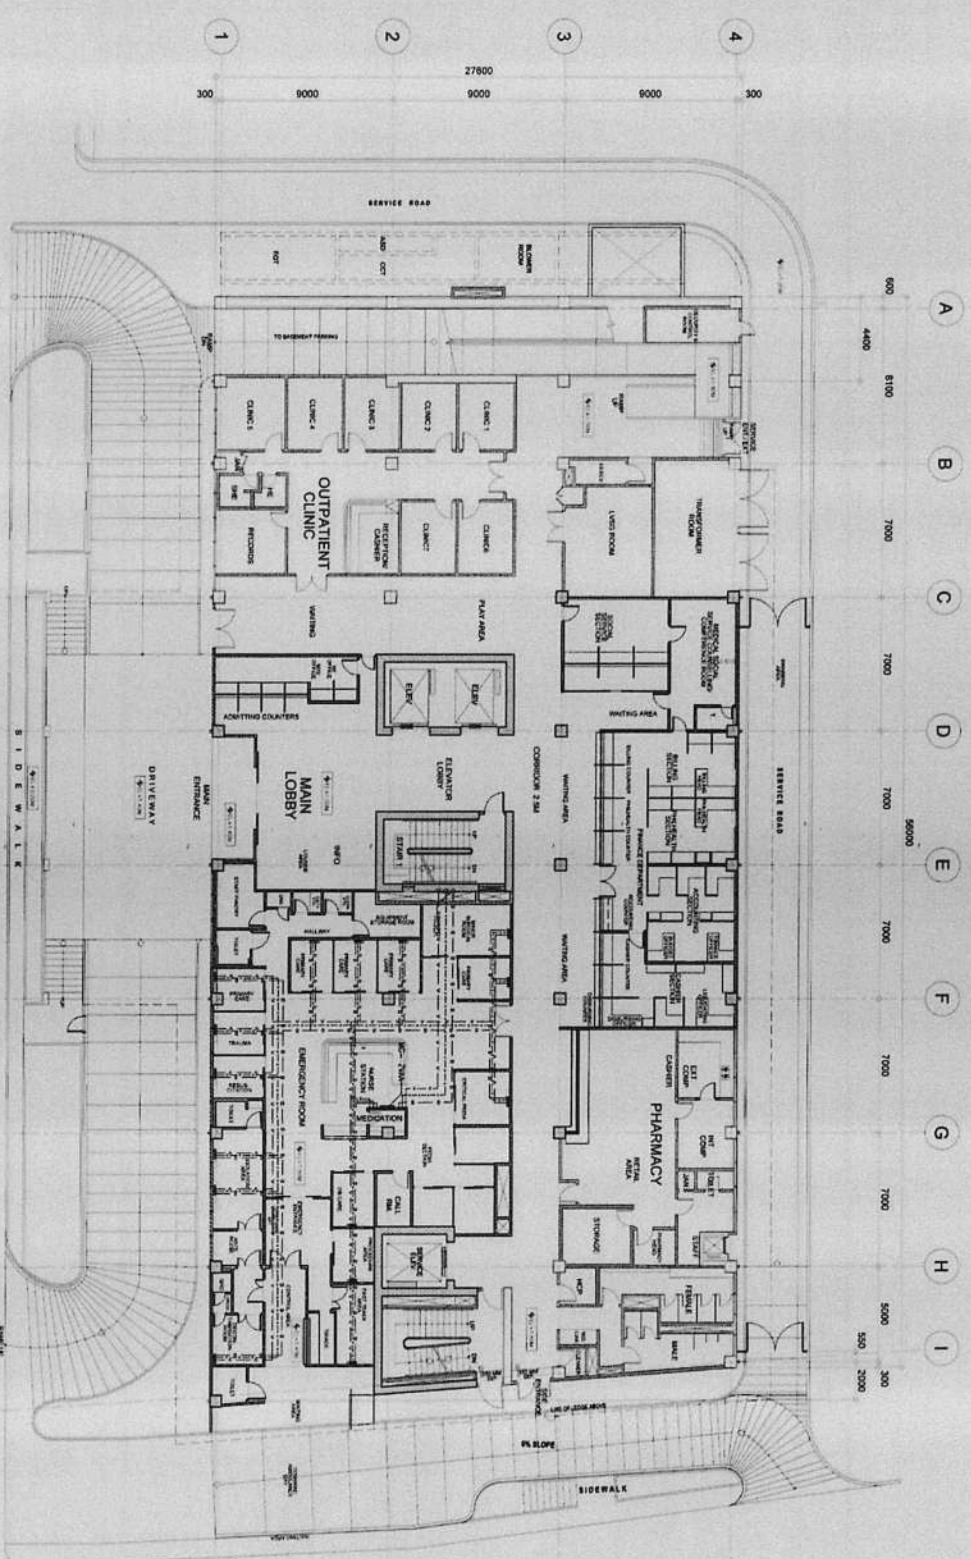


**GAS PIPING LAYOUT
EXISTING GROUND FLOOR PLAN**
SCALE 1:150 MM


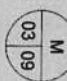
	REPUBLIC OF THE PHILIPPINES CITY OF PASIG OFFICE OF THE MAYOR ENGINEERING DEPARTMENT	PROJECT TITLE PROPOSED EXPANSION W/ IMPROVEMENT WORKS AT PASIG CITY CHILDREN'S HOSPITAL	PROJECT IN CHARGE ENGR. ROBERTO R. ARCEO, JR.	PROGRAMMING & CONSTRUCTION ENGR. ISAAC S. SANESES CHIEF ARCHITECT	RECOMMENDING APPROVAL ENGR. WILSON B. BRUDENIO CHIEF ENGINEER	APPROVED BY VICTOR MAR REGIS N. SOTTO CITY MAYOR	SHEET CONTENTS: GAS PIPING LAYOUT EXISTING GROUND FLOOR PLAN	SHEET NO.: M 02/09
	LOCATION: INDUSTRIAL COR. ALCALDE JOSE BITE INDUSTRIAL PASIG CITY	PROJECT IN CHARGE ENGR. JUAN ROBERTO NERIZ PROJECT ARCHITECT	RECOMMENDING APPROVAL ENGR. WILSON B. BRUDENIO CHIEF ENGINEER	APPROVED BY VICTOR MAR REGIS N. SOTTO CITY MAYOR	SHEET CONTENTS: GAS PIPING LAYOUT EXISTING GROUND FLOOR PLAN	SHEET NO.: M 02/09	CONTRACTOR COMORME & ACCEPTED BY	CONTRACTOR

IMPORTANT NOTES:


1. CONTRACTOR SHALL VERIFY ALL DIMENSIONS AND LOCATIONS OF EXISTING UTILITIES AND STRUCTURES BEFORE COMMENCING WORK.
2. CONTRACTOR SHALL VERIFY ALL DIMENSIONS AND LOCATIONS OF EXISTING UTILITIES AND STRUCTURES BEFORE COMMENCING WORK.
3. CONTRACTOR SHALL VERIFY ALL DIMENSIONS AND LOCATIONS OF EXISTING UTILITIES AND STRUCTURES BEFORE COMMENCING WORK.
4. CONTRACTOR SHALL VERIFY ALL DIMENSIONS AND LOCATIONS OF EXISTING UTILITIES AND STRUCTURES BEFORE COMMENCING WORK.

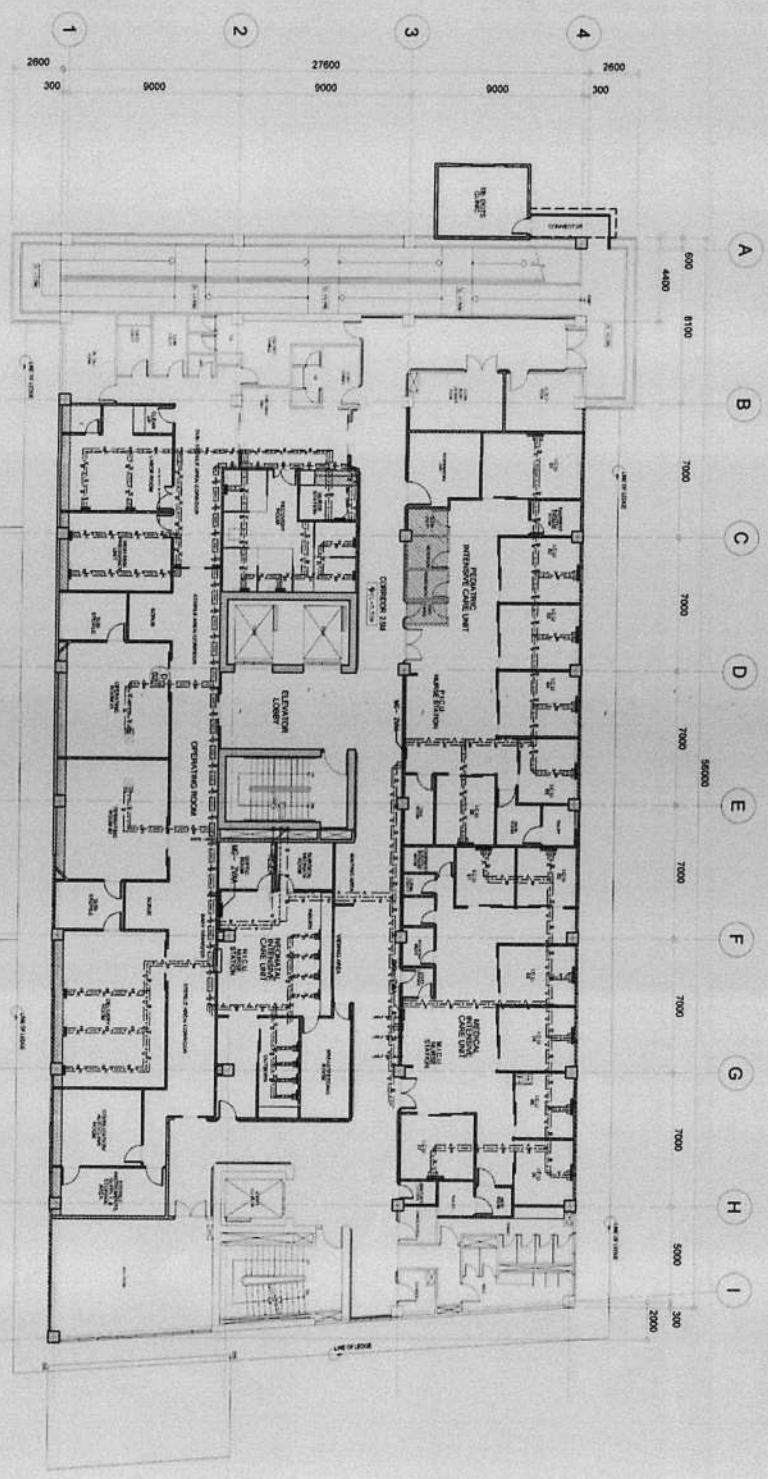


01
 GAS PIPING LAYOUT
 EXISTING SECOND FLOOR PLAN
 1/100MM
 SCALE

 REPUBLIC OF THE PHILIPPINES CITY OF PASIG OFFICE OF THE MAYOR ENGINEERING DEPARTMENT	PROJECT TITLE:	PROJECT IN CHARGE:	PROGRAMMING & CONSTRUCTION:	RECOMMENDING APPROVAL:	APPROVED BY:	SHEET CONTENTS:	SHEET NO.:
	PROPOSED EXPANSION W/ IMPROVEMENT WORKS AT PASIG CITY CHILDRENS HOSPITAL LOCATION: INDUSTRIAL COR. ACACUE JOSE STS. KAYANGAN, PASIG CITY	ENGR. ROMEO R. ARCEO, JR. ENGR. <i>[Signature]</i> ENGR. ISRAEL V. RAÑEZES ENGR. <i>[Signature]</i> ENGR. PRUDENCIO ENGR. ARTAVERDES V. GERONIMO	ENGR. <i>[Signature]</i> ENGR. <i>[Signature]</i> ENGR. <i>[Signature]</i> ENGR. <i>[Signature]</i>	ENGR. <i>[Signature]</i> ENGR. <i>[Signature]</i> ENGR. <i>[Signature]</i> ENGR. <i>[Signature]</i>	VICTOR M. REGIS N. SOTTO CITY MAYOR	EXISTING SECOND FLOOR PIPING LAYOUT CAD: ECESTHOLA CONFIRMED & ACCEPTED BY: 	CONTRACTOR


IMPORTANT NOTES:
 1. NO. 1. THIS SHALL BE USED AS REFERENCE FOR THE PROJECT TITLE AND LOCATION.
 2. FOR THE CITY OF PASIG, THE ENGINEERING DEPARTMENT OF THE CITY OF PASIG SHALL BE THE AUTHORITY IN THE REVIEW AND APPROVAL OF THE PROJECT.
 3. THE CONTRACTOR SHALL BE RESPONSIBLE FOR THE PROVISION OF ALL NECESSARY PERMITS AND APPROVALS FROM THE CITY OF PASIG.
 4. THE CONTRACTOR SHALL BE RESPONSIBLE FOR THE PROVISION OF ALL NECESSARY PERMITS AND APPROVALS FROM THE CITY OF PASIG.
 5. THE CONTRACTOR SHALL BE RESPONSIBLE FOR THE PROVISION OF ALL NECESSARY PERMITS AND APPROVALS FROM THE CITY OF PASIG.
 6. THE CONTRACTOR SHALL BE RESPONSIBLE FOR THE PROVISION OF ALL NECESSARY PERMITS AND APPROVALS FROM THE CITY OF PASIG.

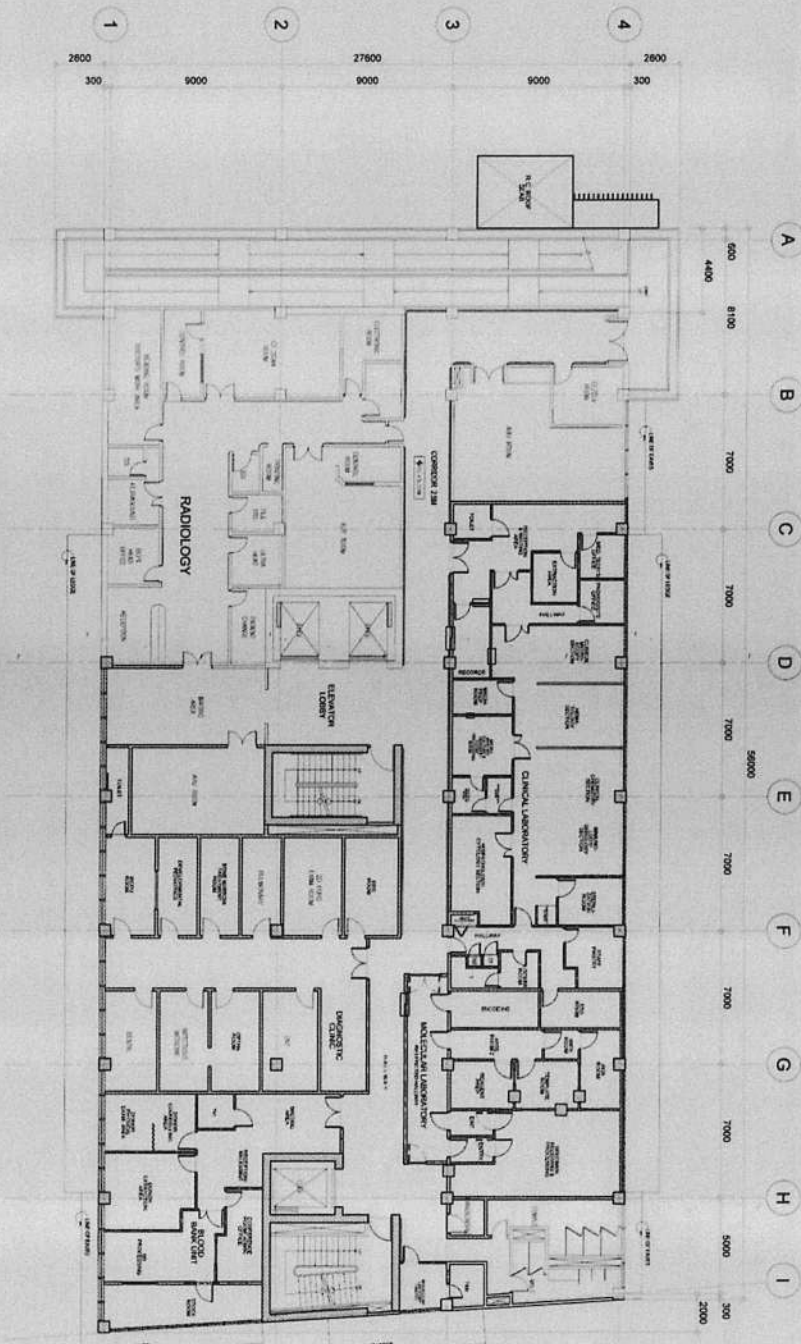


01
 GAS PIPING LAYOUT
 EXISTING THIRD FLOOR PLAN
 SCALE 1:150 DIM.

	REPUBLIC OF THE PHILIPPINES CITY OF PASIG OFFICE OF THE MAYOR ENGINEERING DEPARTMENT	PROJECT TITLE: PROPOSED EXPANSION W/ IMPROVEMENTS IN PASIG CITY CHILDREN'S HOSPITAL	PROJECT IN CHARGE: ENGR. ROMEO R. ARCEO, JR. PROJECT MANAGER
IMPORTANT NOTES: 1. NO PART OF THIS PLAN SHALL BE USED FOR ANY OTHER PROJECT WITHOUT THE WRITTEN PERMISSION OF THE ENGINEER. 2. IN THE EVENT OF ANY DISCREPANCY BETWEEN THIS PLAN AND THE ORIGINAL CONTRACT DOCUMENTS, THE CONTRACT DOCUMENTS SHALL PREVAIL. 3. THIS PLAN IS THE PROPERTY OF THE ENGINEER AND SHALL BE KEPT IN HIS OFFICE FOR THE CONSTRUCTION OF THE PROJECT. 4. APPROVAL OF THIS INSTRUMENT SHALL BE CONSIDERED AS ACCEPTANCE OF THE CONSTRUCTION OF THE PROJECT. 5. THIS IS A REPORT TO THE DEPARTMENT OF HEALTH AND HUMAN SERVICES, PASIG CITY. 6. THIS IS A REPORT TO THE DEPARTMENT OF HEALTH AND HUMAN SERVICES, PASIG CITY.		PROGRAMMING & CONSTRUCTION: ENGR. ISRAEL V. RAVERES CHIEF ENGINEER	
RECOMMENDING APPROVAL: ENGR. ENRIQUE B. BRINDENCO CHIEF ENGINEER		APPROVED BY: VICTOR M. REGIS N. SOTTO CITY MANOR	
SHEET CONTENTS: GAS PIPING LAYOUT CAD: ECESTRADA		SHEET NO.: <div style="border: 1px solid black; border-radius: 50%; width: 30px; height: 30px; display: flex; align-items: center; justify-content: center; margin: 0 auto;"> M 04 09 </div>	


CONTRACTOR

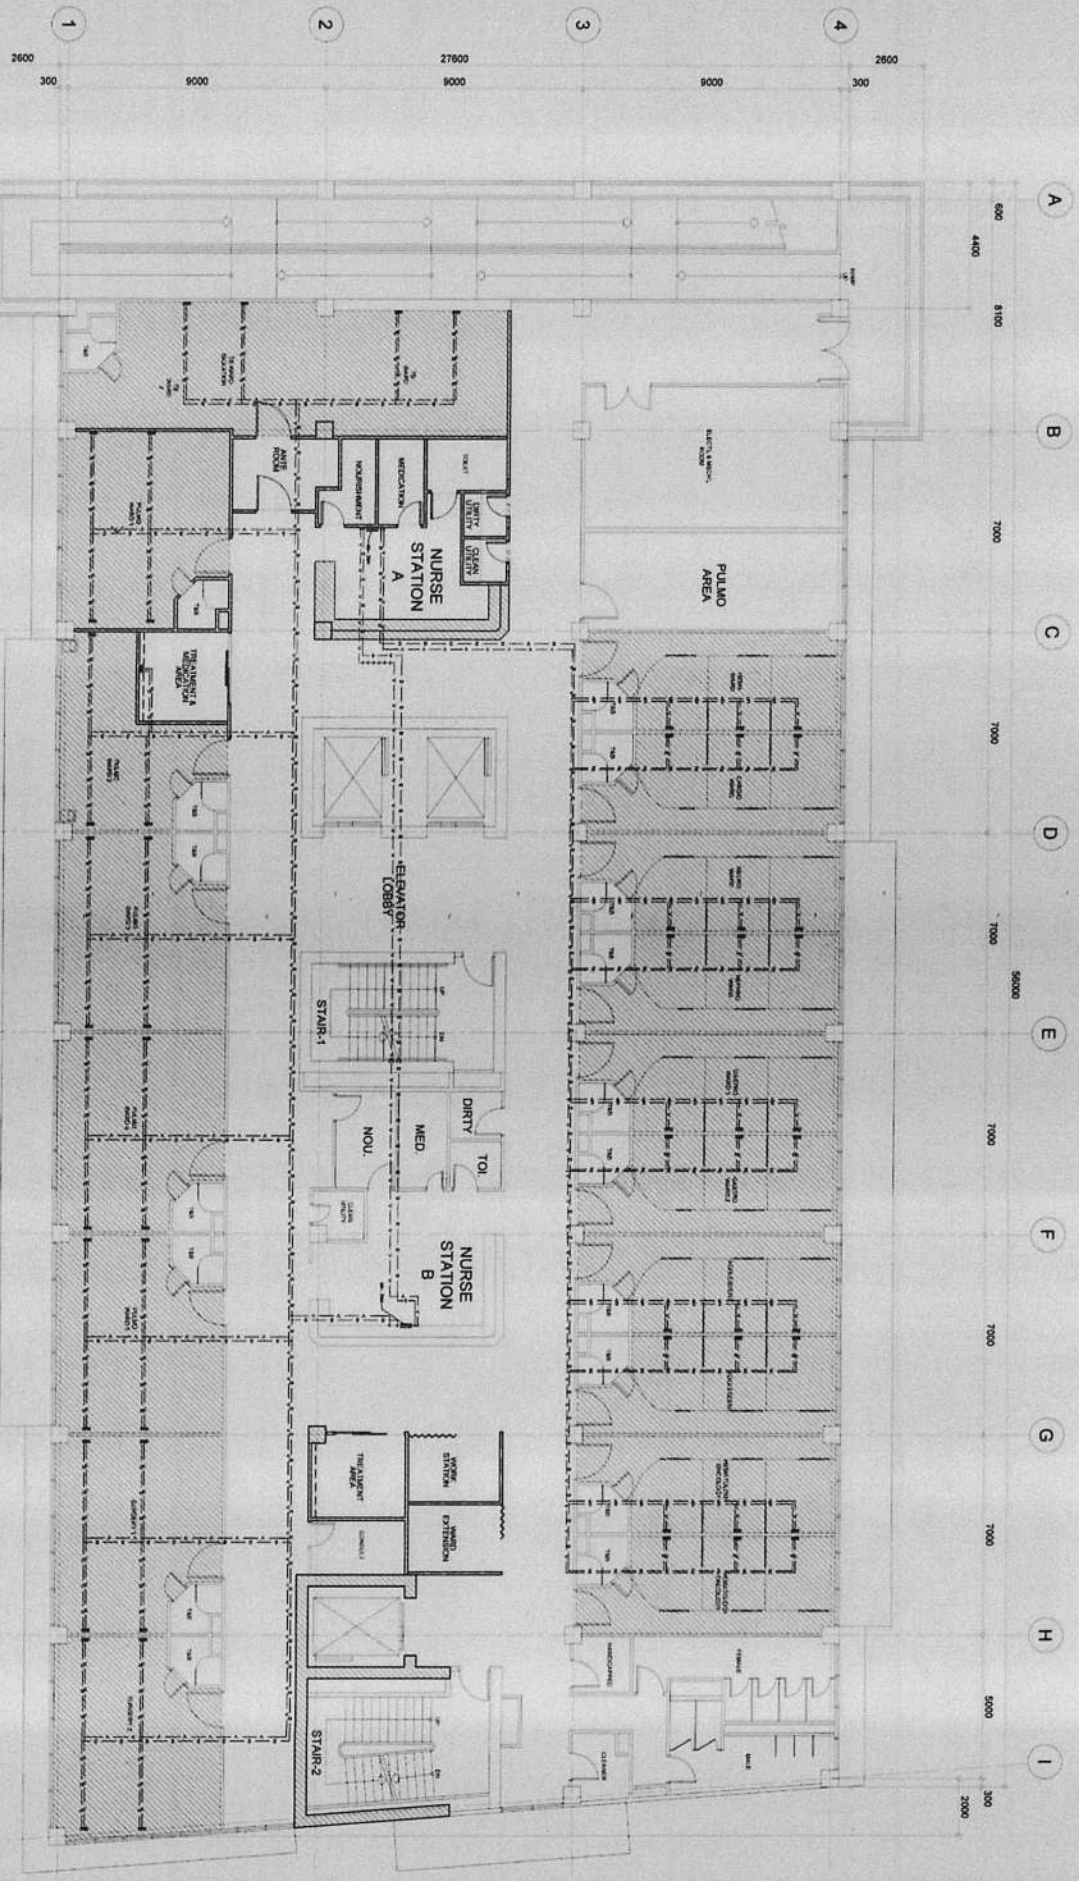

GAS PIPING LAYOUT
 EXISTING FOURTH FLOOR PLAN
 1:100 MM


	REPUBLIC OF THE PHILIPPINES CITY OF PASIG OFFICE OF THE MAYOR ENGINEERING DEPARTMENT	PROJECT TITLE PROPOSED EXPANSION W/ IMPROVEMENT WORKS AT PASIG CITY CHILDREN'S HOSPITAL LOCATION: MONTEBONA COR. AT CUNYRE JOSE STS.	PROJECT IN CHARGE: ENGR. ROMEO B. ESCOBAR, JR. ENGR. <i>[Signature]</i>	PROGRAMMING & CONSTRUCTION: ENGR. ISABEL V. RADESES CHIEF, GENERAL PRODUCTS	RECOMMENDING APPROVAL: ENGR. EDUARDO B. FRIEDENCO CHIEF, MECHANICAL DIVISION	APPROVED BY: ENGR. ARTAVERDES V. GERONIMO CHIEF, ENGINEERING DEPARTMENT	SHEET CONTENTS: EXISTING GAS PIPING LAYOUT CAD: ECESTRADA	SHEET NO.: <div style="border: 1px solid black; border-radius: 50%; width: 30px; height: 30px; display: flex; align-items: center; justify-content: center; margin: 0 auto;"> M 05/09 </div>
IMPORTANT NOTES: 1. FOR ALL WORKS TO BE DONE, THE CONTRACTOR SHALL OBTAIN THE NECESSARY PERMITS FROM THE CITY ENGINEERING DEPARTMENT. 2. IN ANY CASE, THE CONTRACTOR SHALL BE RESPONSIBLE FOR THE PROTECTION OF ALL EXISTING UTILITIES AND STRUCTURES. 3. THE SCALE OF THIS DRAWING IS AS INDICATED. THE CONTRACTOR SHALL BE RESPONSIBLE FOR THE PROTECTION OF ALL EXISTING UTILITIES AND STRUCTURES. 4. THE CONTRACTOR SHALL BE RESPONSIBLE FOR THE PROTECTION OF ALL EXISTING UTILITIES AND STRUCTURES. 5. THE CONTRACTOR SHALL BE RESPONSIBLE FOR THE PROTECTION OF ALL EXISTING UTILITIES AND STRUCTURES. 6. THE CONTRACTOR SHALL BE RESPONSIBLE FOR THE PROTECTION OF ALL EXISTING UTILITIES AND STRUCTURES.		CONTRACTOR: <div style="border: 1px solid black; border-radius: 50%; width: 30px; height: 30px; display: flex; align-items: center; justify-content: center; margin: 0 auto;"> M 05/09 </div>						

CONTRACTOR

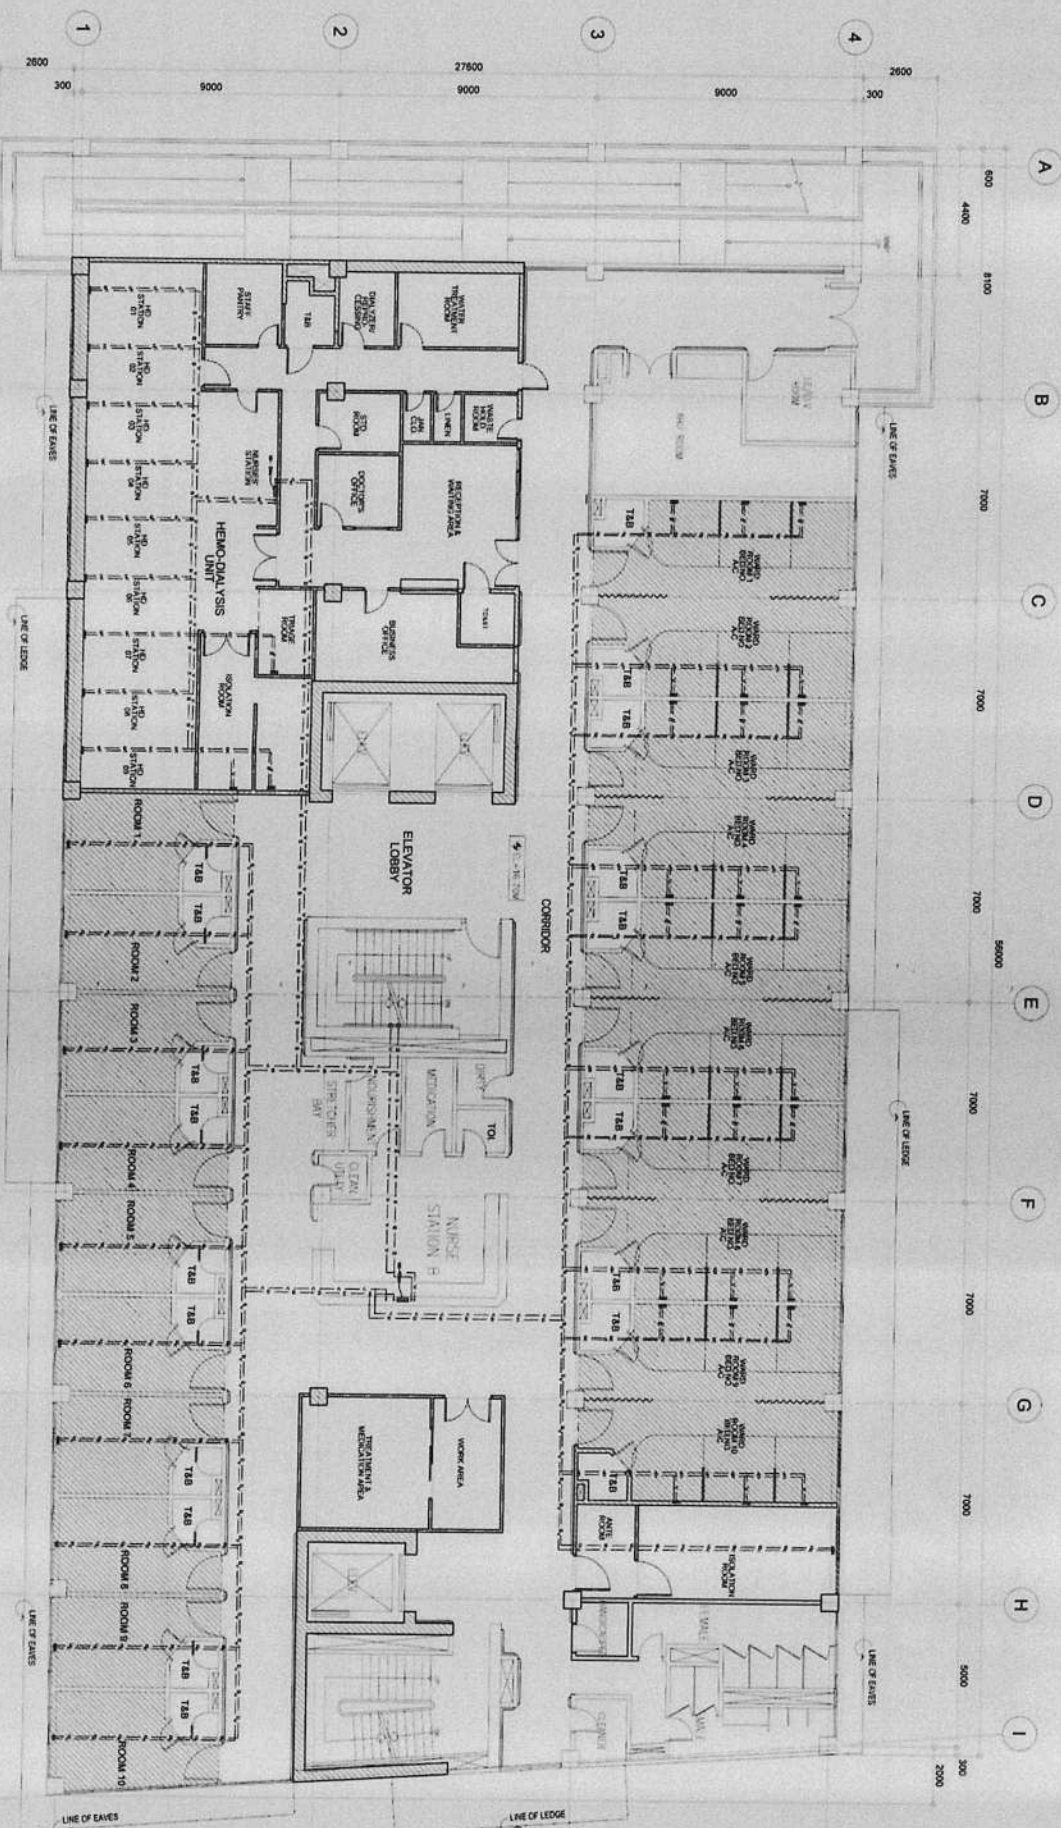





 GAS PIPING LAYOUT
 EXISTING FIFTH FLOOR PLAN
 1:100 MM


	REPUBLIC OF THE PHILIPPINES CITY OF PASIG OFFICE OF THE MAYOR ENGINEERING DEPARTMENT	PROJECT TITLE: PROPOSED EXPANSION W/ IMPROVEMENT WORKS AT PASIG CITY CHILDRENS HOSPITAL	PROJECT IN CHARGE: ENGR. ROMEO B. ARCO, JR. ENGR. DAN KRISTOFF PEREZ	PROGRAMMING & CONSTRUCTION: ENGR. JESPER R. RANERES	RECOMMENDING APPROVAL: ENGR. LUIS M. PUNDECIO ENGR. ARTABERNOS V. GERONIMO	APPROVED BY: VICTOR MA. REGIS N. SOTTO CITY MAYOR	SHEET CONTENTS: EXISTING GAS PIPING LAYOUT	SHEET NO.: <div style="border: 1px solid black; border-radius: 50%; width: 30px; height: 30px; display: flex; align-items: center; justify-content: center; margin: 0 auto;"> M 06 09 </div>			
IMPORTANT NOTES: 1. NO UTILITIES OR PARTS OF UTILITIES SHALL BE MOVED OR ALTERED WITHOUT THE APPROVAL OF THE STRUCTURAL ENGINEER. 2. IN ANY CASE, THE CONTRACTOR SHALL BE RESPONSIBLE FOR OBTAINING ALL NECESSARY PERMITS AND APPROVALS FROM THE CITY ENGINEER. 3. TO BE ACCURATE, THE CONTRACTOR SHALL VERIFY THE EXISTING UTILITIES AND CONDITIONS ON THE SITE. 4. THE CONTRACTOR SHALL BE RESPONSIBLE FOR THE PROTECTION OF ALL UTILITIES AND STRUCTURES TO REMAIN.		LOCATION: INDUSTRIAL ZONE, CALATE JOSE STS.		RECOMMENDING APPROVAL: ENGR. LUIS M. PUNDECIO ENGR. ARTABERNOS V. GERONIMO		APPROVED BY: VICTOR MA. REGIS N. SOTTO CITY MAYOR		SHEET CONTENTS: EXISTING GAS PIPING LAYOUT		SHEET NO.: <div style="border: 1px solid black; border-radius: 50%; width: 30px; height: 30px; display: flex; align-items: center; justify-content: center; margin: 0 auto;"> M 06 09 </div>	

CONTRACTOR

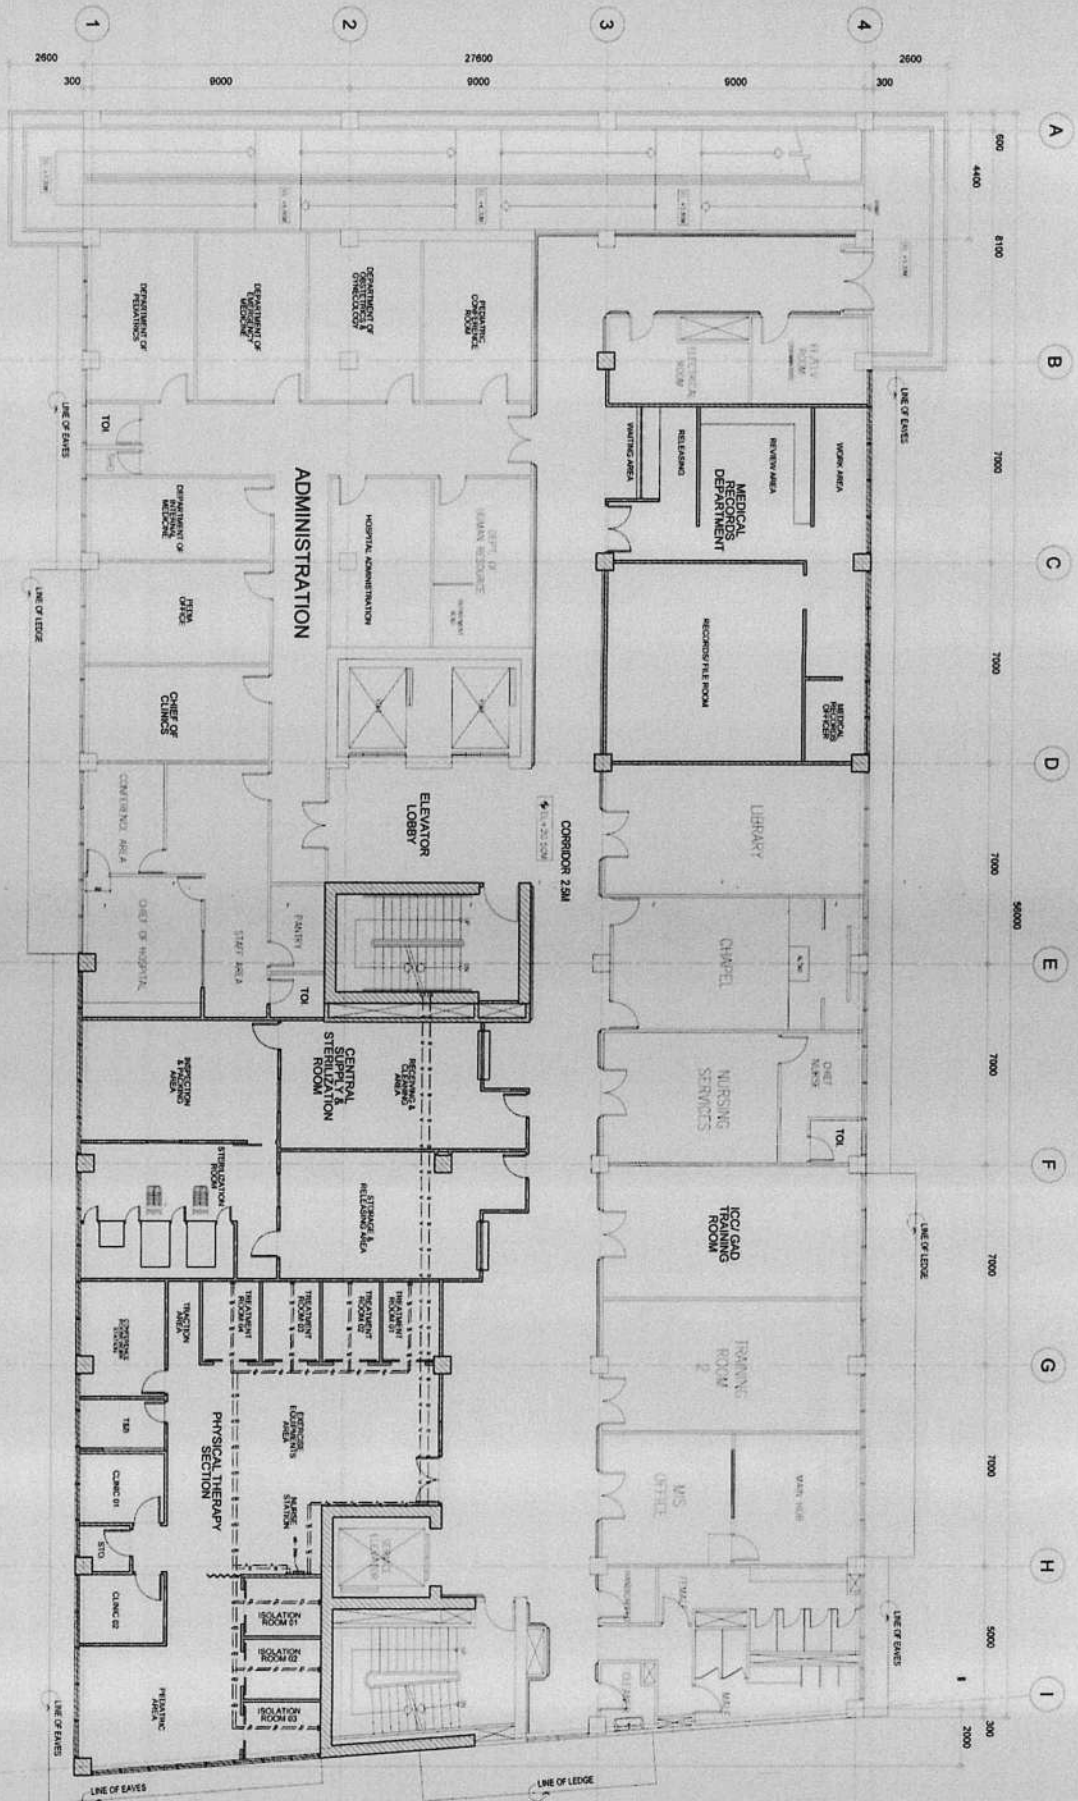


GAS PIPING LAYOUT
 EXISTING LAYOUT
 SIXTH FLOOR PLAN
 1 : 100 MM


 REPUBLIC OF THE PHILIPPINES CITY OF PASIG	PROJECT TITLE PROPOSED EXPANSION W/ IMPROVEMENT WORKS AT PASIG CITY CHILDREN'S HOSPITAL	PROJECT IN CHARGE ENGR. ROLANDO R. ARCEDO, JR.	PROGRAMMING & CONSTRUCTION ENGR. ISABEL V. BARRALES	RECOMMENDING APPROVAL ENGR. ARTAVARDES V. GERONIMO	APPROVED BY VICTOR MA. REGIS M. SOTTO CITY MAYOR	SHEET CONTENTS GAS PIPING LAYOUT EXISTING LAYOUT	SHEET NO. M 07 / 09
IMPORTANT NOTES 1. NO ALTERATION IN DIMENSIONS SHALL BE MADE UNLESS SPECIFICALLY NOTED OTHERWISE. 2. IF ANY CHANGE IN THE CONSTRUCTION WORKS IS REQUIRED, THE CONTRACTOR SHALL BE RESPONSIBLE FOR THE NECESSARY PERMITS AND APPROVALS. 3. IN CASE OF ANY DISCREPANCY IN THE DIMENSIONS, THE CONTRACTOR SHALL BE RESPONSIBLE FOR THE NECESSARY PERMITS AND APPROVALS. 4. THE CONTRACTOR SHALL BE RESPONSIBLE FOR THE PROTECTION OF ALL EXISTING UTILITIES AND STRUCTURES.	LOCATION: INDUSTRIAL CONTROL ZONE, JOSE STS. PROJECT NO.	ENGR. <i>[Signature]</i> SERRIZ PROJECT MANAGER	ENGR. <i>[Signature]</i> SERRIZ CHECKED BY	ENGR. <i>[Signature]</i> SERRIZ CHECKED BY	ENGR. <i>[Signature]</i> SERRIZ CHECKED BY	CONTRACTOR COMFORINE & ACCEPTED BY CONTRACTOR	

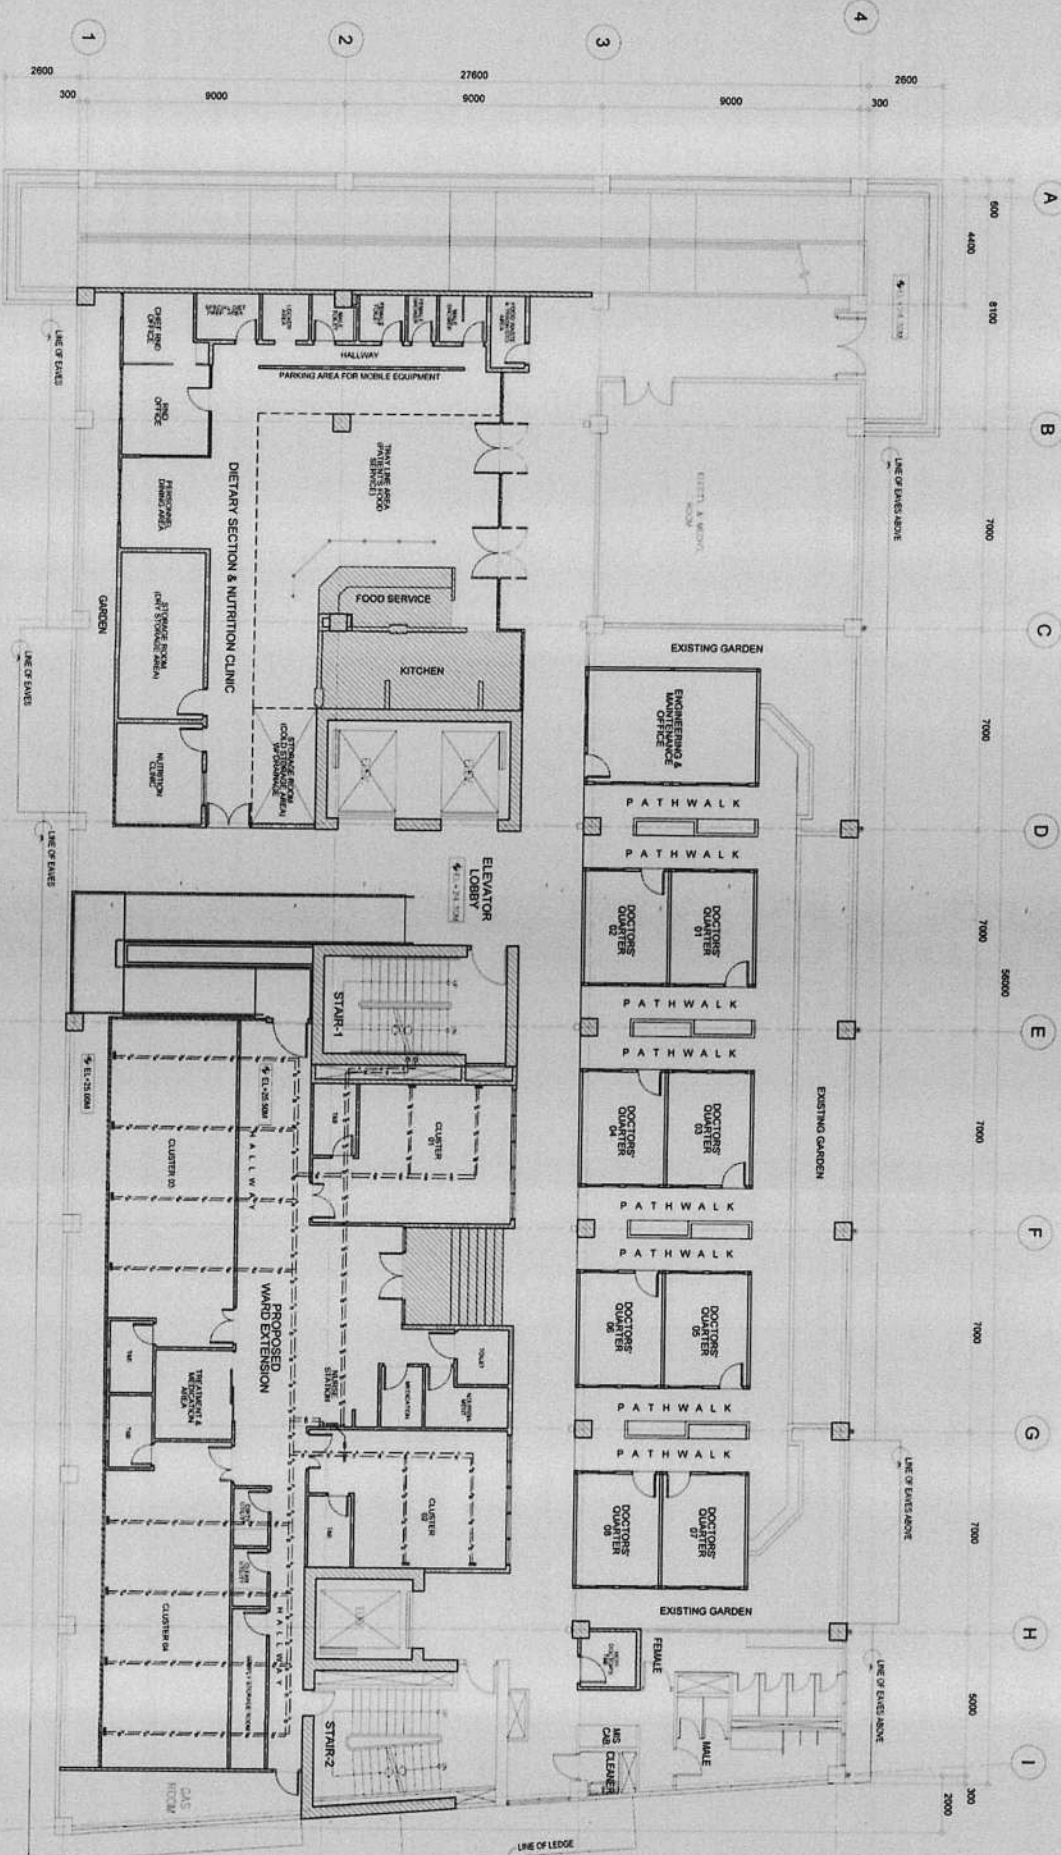


GAS PIPING LAYOUT
EXISTING LOWER ROOF DECK FLOOR PLAN
 01
 M 08
 SCALE
 1 : 100 MM

 REPUBLIC OF THE PHILIPPINES CITY OF PASIG OFFICE OF THE MAYOR ENGINEERING DEPARTMENT	PROJECT TITLE PROPOSED EXPANSION W/ IMPROVEMENT WORKS AT PASIG CITY CHILDREN'S HOSPITAL	PROJECT IN CHARGE: ENGR. RAFAEL R. JACIDO, JR. ENGR. JUAN M. GARCIA, PEREZ	PROGRAMMING & CONSTRUCTION: ENGR. GREGORY R. RAMIREZ	RECOMMENDING APPROVAL: ENGR. PRUDENCIO ENGR. ARTABERRES V. GERONIMO	APPROVED BY: VICTOR MA. REGIS N. SOTTO CITY MAYOR	SHEET CONTENTS: GAS PIPING LAYOUT FOR EXISTING LOWER ROOF DECK FLOOR PLAN	SHEET NO.: <div style="border: 1px solid black; border-radius: 50%; width: 30px; height: 30px; display: flex; align-items: center; justify-content: center; margin: 0 auto;"> M 08/09 </div>
IMPORTANT NOTES: 1. NO ALTERATION TO GAS & PIPING LAYOUT SHALL BE MADE WITHOUT THE WRITTEN PERMISSION OF THE ARCHITECT AND ENGINEER. 2. CONTRACTOR SHALL BE RESPONSIBLE FOR THE PROTECTION OF EXISTING UTILITIES AND STRUCTURES. 3. THE CONTRACTOR SHALL BE RESPONSIBLE FOR THE PROTECTION OF EXISTING UTILITIES AND STRUCTURES. 4. THE CONTRACTOR SHALL BE RESPONSIBLE FOR THE PROTECTION OF EXISTING UTILITIES AND STRUCTURES. 5. THE CONTRACTOR SHALL BE RESPONSIBLE FOR THE PROTECTION OF EXISTING UTILITIES AND STRUCTURES. 6. THE CONTRACTOR SHALL BE RESPONSIBLE FOR THE PROTECTION OF EXISTING UTILITIES AND STRUCTURES.		PROJECT LOCATION: INDUSTRIAL COR. ALVARO JOSE STS. PASIG, PASIG CITY		APPROVED BY: VICTOR MA. REGIS N. SOTTO CITY MAYOR		SHEET NO.: <div style="border: 1px solid black; border-radius: 50%; width: 30px; height: 30px; display: flex; align-items: center; justify-content: center; margin: 0 auto;"> M 08/09 </div>	

CONTRACTOR

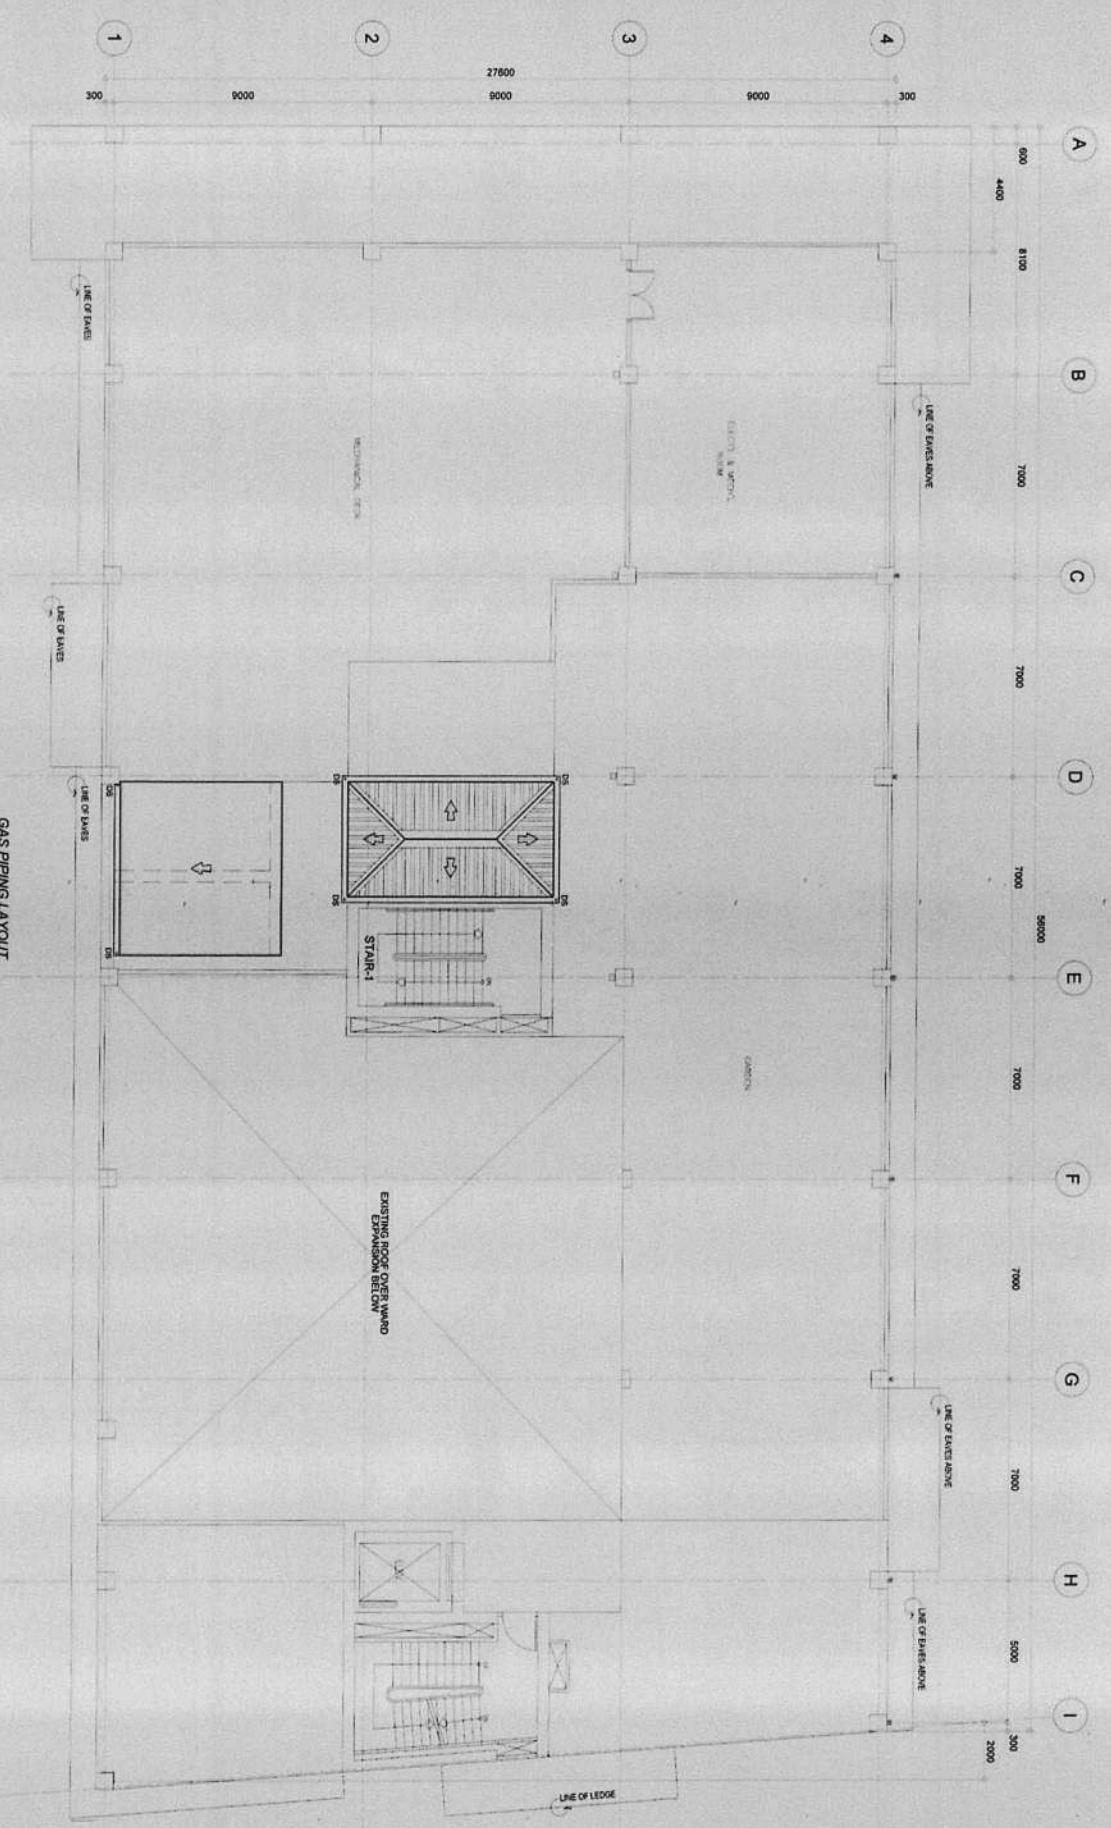


01
 GAS PIPING LAYOUT
 EXISTING UPPER ROOF DECK FLOOR PLAN
 1 : 100 MM

 REPUBLIC OF THE PHILIPPINES CITY OF PASIG OFFICE OF THE MAYOR ENGINEERING DEPARTMENT		PROJECT TITLE PROPOSED EXPANSION W/ IMPROVEMENT WORKS AT PASIG CITY CHILDREN'S HOSPITAL LOCATION: INDUSTRIAL COR. ALACRUE JOSE STS. INDUSTRIAL PARK CITY		PROJECT IN CHARGE: ENGR. ROMEO R. RANCO JR. ENGR. JAMES G. GONZALEZ		PROGRAMMING & CONSTRUCTION: ENGR. ISMAEL V. RAÑESES CHIEF ARCHITECT		RECOMMENDING APPROVAL: ENGR. JAMES E. PRUDENCIO ENGR. ARTAVERNES V. GERONIMO OLC. ENGINEERING CORPORATION		APPROVED BY: VICTOR MA. REGIS N. SOTTO CITY MAYOR		SHEET CONTENTS: GAS PIPING LAYOUT CAD: EC ESTRADA		SHEET NO. M 09 09	
---	--	--	--	--	--	--	--	---	--	--	--	--	--	----------------------------------	--



REPORT NOTE:

1. THIS DRAWING IS A PART OF THE PROPOSED EXPANSION WORKS AT PASIG CITY CHILDREN'S HOSPITAL. THE CONTRACTOR SHALL BE RESPONSIBLE FOR THE PROVISION OF ALL NECESSARY PERMITS AND APPROVALS FROM THE APPROPRIATE AGENCIES.
2. THE CONTRACTOR SHALL BE RESPONSIBLE FOR THE PROVISION OF ALL NECESSARY PERMITS AND APPROVALS FROM THE APPROPRIATE AGENCIES.
3. THE CONTRACTOR SHALL BE RESPONSIBLE FOR THE PROVISION OF ALL NECESSARY PERMITS AND APPROVALS FROM THE APPROPRIATE AGENCIES.
4. THE CONTRACTOR SHALL BE RESPONSIBLE FOR THE PROVISION OF ALL NECESSARY PERMITS AND APPROVALS FROM THE APPROPRIATE AGENCIES.
5. THE CONTRACTOR SHALL BE RESPONSIBLE FOR THE PROVISION OF ALL NECESSARY PERMITS AND APPROVALS FROM THE APPROPRIATE AGENCIES.
6. THE CONTRACTOR SHALL BE RESPONSIBLE FOR THE PROVISION OF ALL NECESSARY PERMITS AND APPROVALS FROM THE APPROPRIATE AGENCIES.

CONTRACTOR

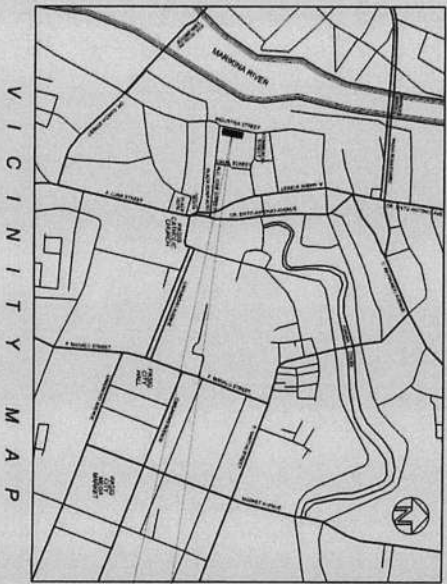

THE SITE

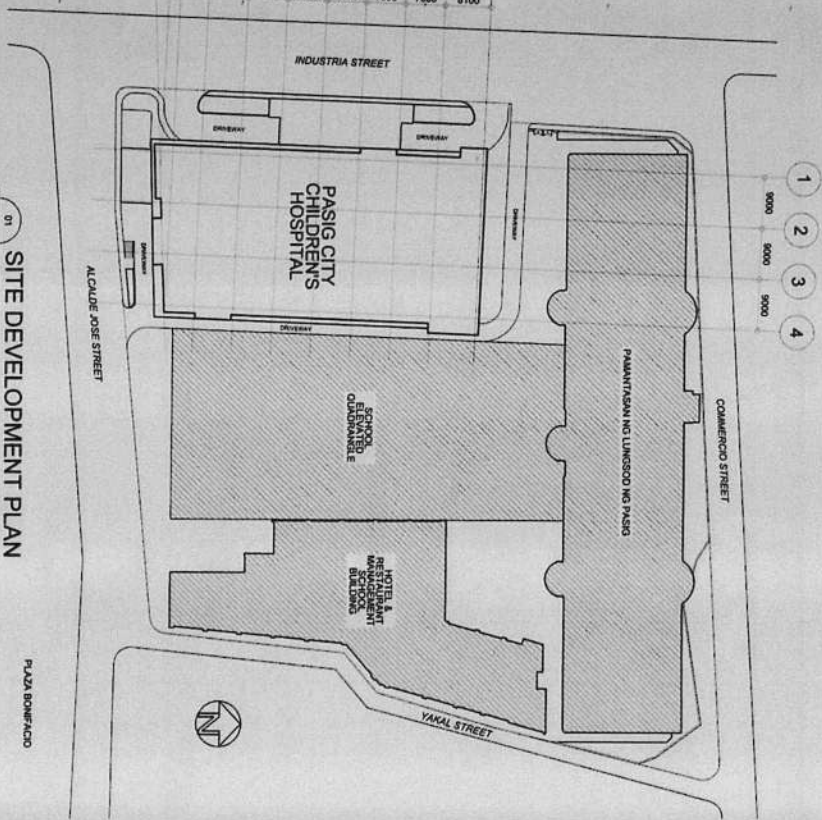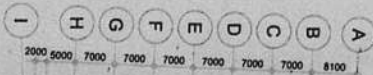

1:2000 SCALE

1:2000 SCALE

PLAZA BONIFACIO



REPUBLIC OF THE PHILIPPINES
CITY OF PASIG
OFFICE OF THE MAYOR
CITY ENGINEERING OFFICE

PROJECT TITLE:
**PROPOSED EXPANSION W/
IMPROVEMENT WORKS AT
PASIG CITY CHILDREN'S HOSPITAL**

PROJECT IN CHARGE:
ENGR. CLAYTON BENEVENT C. SOLONON
ENGR. EDUARDO BARRONDA JR.
ENGR. JOSE CARVAL BELIN

PROGRAMMING AND CONSTRUCTION:
ENGR. JORGE L. TIZON
ENGR. JOSE CARVAL BELIN

RECOMMENDING APPROVAL:
ENGR. ARTAVENDES V. GERONIMO
ENGR. JOSE CARVAL BELIN

APPROVED BY:
VICTOR MA. REGIS N. SOTTO
CITY MAYOR

SHEET CONTENT:
SITE DEVELOPMENT PLAN AND VICINITY MAP

SHEET NO.:
E
0173

CONFORMER & ACCEPTED BY:
CONTRACTOR

IMPORTANT NOTES:

1. NO ALTERATION IN PLAN & SPECIFICATIONS SHALL BE MADE WITHOUT THE WRITTEN APPROVAL OF THE PROJECT ARCHITECT.

2. IN ANY CASE, THE CONTRACTOR SHALL BE RESPONSIBLE FOR THE PROTECTION OF ALL UTILITIES AND STRUCTURES FOUND ON THE SITE.

3. BEFORE ANY CONSTRUCTION, THE CONTRACTOR SHALL BE RESPONSIBLE FOR THE PROTECTION OF ALL UTILITIES AND STRUCTURES FOUND ON THE SITE.

4. THE CONTRACTOR SHALL BE RESPONSIBLE FOR THE PROTECTION OF ALL UTILITIES AND STRUCTURES FOUND ON THE SITE.


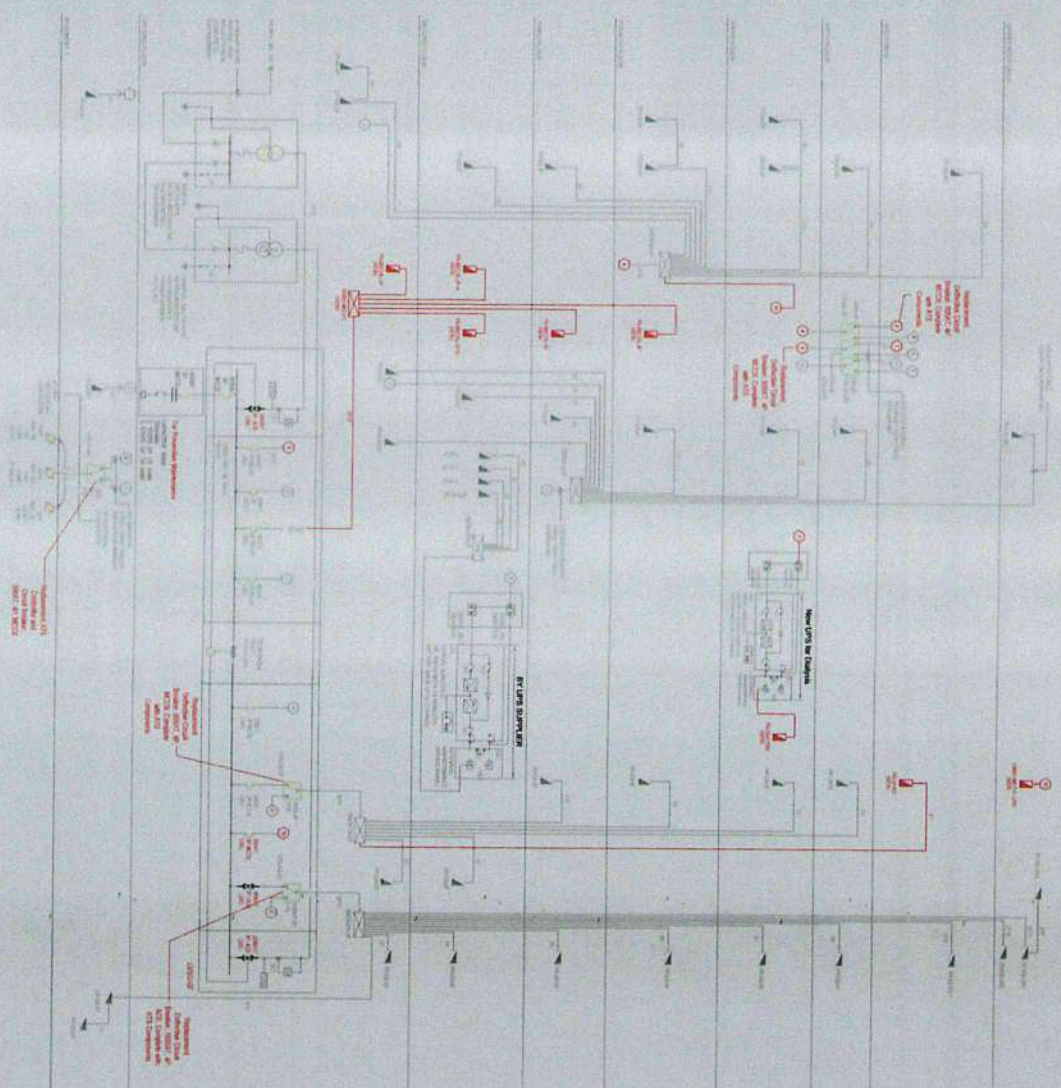


TABLE 1.1: LIGHTING FIXTURE SCHEDULE

NO.	DESCRIPTION	QTY	WATTAGE	VOLTS	AMPERES
1	150W/270V LED LIGHT	10	150	270	0.56
2	150W/270V LED LIGHT	10	150	270	0.56
3	150W/270V LED LIGHT	10	150	270	0.56
4	150W/270V LED LIGHT	10	150	270	0.56
5	150W/270V LED LIGHT	10	150	270	0.56
6	150W/270V LED LIGHT	10	150	270	0.56
7	150W/270V LED LIGHT	10	150	270	0.56
8	150W/270V LED LIGHT	10	150	270	0.56
9	150W/270V LED LIGHT	10	150	270	0.56
10	150W/270V LED LIGHT	10	150	270	0.56
11	150W/270V LED LIGHT	10	150	270	0.56
12	150W/270V LED LIGHT	10	150	270	0.56
13	150W/270V LED LIGHT	10	150	270	0.56
14	150W/270V LED LIGHT	10	150	270	0.56
15	150W/270V LED LIGHT	10	150	270	0.56
16	150W/270V LED LIGHT	10	150	270	0.56
17	150W/270V LED LIGHT	10	150	270	0.56
18	150W/270V LED LIGHT	10	150	270	0.56
19	150W/270V LED LIGHT	10	150	270	0.56
20	150W/270V LED LIGHT	10	150	270	0.56
21	150W/270V LED LIGHT	10	150	270	0.56
22	150W/270V LED LIGHT	10	150	270	0.56
23	150W/270V LED LIGHT	10	150	270	0.56
24	150W/270V LED LIGHT	10	150	270	0.56
25	150W/270V LED LIGHT	10	150	270	0.56
26	150W/270V LED LIGHT	10	150	270	0.56
27	150W/270V LED LIGHT	10	150	270	0.56
28	150W/270V LED LIGHT	10	150	270	0.56
29	150W/270V LED LIGHT	10	150	270	0.56
30	150W/270V LED LIGHT	10	150	270	0.56
31	150W/270V LED LIGHT	10	150	270	0.56
32	150W/270V LED LIGHT	10	150	270	0.56
33	150W/270V LED LIGHT	10	150	270	0.56
34	150W/270V LED LIGHT	10	150	270	0.56
35	150W/270V LED LIGHT	10	150	270	0.56
36	150W/270V LED LIGHT	10	150	270	0.56
37	150W/270V LED LIGHT	10	150	270	0.56
38	150W/270V LED LIGHT	10	150	270	0.56
39	150W/270V LED LIGHT	10	150	270	0.56
40	150W/270V LED LIGHT	10	150	270	0.56
41	150W/270V LED LIGHT	10	150	270	0.56
42	150W/270V LED LIGHT	10	150	270	0.56
43	150W/270V LED LIGHT	10	150	270	0.56
44	150W/270V LED LIGHT	10	150	270	0.56
45	150W/270V LED LIGHT	10	150	270	0.56
46	150W/270V LED LIGHT	10	150	270	0.56
47	150W/270V LED LIGHT	10	150	270	0.56
48	150W/270V LED LIGHT	10	150	270	0.56
49	150W/270V LED LIGHT	10	150	270	0.56
50	150W/270V LED LIGHT	10	150	270	0.56

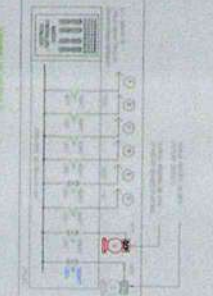

- REVISIONS:**
1. REVISIONS TO BE MADE BY THE ENGINEER.
 2. REVISIONS TO BE MADE BY THE ENGINEER.
 3. REVISIONS TO BE MADE BY THE ENGINEER.
 4. REVISIONS TO BE MADE BY THE ENGINEER.
 5. REVISIONS TO BE MADE BY THE ENGINEER.
 6. REVISIONS TO BE MADE BY THE ENGINEER.
 7. REVISIONS TO BE MADE BY THE ENGINEER.
 8. REVISIONS TO BE MADE BY THE ENGINEER.
 9. REVISIONS TO BE MADE BY THE ENGINEER.
 10. REVISIONS TO BE MADE BY THE ENGINEER.

NOTES:

1. ALL WORK SHALL BE DONE IN ACCORDANCE WITH THE NATIONAL ELECTRICAL CODE (NEC) AND THE NATIONAL WIRE AND CABLE CODE (NWC).
2. ALL WORK SHALL BE DONE IN ACCORDANCE WITH THE NATIONAL ELECTRICAL CODE (NEC) AND THE NATIONAL WIRE AND CABLE CODE (NWC).
3. ALL WORK SHALL BE DONE IN ACCORDANCE WITH THE NATIONAL ELECTRICAL CODE (NEC) AND THE NATIONAL WIRE AND CABLE CODE (NWC).
4. ALL WORK SHALL BE DONE IN ACCORDANCE WITH THE NATIONAL ELECTRICAL CODE (NEC) AND THE NATIONAL WIRE AND CABLE CODE (NWC).
5. ALL WORK SHALL BE DONE IN ACCORDANCE WITH THE NATIONAL ELECTRICAL CODE (NEC) AND THE NATIONAL WIRE AND CABLE CODE (NWC).
6. ALL WORK SHALL BE DONE IN ACCORDANCE WITH THE NATIONAL ELECTRICAL CODE (NEC) AND THE NATIONAL WIRE AND CABLE CODE (NWC).
7. ALL WORK SHALL BE DONE IN ACCORDANCE WITH THE NATIONAL ELECTRICAL CODE (NEC) AND THE NATIONAL WIRE AND CABLE CODE (NWC).
8. ALL WORK SHALL BE DONE IN ACCORDANCE WITH THE NATIONAL ELECTRICAL CODE (NEC) AND THE NATIONAL WIRE AND CABLE CODE (NWC).
9. ALL WORK SHALL BE DONE IN ACCORDANCE WITH THE NATIONAL ELECTRICAL CODE (NEC) AND THE NATIONAL WIRE AND CABLE CODE (NWC).
10. ALL WORK SHALL BE DONE IN ACCORDANCE WITH THE NATIONAL ELECTRICAL CODE (NEC) AND THE NATIONAL WIRE AND CABLE CODE (NWC).

LEGEND:



- 1. 150W/270V LED LIGHT
- 2. 270V/150W LED LIGHT
- 3. 150W/270V LED LIGHT
- 4. 270V/150W LED LIGHT
- 5. 150W/270V LED LIGHT
- 6. 270V/150W LED LIGHT
- 7. 150W/270V LED LIGHT
- 8. 270V/150W LED LIGHT
- 9. 150W/270V LED LIGHT
- 10. 270V/150W LED LIGHT

REPUBLIC OF THE PHILIPPINES OFFICE OF THE MAYOR CITY ENGINEERING OFFICE	PROJECT TITLE: PROPOSED EXPANSION W/ 150W/270V LED LIGHTS IN PASIG CITY CHILDREN'S HOSPITAL	PROJECT IN CHARGE: ENGR. CAROLINA S. SOLONON ENGR. EDUARDO G. BAHILUA JR. ENGR. DANIELA BELIN	PRODUKING AND CONSTRUCTION: ENGR. ANGELO TIZON OIC, ELECTRICAL DIVISION	RECOMMENDING APPROVAL: ENGR. JAMES S. PRUDENCIO ENGR. ARTAVERDES V. GERONIMO OIC, CITY ENGINEERING OFFICE	APPROVED BY: VICTOR MA. REGIS N. SOTTO CITY MAYOR	SHEET CONTENT: SINGLE LINE DIAGRAM	SHEET NO.: E-0273
---	---	--	---	--	--	---------------------------------------	-----------------------------

IMPORTANT NOTES:

1. FOR ALL THE WORKS TO BE DONE, THE CONTRACTOR SHALL BE RESPONSIBLE FOR THE PROVISION OF ALL NECESSARY MATERIALS AND LABOR.
2. IN CASE OF ANY DISCREPANCY IN THE DRAWINGS, THE CONTRACTOR SHALL BE RESPONSIBLE FOR THE CORRECTION OF THE SAME.
3. IN CASE OF ANY DISCREPANCY IN THE DRAWINGS, THE CONTRACTOR SHALL BE RESPONSIBLE FOR THE CORRECTION OF THE SAME.
4. THE CONTRACTOR SHALL BE RESPONSIBLE FOR THE PROVISION OF ALL NECESSARY MATERIALS AND LABOR.
5. THE CONTRACTOR SHALL BE RESPONSIBLE FOR THE PROVISION OF ALL NECESSARY MATERIALS AND LABOR.
6. THE CONTRACTOR SHALL BE RESPONSIBLE FOR THE PROVISION OF ALL NECESSARY MATERIALS AND LABOR.

CONTRACTOR

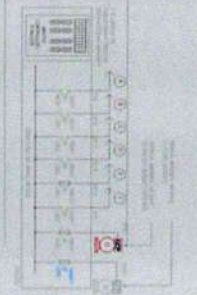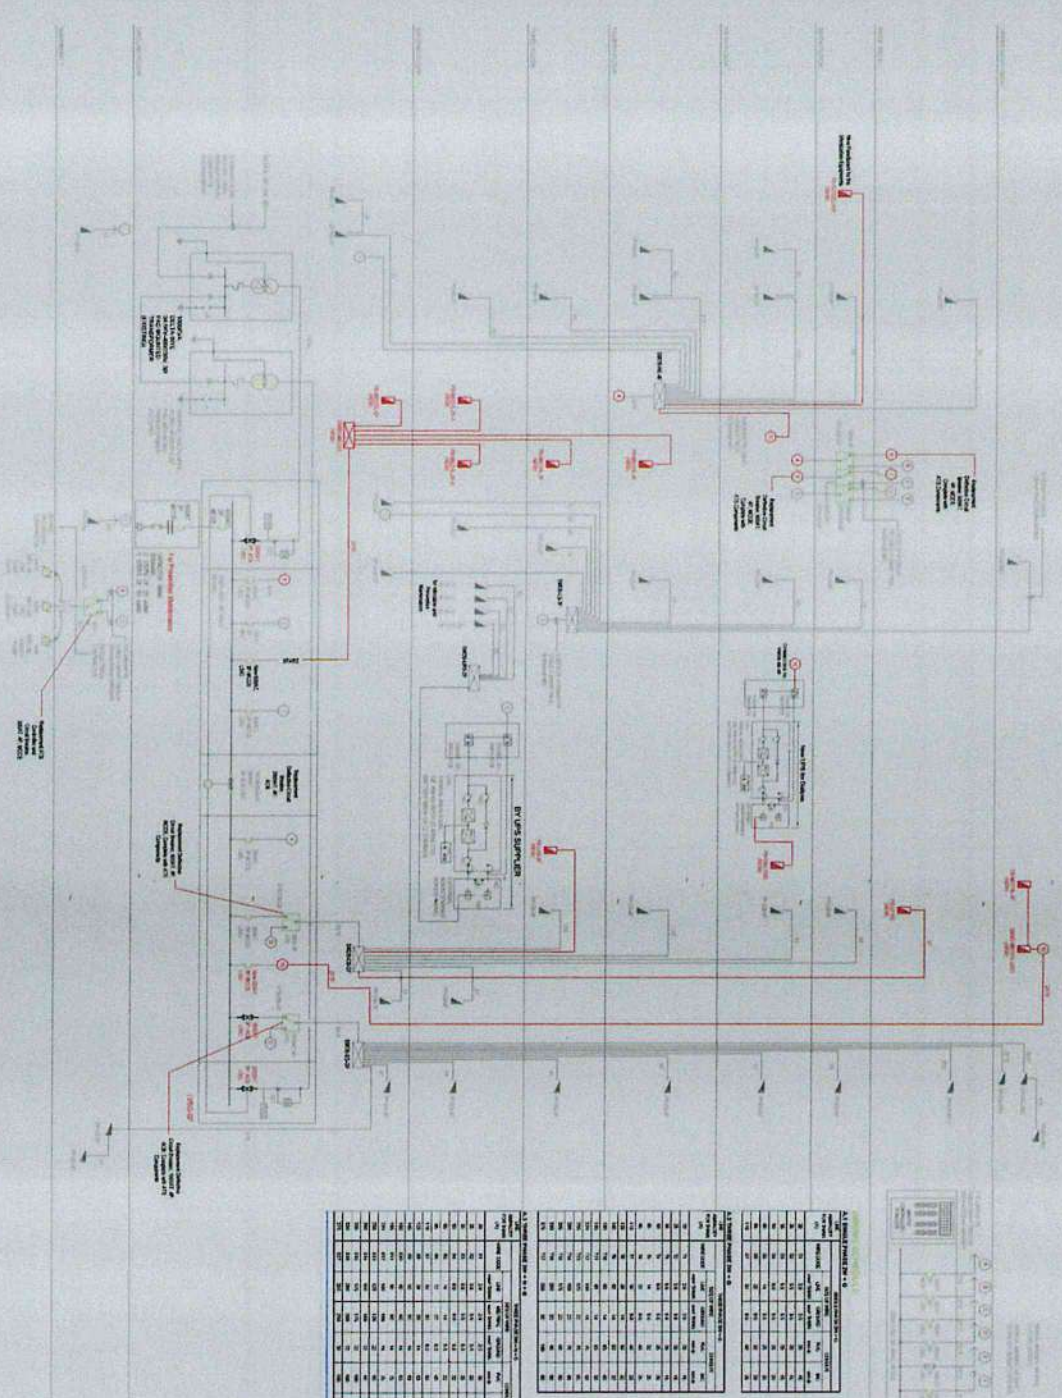

ALL PANELS LISTED ON THIS SHEET	
PANEL NO.	DESCRIPTION
1	BYPASS SUPPLY
2	PANEL 2
3	PANEL 3
4	PANEL 4
100	PANEL 100



REPUBLIC OF THE PHILIPPINES
 CITY OF PASIG
 OFFICE OF THE MAJOR
 CITY ENGINEERING OFFICE

PROJECT TITLE: PROPOSED EXPANSION W/ IMPROVEMENT WORKS AT PASIG CITY CHILDREN'S HOSPITAL
LOCATION: INDUSTRIAL COR ALCALDE JOSE STS. PASIG, PASIG CITY

PROJECT IN CHARGE: ENGR. CHRISTOPHER SUBJECT C. SOLONON
PROGRAMMING AND CONSTRUCTION: ENGR. CARL BELIN
RECOMMENDING APPROVAL: ENGR. JORGE L. TOZON
APPROVED BY: VICTOR MAE REGIS N. SOTTO
 CITY ENGINEERING OFFICE

IMPORTANT NOTES:
 1. THE CONTRACTOR SHALL BE RESPONSIBLE FOR THE PROTECTION OF ALL EXISTING UTILITIES AND STRUCTURES.
 2. THE CONTRACTOR SHALL BE RESPONSIBLE FOR THE PROTECTION OF ALL EXISTING UTILITIES AND STRUCTURES.
 3. THE CONTRACTOR SHALL BE RESPONSIBLE FOR THE PROTECTION OF ALL EXISTING UTILITIES AND STRUCTURES.
 4. THE CONTRACTOR SHALL BE RESPONSIBLE FOR THE PROTECTION OF ALL EXISTING UTILITIES AND STRUCTURES.
 5. THE CONTRACTOR SHALL BE RESPONSIBLE FOR THE PROTECTION OF ALL EXISTING UTILITIES AND STRUCTURES.
 6. THE CONTRACTOR SHALL BE RESPONSIBLE FOR THE PROTECTION OF ALL EXISTING UTILITIES AND STRUCTURES.

SHEET CONTENT: SINGLE LINE DIAGRAM
SHEET NO.: E-0373
CONFORME & ACCEPTED BY: CONTRACTOR



REPUBLIC OF THE PHILIPPINES
OFFICE OF THE MAYOR
CITY OF PASIG

CITY ENGINEERING OFFICE

PROJECT TITLE:
**PROPOSED EXPANSION W/
IMPROVEMENT WORKS AT
PASIG CITY CHILDREN'S HOSPITAL**

LOCATION: INDUSTRIAL COR. ALCAZAR JOSE STRS.
INDUSTRIAL COR. PASIG, NLEX 2

PROJECT IN CHARGE:
ENGR. CHRISTIAN P. SOLORSON
ENGR. ENRIQUE BARRONCA JR.
ENGR. JOHN JASMINA I. CORTES

PROGRAMMING AND CONSTRUCTION:
ENGR. JORGE L. TIZON

RECOMMENDING APPROVAL:
ENGR. JOSE B. PRUDENCIO

APPROVED BY:
ENGR. ARTAVERXIS V. GERONIMO

VICTOR MA. REGIS N. SOTTO
CITY MAYOR

SCHEDULE OF LOADS
CONFORME & ACCEPTED BY:



IMPORTANT NOTES

- NO CONTRACTOR SHALL BE RESPONSIBLE FOR THE DESIGN OF THE ELECTRICAL SYSTEMS AND EQUIPMENT.
- THE CONTRACTOR SHALL BE RESPONSIBLE FOR THE PROTECTION OF THE EXISTING UTILITIES AND STRUCTURES.
- THE CONTRACTOR SHALL BE RESPONSIBLE FOR THE OBTAINMENT OF ALL NECESSARY PERMITS AND APPROVALS FROM THE RELEVANT AGENCIES.
- THE CONTRACTOR SHALL BE RESPONSIBLE FOR THE SAFETY OF ALL PERSONNEL AND THE PUBLIC DURING THE CONSTRUCTION.
- THE CONTRACTOR SHALL BE RESPONSIBLE FOR THE PROTECTION OF THE ENVIRONMENT AND THE NEIGHBORHOOD.
- THE CONTRACTOR SHALL BE RESPONSIBLE FOR THE PROTECTION OF THE PROJECT.

CCT NO.	LOAD DESCRIPTION	CONNECTED LOAD			MOUNTING ENCLOSEURE			SURFACE ENCLOSURE			CONDUCTORS			RACEWAY		
		VA	D.F.	SP	AMPERE	600V	480V	240V	TYPE	TYPE	TYPE	TYPE	TYPE	TYPE	TYPE	TYPE
1	LIGHTNING	1.00	1.00	3P	4.38			20	20	20	20	20	20	20	20	20
2	LIGHTNING	1.00	1.00	3P	4.38			20	20	20	20	20	20	20	20	20
3	LIGHTNING	1.00	1.00	3P	4.38			20	20	20	20	20	20	20	20	20
4	SPARE															
5	SPARE															
6	SPARE															
7	SPARE															
8	SPARE															
9	SPARE															
10	SPARE															
11	SPARE															
12	SPARE															
13	SPARE															
14	SPARE															
15	SPARE															
16	SPARE															
17	SPARE															
18	SPARE															
19	SPARE															
20	SPARE															
21	SPARE															
22	SPARE															
23	SPARE															
24	SPARE															
DEMAND FACTOR:		0.88														
DEMAND W.:		8.828														
MANAGE FEEDER:		30.88														
MANAGE CODE:		10.294														
TYPE:		60AF														
TYPE:		3P														
RACEWAY:		30V														

CCT NO.	LOAD DESCRIPTION	CONNECTED LOAD			MOUNTING ENCLOSEURE			SURFACE ENCLOSURE			CONDUCTORS			RACEWAY		
		VA	D.F.	SP	AMPERE	600V	480V	240V	TYPE	TYPE	TYPE	TYPE	TYPE	TYPE	TYPE	
1	LIGHTNING	1.00	1.00	3P	4.38			20	20	20	20	20	20	20	20	
2	LIGHTNING	1.00	1.00	3P	4.38			20	20	20	20	20	20	20	20	
3	LIGHTNING	1.00	1.00	3P	4.38			20	20	20	20	20	20	20	20	
4	SPARE															
5	SPARE															
6	SPARE															
7	SPARE															
8	SPARE															
9	SPARE															
10	SPARE															
11	SPARE															
12	SPARE															
13	SPARE															
14	SPARE															
15	SPARE															
16	SPARE															
17	SPARE															
18	SPARE															
19	SPARE															
20	SPARE															
21	SPARE															
22	SPARE															
23	SPARE															
24	SPARE															
DEMAND FACTOR:		0.88														
DEMAND W.:		8.828														
MANAGE FEEDER:		30.88														
MANAGE CODE:		10.294														
TYPE:		60AF														
TYPE:		3P														
RACEWAY:		30V														

CCT NO.	LOAD DESCRIPTION	CONNECTED LOAD			MOUNTING ENCLOSEURE			SURFACE ENCLOSURE			CONDUCTORS			RACEWAY		
		VA	D.F.	SP	AMPERE	600V	480V	240V	TYPE	TYPE	TYPE	TYPE	TYPE	TYPE	TYPE	
1	LIGHTNING	1.00	1.00	3P	4.38			20	20	20	20	20	20	20	20	
2	LIGHTNING	1.00	1.00	3P	4.38			20	20	20	20	20	20	20	20	
3	LIGHTNING	1.00	1.00	3P	4.38			20	20	20	20	20	20	20	20	
4	SPARE															
5	SPARE															
6	SPARE															
7	SPARE															
8	SPARE															
9	SPARE															
10	SPARE															
11	SPARE															
12	SPARE															
13	SPARE															
14	SPARE															
15	SPARE															
DEMAND FACTOR:		0.88														
DEMAND W.:		8.828														
MANAGE FEEDER:		30.88														
MANAGE CODE:		10.294														
TYPE:		60AF														
TYPE:		3P														
RACEWAY:		30V														

CCT NO.	LOAD DESCRIPTION	CONNECTED LOAD			MOUNTING ENCLOSEURE			SURFACE ENCLOSURE			CONDUCTORS			RACEWAY		
		VA	D.F.	SP	AMPERE	600V	480V	240V	TYPE	TYPE	TYPE	TYPE	TYPE	TYPE	TYPE	
1	LIGHTNING	1.00	1.00	3P	4.38			20	20	20	20	20	20	20	20	
2	LIGHTNING	1.00	1.00	3P	4.38			20	20	20	20	20	20	20	20	
3	LIGHTNING	1.00	1.00	3P	4.38			20	20	20	20	20	20	20	20	
4	SPARE															
5	SPARE															
6	SPARE															
7	SPARE															
8	SPARE															
9	SPARE															
10	SPARE															
11	SPARE															
12	SPARE															
13	SPARE															
14	SPARE															
15	SPARE															
DEMAND FACTOR:		0.88														
DEMAND W.:		8.828														
MANAGE FEEDER:		30.88														
MANAGE CODE:		10.294														
TYPE:		60AF														



REPUBLIC OF THE PHILIPPINES
CITY OF PASIG

OFFICE OF THE MAYOR

CITY ENGINEERING OFFICE

PROJECT TITLE

**PROPOSED EXPANSION W/
IMPROVEMENT WORKS AT
PASIG CITY CHILDREN'S HOSPITAL**

PROJECT IN CHARGE

ENGR. CHRISTOPHER C. SOLORION
ENGR. EDUARDO BARRERA R.
ENGR. JOSEPH M. TORRES

PROGRAMMING AND CONSTRUCTION

ENGR. JOSE L. TIZON
ENGR. FRANCISCO PRUDENCIO

RECOMMENDING APPROVAL

ENGR. ARTAVERTES V. GERONIMO
OC: CITY ENGINEERING OFFICE

APPROVED BY

VICTOR M. REGIS N. SOTTO
CITY MAYOR

SHEET CONTENT

SCHEDULE OF LOADS

SHEET NO.

E
0773

IMPORTANT NOTES:

1. NO ALTERATION TO ANY PART OF THE DESIGN SHALL BE MADE WITHOUT THE WRITTEN APPROVAL OF THE REGISTERED PROFESSIONAL ENGINEER IN CHARGE.

2. IN ANY CASE, THE CONTRACTOR SHALL BE RESPONSIBLE FOR THE PROTECTION AND MAINTENANCE OF ALL UTILITIES AND STRUCTURES IN THE VICINITY OF THE PROJECT.

3. NOISE AND VIBRATION MEASUREMENTS SHALL BE CONDUCTED AT THE PROPOSED LOCATION TO DETERMINE THE LEVEL OF EXISTING NOISE AND VIBRATION. THE RESULTS OF THESE MEASUREMENTS SHALL BE USED TO DESIGN THE PROPOSED STRUCTURE TO MEET THE APPLICABLE STANDARDS.


4. THE CONTRACTOR SHALL BE RESPONSIBLE FOR OBTAINING ALL NECESSARY PERMITS AND APPROVALS FROM THE APPROPRIATE AGENCIES AND AGENCIES.

5. THE CONTRACTOR SHALL BE RESPONSIBLE FOR OBTAINING ALL NECESSARY PERMITS AND APPROVALS FROM THE APPROPRIATE AGENCIES AND AGENCIES.

CCT	LOAD DESCRIPTION	VA		D.F.		CONNECTED LOAD		MOUNTING ENCLASURE	SURFACE ENCLOSURE	SMO-BE-GF	OVERSIGHT		CONDUCTIONS		RACEWAY		
		VA	D.F.	3P	4P	4W	4W				4W	4W	4W	4W	4W	4W	
1	EXHAUST FAN (TYPICAL)	4.12	0.80	3.28	0.80	3.28	0.80	60W	NEMA-1	SMO-BE-GF	20	60	1	12	THMM	12	MC
2	EXHAUST FAN (TYPICAL)	4.12	0.80	3.28	0.80	3.28	0.80	60W	NEMA-1	SMO-BE-GF	20	60	1	12	THMM	12	MC
3	EXHAUST FAN (TYPICAL)	4.12	0.80	3.28	0.80	3.28	0.80	60W	NEMA-1	SMO-BE-GF	20	60	1	12	THMM	12	MC
4	EXHAUST FAN (TYPICAL)	4.12	0.80	3.28	0.80	3.28	0.80	60W	NEMA-1	SMO-BE-GF	20	60	1	12	THMM	12	MC
5	EXHAUST FAN (TYPICAL)	4.12	0.80	3.28	0.80	3.28	0.80	60W	NEMA-1	SMO-BE-GF	20	60	1	12	THMM	12	MC
6	EXHAUST FAN (TYPICAL)	4.12	0.80	3.28	0.80	3.28	0.80	60W	NEMA-1	SMO-BE-GF	20	60	1	12	THMM	12	MC
7	SPARE (WARRANTY AREA) (TYPICAL)																
8	SPARE (FEED RAMP) (TYPICAL)																
9	BASEMENT (TYPICAL) (TYPICAL)																
10	BASEMENT (TYPICAL) (TYPICAL)																
11	BASEMENT (TYPICAL) (TYPICAL)																
12	EXHAUST FAN (TYPICAL)																
13	EXHAUST FAN (TYPICAL)																
14	EXHAUST FAN (TYPICAL)																
15	EXHAUST FAN (TYPICAL)																
16	EXHAUST FAN (TYPICAL)																
17	EXHAUST FAN (TYPICAL)																
18	EXHAUST FAN (TYPICAL)																
19	EXHAUST FAN (TYPICAL)																
20	EXHAUST FAN (TYPICAL)																
TOTAL		42.713	0.80	34.06	0.80	34.06	0.80	7.16	1.70		20	60	1	12	THMM	12	MC
DEMAND FACTOR	0.80																
DEMAND AM	34.170																
DEMAND AV	13.275																

CCT	LOAD DESCRIPTION	VA		D.F.		CONNECTED LOAD		MOUNTING ENCLASURE	SURFACE ENCLOSURE	SMO-BE-GF	OVERSIGHT		CONDUCTIONS		RACEWAY		
		VA	D.F.	3P	4P	4W	4W				4W	4W	4W	4W	4W		
1	EXHAUST FAN (TYPICAL)	4.12	0.80	3.28	0.80	3.28	0.80	60W	NEMA-1	SMO-BE-GF	20	60	1	12	THMM	12	MC
2	EXHAUST FAN (TYPICAL)	4.12	0.80	3.28	0.80	3.28	0.80	60W	NEMA-1	SMO-BE-GF	20	60	1	12	THMM	12	MC
3	EXHAUST FAN (TYPICAL)	4.12	0.80	3.28	0.80	3.28	0.80	60W	NEMA-1	SMO-BE-GF	20	60	1	12	THMM	12	MC
4	EXHAUST FAN (TYPICAL)	4.12	0.80	3.28	0.80	3.28	0.80	60W	NEMA-1	SMO-BE-GF	20	60	1	12	THMM	12	MC
5	EXHAUST FAN (TYPICAL)	4.12	0.80	3.28	0.80	3.28	0.80	60W	NEMA-1	SMO-BE-GF	20	60	1	12	THMM	12	MC
6	EXHAUST FAN (TYPICAL)	4.12	0.80	3.28	0.80	3.28	0.80	60W	NEMA-1	SMO-BE-GF	20	60	1	12	THMM	12	MC
7	EXHAUST FAN (TYPICAL)	4.12	0.80	3.28	0.80	3.28	0.80	60W	NEMA-1	SMO-BE-GF	20	60	1	12	THMM	12	MC
8	EXHAUST FAN (TYPICAL)	4.12	0.80	3.28	0.80	3.28	0.80	60W	NEMA-1	SMO-BE-GF	20	60	1	12	THMM	12	MC
9	EXHAUST FAN (TYPICAL)	4.12	0.80	3.28	0.80	3.28	0.80	60W	NEMA-1	SMO-BE-GF	20	60	1	12	THMM	12	MC
10	EXHAUST FAN (TYPICAL)	4.12	0.80	3.28	0.80	3.28	0.80	60W	NEMA-1	SMO-BE-GF	20	60	1	12	THMM	12	MC
11	EXHAUST FAN (TYPICAL)	4.12	0.80	3.28	0.80	3.28	0.80	60W	NEMA-1	SMO-BE-GF	20	60	1	12	THMM	12	MC
12	EXHAUST FAN (TYPICAL)	4.12	0.80	3.28	0.80	3.28	0.80	60W	NEMA-1	SMO-BE-GF	20	60	1	12	THMM	12	MC
13	EXHAUST FAN (TYPICAL)	4.12	0.80	3.28	0.80	3.28	0.80	60W	NEMA-1	SMO-BE-GF	20	60	1	12	THMM	12	MC
14	EXHAUST FAN (TYPICAL)	4.12	0.80	3.28	0.80	3.28	0.80	60W	NEMA-1	SMO-BE-GF	20	60	1	12	THMM	12	MC
15	EXHAUST FAN (TYPICAL)	4.12	0.80	3.28	0.80	3.28	0.80	60W	NEMA-1	SMO-BE-GF	20	60	1	12	THMM	12	MC
16	EXHAUST FAN (TYPICAL)	4.12	0.80	3.28	0.80	3.28	0.80	60W	NEMA-1	SMO-BE-GF	20	60	1	12	THMM	12	MC
17	EXHAUST FAN (TYPICAL)	4.12	0.80	3.28	0.80	3.28	0.80	60W	NEMA-1	SMO-BE-GF	20	60	1	12	THMM	12	MC
18	EXHAUST FAN (TYPICAL)	4.12	0.80	3.28	0.80	3.28	0.80	60W	NEMA-1	SMO-BE-GF	20	60	1	12	THMM	12	MC
19	EXHAUST FAN (TYPICAL)	4.12	0.80	3.28	0.80	3.28	0.80	60W	NEMA-1	SMO-BE-GF	20	60	1	12	THMM	12	MC
20	EXHAUST FAN (TYPICAL)	4.12	0.80	3.28	0.80	3.28	0.80	60W	NEMA-1	SMO-BE-GF	20	60	1	12	THMM	12	MC
TOTAL		82.426	0.80	64.12	0.80	64.12	0.80	14.32	3.40		20	60	1	12	THMM	12	MC
DEMAND FACTOR	0.80																
DEMAND AM	64.12																
DEMAND AV	25.648																

CCT	LOAD DESCRIPTION	VA		D.F.		CONNECTED LOAD		MOUNTING ENCLASURE	SURFACE ENCLOSURE	SMO-BE-GF	OVERSIGHT		CONDUCTIONS		RACEWAY		
		VA	D.F.	3P	4P	4W	4W				4W	4W	4W	4W			
1	EXHAUST FAN (TYPICAL)	4.12	0.80	3.28	0.80	3.28	0.80	60W	NEMA-1	SMO-BE-GF	20	60	1	12	THMM	12	MC
2	EXHAUST FAN (TYPICAL)	4.12	0.80	3.28	0.80	3.28	0.80	60W	NEMA-1	SMO-BE-GF	20	60	1	12	THMM	12	MC
3	EXHAUST FAN (TYPICAL)	4.12	0.80	3.28	0.80	3.28	0.80	60W	NEMA-1	SMO-BE-GF	20	60	1	12	THMM	12	MC
4	EXHAUST FAN (TYPICAL)	4.12	0.80	3.28	0.80	3.28	0.80	60W	NEMA-1	SMO-BE-GF	20	60	1	12	THMM	12	MC
5	EXHAUST FAN (TYPICAL)	4.12	0.80	3.28	0.80	3.28	0.80	60W	NEMA-1	SMO-BE-GF	20	60	1	12	THMM	12	MC
6	EXHAUST FAN (TYPICAL)	4.12	0.80	3.28	0.80	3.28	0.80	60W	NEMA-1	SMO-BE-GF	20	60	1	12	THMM	12	MC
7	EXHAUST FAN (TYPICAL)	4.12	0.80	3.28	0.80	3.28	0.80	60W	NEMA-1	SMO-BE-GF	20	60	1	12	THMM	12	MC
8	EXHAUST FAN (TYPICAL)	4.12	0.80	3.28	0.80	3.28	0.80	60W	NEMA-1	SMO-BE-GF	20	60	1	12	THMM	12	MC
9	EXHAUST FAN (TYPICAL)	4.12	0.80	3.28	0.80	3.28	0.80	60W	NEMA-1	SMO-BE-GF	20	60	1	12	THMM	12	MC
10	EXHAUST FAN (TYPICAL)	4.12	0.80	3.28	0.80	3.28	0.80	60W	NEMA-1	SMO-BE-GF	20	60	1	12	THMM	12	MC
11	EXHAUST FAN (TYPICAL)	4.12	0.80	3.28	0.80	3.28	0.80	60W	NEMA-1	SMO-BE-GF	20	60	1	12	THMM	12	MC
12	EXHAUST FAN (TYPICAL)	4.12	0.80	3.28	0.80	3.28	0.80	60W	NEMA-1	SMO-BE-GF	20	60	1	12	THMM	12	MC
13	EXHAUST FAN (TYPICAL)	4.12	0.80	3.28	0.80	3.28	0.80	60W	NEMA-1	SMO-BE-GF	20	60	1	12	THMM	12	MC
14	EXHAUST FAN (TYPICAL)	4.12	0.80	3.28	0.80	3.28	0.80	60W	NEMA-1	SMO-BE-GF	20	60	1	12	THMM	12	MC
15	EXHAUST FAN (TYPICAL)	4.12	0.80	3.28	0.80	3.28	0.80	60W	NEMA-1	SMO-BE-GF	20	60	1	12	THMM	12	MC
16	EXHAUST FAN (TYPICAL)	4.12	0.80	3.28	0.80	3.28	0.80	60W	NEMA-1	SMO-BE-GF	20	60	1	12	THMM	12	MC
17	EXHAUST FAN (TYPICAL)	4.12	0.80	3.28	0.80	3.28	0.80	60W	NEMA-1	SMO-BE-GF	20	60	1	12	THMM	12	MC
18	EXHAUST FAN (TYPICAL)	4.12	0.80	3.28	0.80	3.28	0.80	60W	NEMA-1	SMO-BE-GF	20	60	1	12	THMM	12	MC
19	EXHAUST FAN (

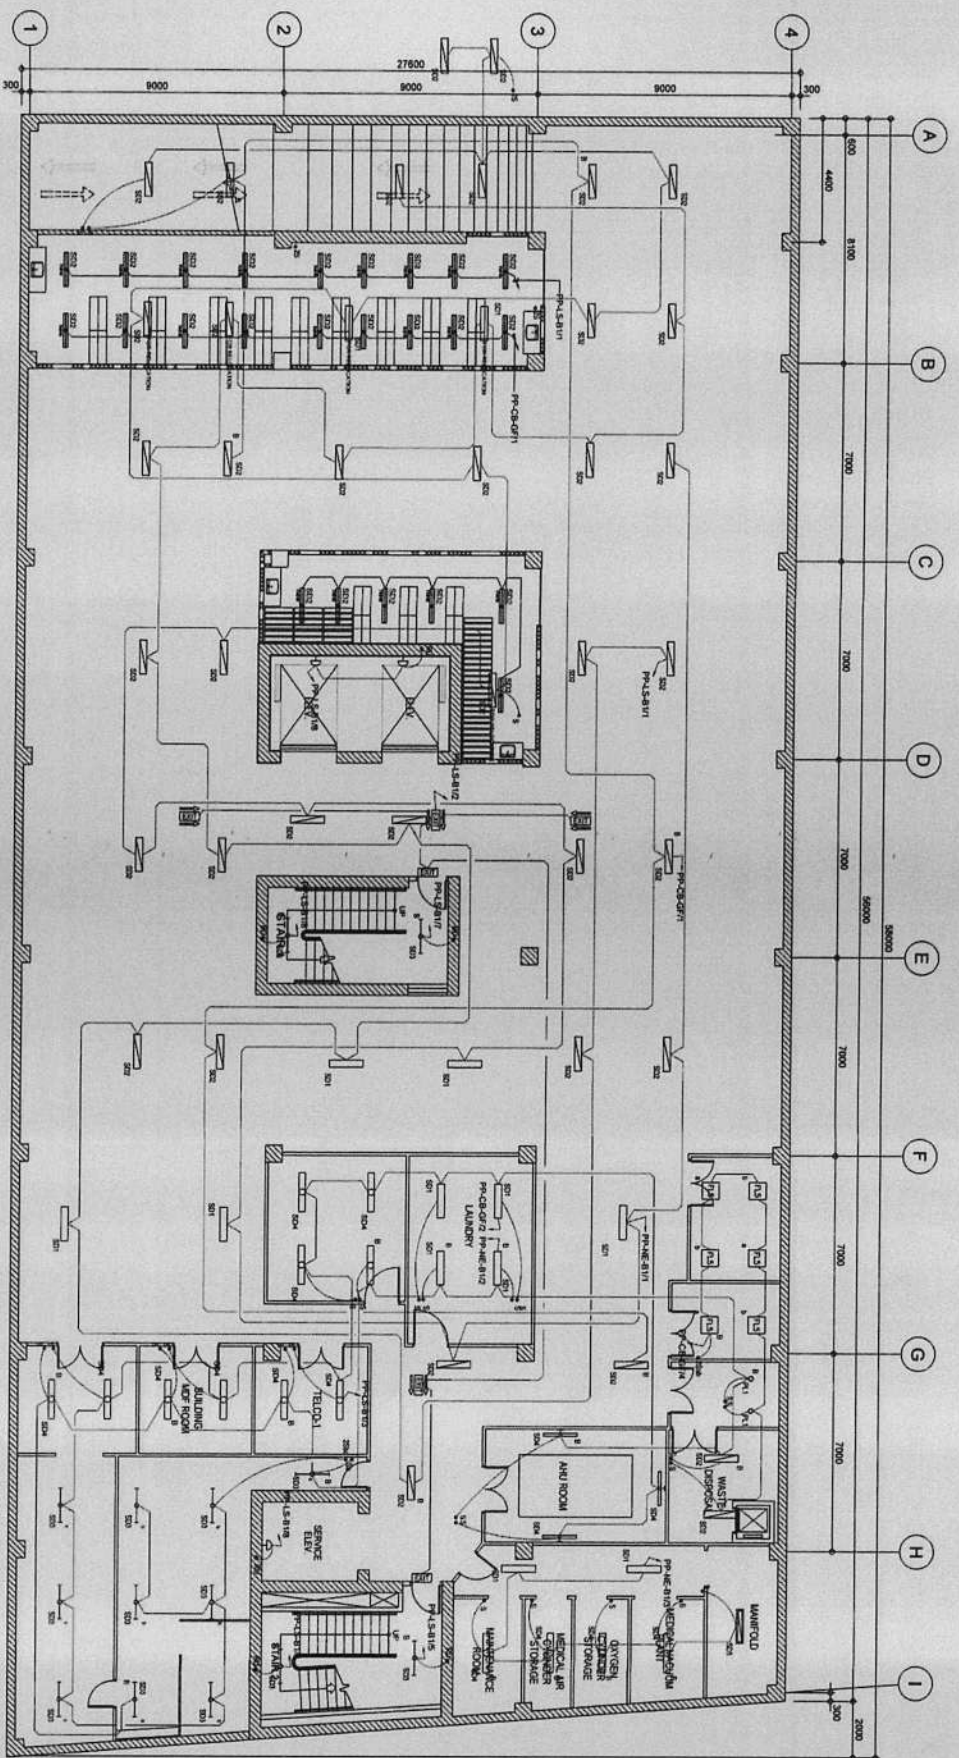

PROPOSED REPAIR WORKS
BASEMENT LIGHTING LAYOUT
SCALE 1:100



REPUBLIC OF THE PHILIPPINES
CITY OF PASIG
OFFICE OF THE MAYOR
CITY ENGINEERING OFFICE

PROJECT TITLE:
PROPOSED EXPANSION W/
IMPROVEMENT WORKS AT
PASIG CITY CHILDREN'S HOSPITAL
LOCATION: REGISTRATION COR. ALICIAE JOSE STS.
PASIG CITY

PROJECT IN CHARGE:
ENGR. CHRISTOPHER BENEDICT C. SOLOMON
ENGR. EDUARDO C. DELA CRUZ, JR.
ENGR. JOHN FRANCIS T. COYTES

PROGRAMMING AND CONSTRUCTION:
ENGR. JORGE L. TIZON
OIC, ELECTRICAL INSPECTION DIVISION

RECOMMENDING APPROVAL:
ENGR. JUAN B. BRUDENCIO
ENGR. ARTABERRES V. GERONIMO
OIC, CITY ENGINEERING OFFICE


APPROVED BY:
VICTOR MA. REGIS N. SOTTO
CITY MAYOR

SHEET CONTENT:
LIGHTING LAYOUT

SHEET NO.
E
09173

IMPORTANT NOTES:
1. THIS DRAWING IS THE PROPERTY OF THE CITY ENGINEERING OFFICE. IT IS TO BE USED ONLY FOR THE PROJECT AND SITE SPECIFICALLY MENTIONED THEREIN.
2. IN ANY CASE, THE CONTRACTOR SHALL BE RESPONSIBLE FOR THE PROTECTION OF THE EXISTING UTILITIES AND STRUCTURES.
3. IN CASE OF DISCREPANCY IN THE DIMENSIONS, THE LARGER SHALL BE THE GOVERNING DIMENSION.
4. THE CONTRACTOR SHALL BE RESPONSIBLE FOR THE PROTECTION OF THE EXISTING UTILITIES AND STRUCTURES.
5. THIS DRAWING IS THE PROPERTY OF THE CITY ENGINEERING OFFICE. IT IS TO BE USED ONLY FOR THE PROJECT AND SITE SPECIFICALLY MENTIONED THEREIN.
6. THE CONTRACTOR SHALL BE RESPONSIBLE FOR THE PROTECTION OF THE EXISTING UTILITIES AND STRUCTURES.

CONTRACTOR

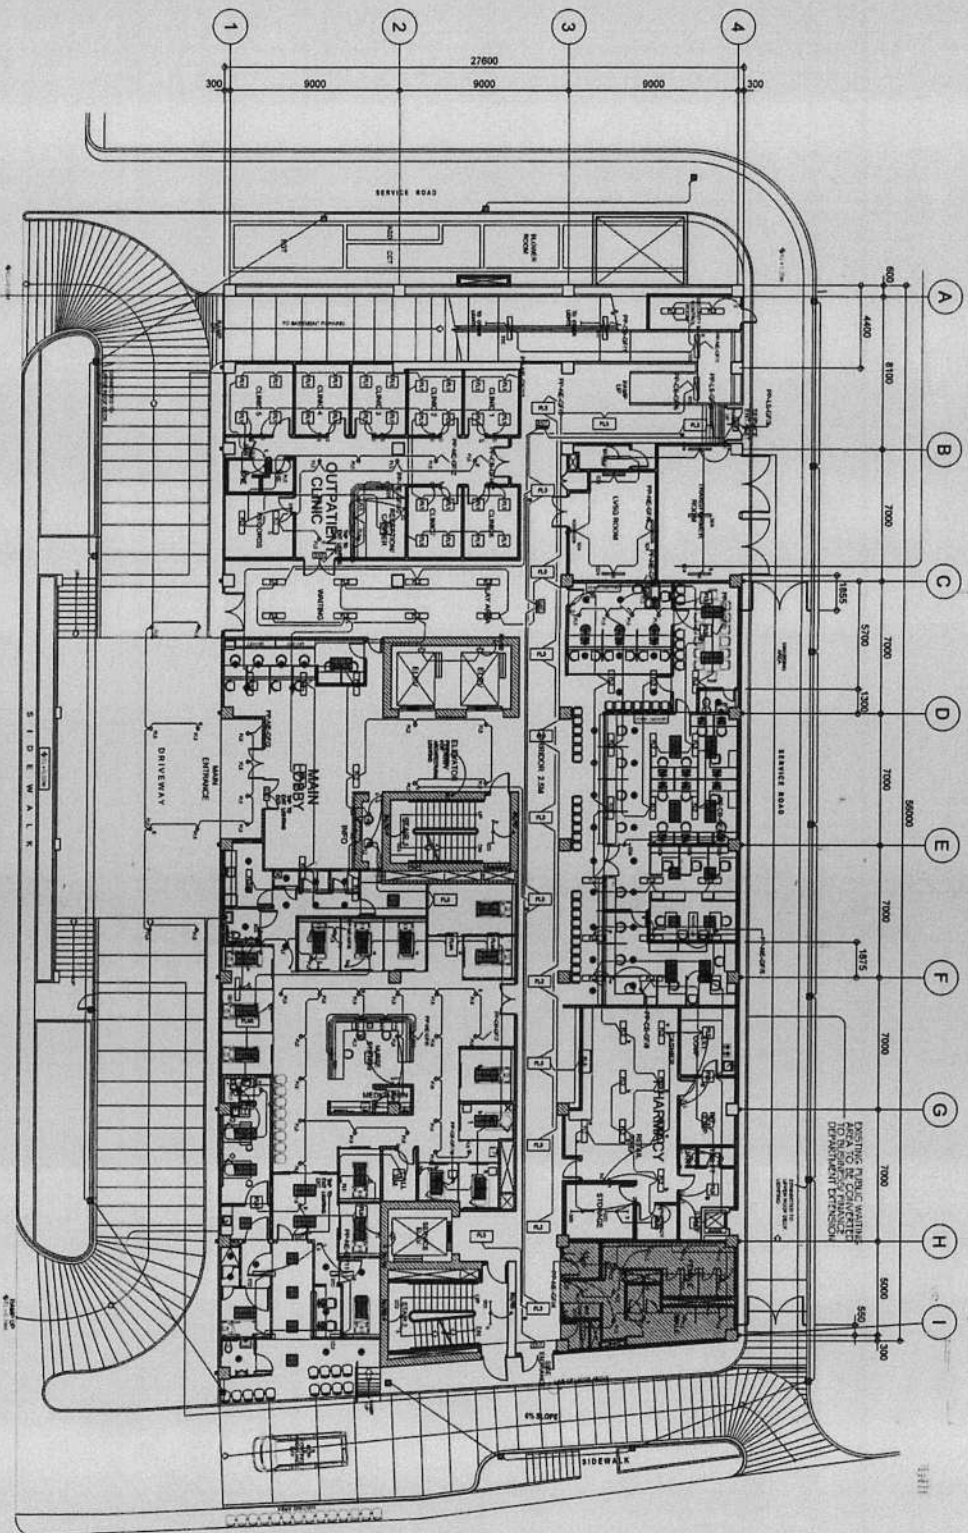

PROPOSED REPAIR WORKS
GROUND FLOOR LIGHTING LAYOUT
SCALE 1:150 ILLM

- SCOPE OF WORKS:
1. Installation of Lighting Fixtures and Convenience Outlets at Finance Department and some areas at Emergency Room.
 2. Replacement of Fluorescent Lamp Tube to LED Lamp Tube
 3. Installation of Emergency Lights



REPUBLIC OF THE PHILIPPINES
CITY OF PASIG
OFFICE OF THE MAYOR
CITY ENGINEERING OFFICE

PROJECT TITLE:
PROPOSED EXPANSION WITH IMPROVEMENT WORKS AT PASIG CITY CHILDREN'S HOSPITAL

PROJECT IN CHARGE:
ENGR. **EDUARDO B. SOLORSON**
ENGR. **EDUARDO B. SOLORSON**

PROGRAMMING AND CONSTRUCTION:
ENGR. **JOSE L. TIZON**
ENGR. **JOSE L. TIZON**


RECOMMENDING APPROVAL:
ENGR. **LAVINIA B. PRUDENCIO**
ENGR. **LAVINIA B. PRUDENCIO**

APPROVED BY:
VICTOR MA. REGIS N. SOTTO
CITY MAYOR

SHEET NO. **E**
SHEET NO. **1073**

CONFORME & ACCEPTED BY:
CONTRACTOR

IMPORTANT NOTES:
1. NO ALTERATION IN SCALE, DIMENSIONS, OR MATERIALS SHALL BE MADE WITHOUT THE WRITTEN APPROVAL OF THE ARCHITECT.
2. IN ANY CASE, THE CONTRACTOR SHALL BE RESPONSIBLE FOR THE PROTECTION OF THE EXISTING UTILITIES AND STRUCTURES.
3. TO THE ARCHITECT, THE CONTRACTOR SHALL BE RESPONSIBLE FOR THE PROTECTION OF THE EXISTING UTILITIES AND STRUCTURES.
4. THE CONTRACTOR SHALL BE RESPONSIBLE FOR THE PROTECTION OF THE EXISTING UTILITIES AND STRUCTURES.

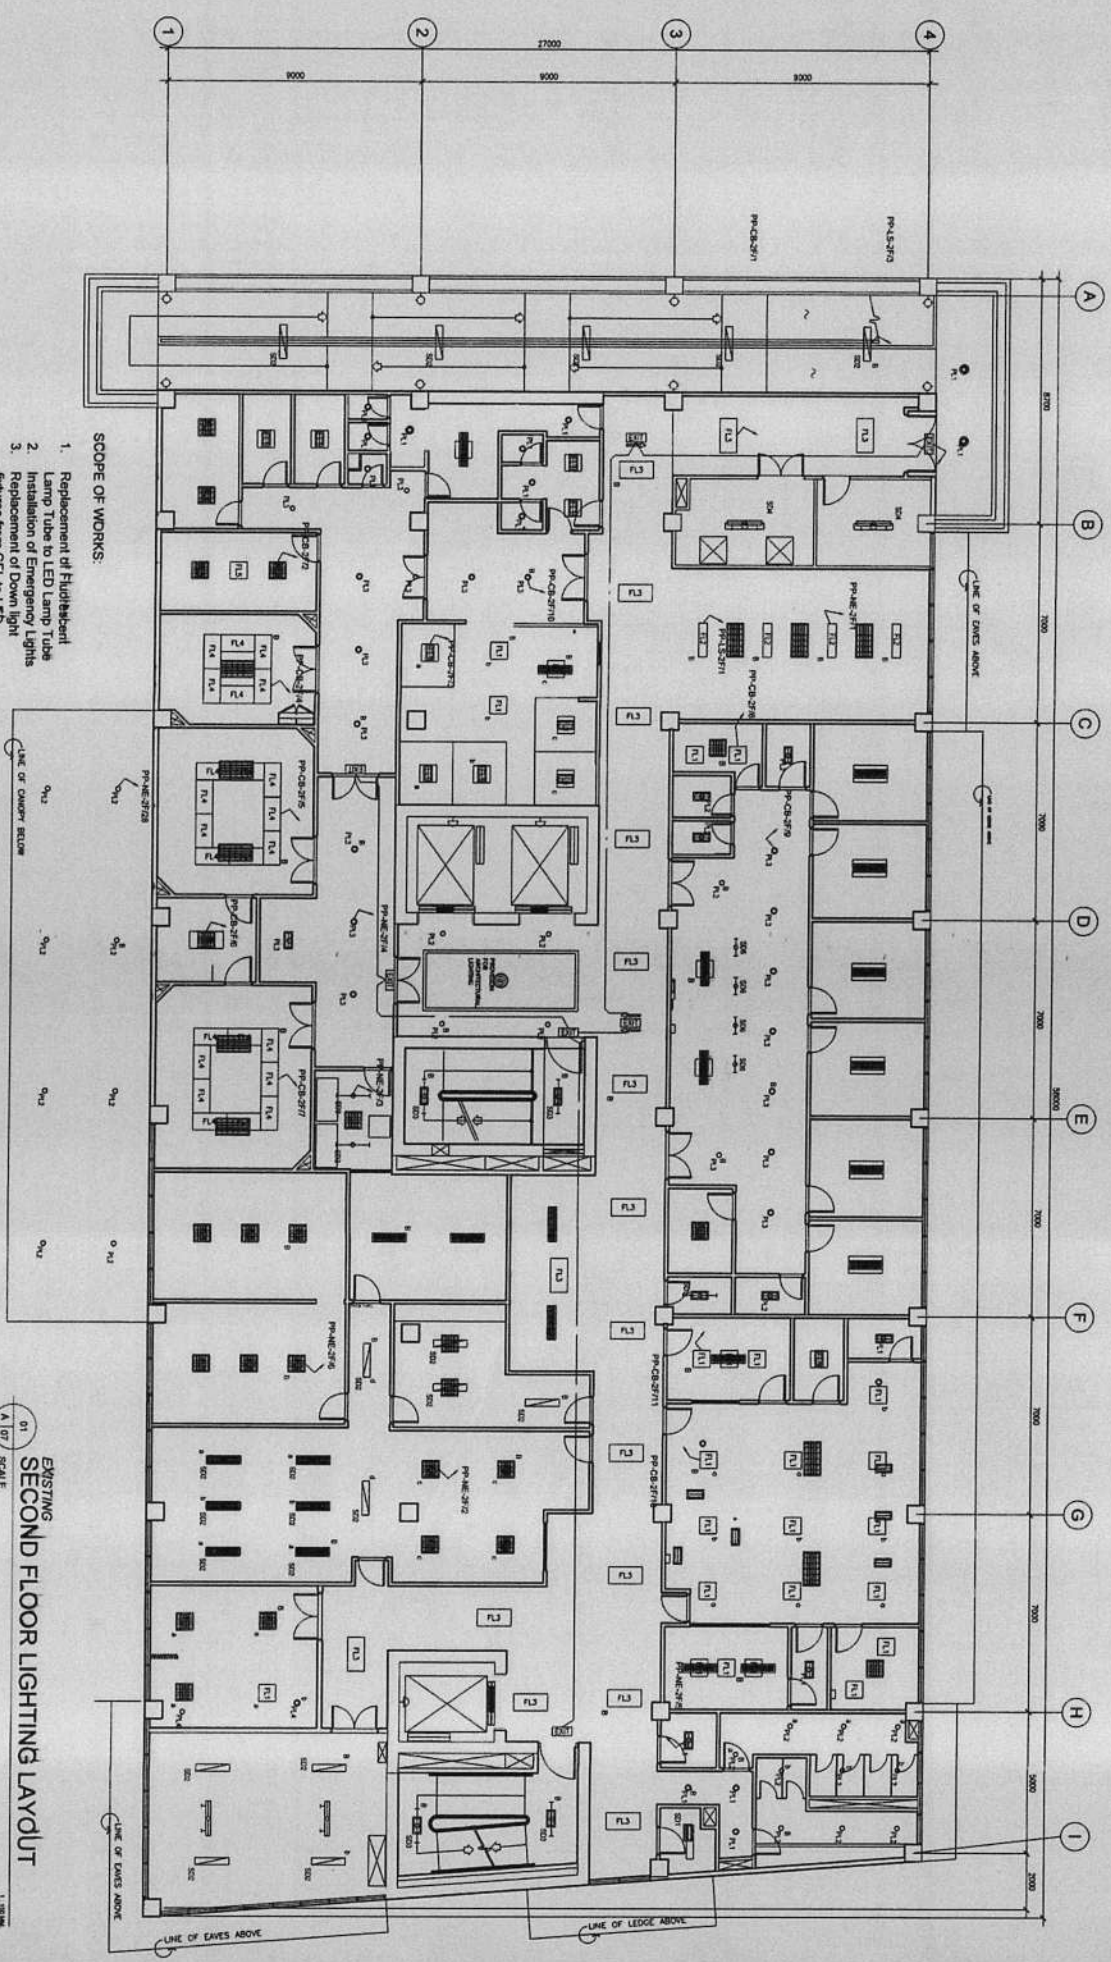

- SCOPE OF WORKS:**
1. Replacement of Fluorescent Lamp Tube to LED Lamp Tube
 2. Installation of Emergency Lights
 3. Replacement of Down light fixtures from CFL to LED Panelized Type

EXISTING
SECOND FLOOR LIGHTING LAYOUT


01
A OF SCALE

1:100

<p>REPUBLIC OF THE PHILIPPINES OFFICE OF THE MAYOR CITY ENGINEERING OFFICE</p>		<p>PROJECT TITLE: PROPOSED EXPANSION W/ IMPROVEMENT WORKS AT PASIG CITY CHILDREN'S HOSPITAL</p>	
<p>PROJECT IN CHARGE: ENGR. CHRISTIAN S. SOLIMON ENGR. EDUARDO B. BAHILUA, JR. ENGR. JOHN JESSICA T. CORTES</p>		<p>PROBABLE AND CONTRIBUTOR: ENGR. CHRYSLER BELIN ENGR. JORGE L. TIZON OIC. ELECTRICAL INFRASTRUCTURE SECTION</p>	
<p>RECOMMENDING APPROVAL: ENGR. LANCE SPRUDENCO ENGR. ARTABERYS V. GERONIMO OIC. CITY ENGINEERING OFFICE</p>		<p>APPROVED BY: VICTOR MA. REGIN SOTTO CITY MAYOR</p>	
<p>SHEET CONTENT: EXISTING LIGHTING LAYOUT</p>		<p>SHEET NO.: 1173</p>	
<p>CONTRACTOR: CONFORME ACCEPTED BY:</p>			

IMPORTANT NOTES:

1. NO ALTERATION IN PLANS & SPECIFICATIONS SHALL BE MADE WITHOUT THE APPROVAL OF THE ARCHITECT AND THE ENGINEER.
2. CONTRACTOR SHALL BE RESPONSIBLE FOR THE PROTECTION OF ALL EXISTING UTILITIES AND STRUCTURES.
3. TO THE BEST OF HIS KNOWLEDGE AND BELIEF, THE CONTRACTOR SHALL BE RESPONSIBLE FOR THE PROTECTION OF ALL EXISTING UTILITIES AND STRUCTURES.
4. CONTRACTOR SHALL BE RESPONSIBLE FOR THE PROTECTION OF ALL EXISTING UTILITIES AND STRUCTURES.
5. TO THE BEST OF HIS KNOWLEDGE AND BELIEF, THE CONTRACTOR SHALL BE RESPONSIBLE FOR THE PROTECTION OF ALL EXISTING UTILITIES AND STRUCTURES.

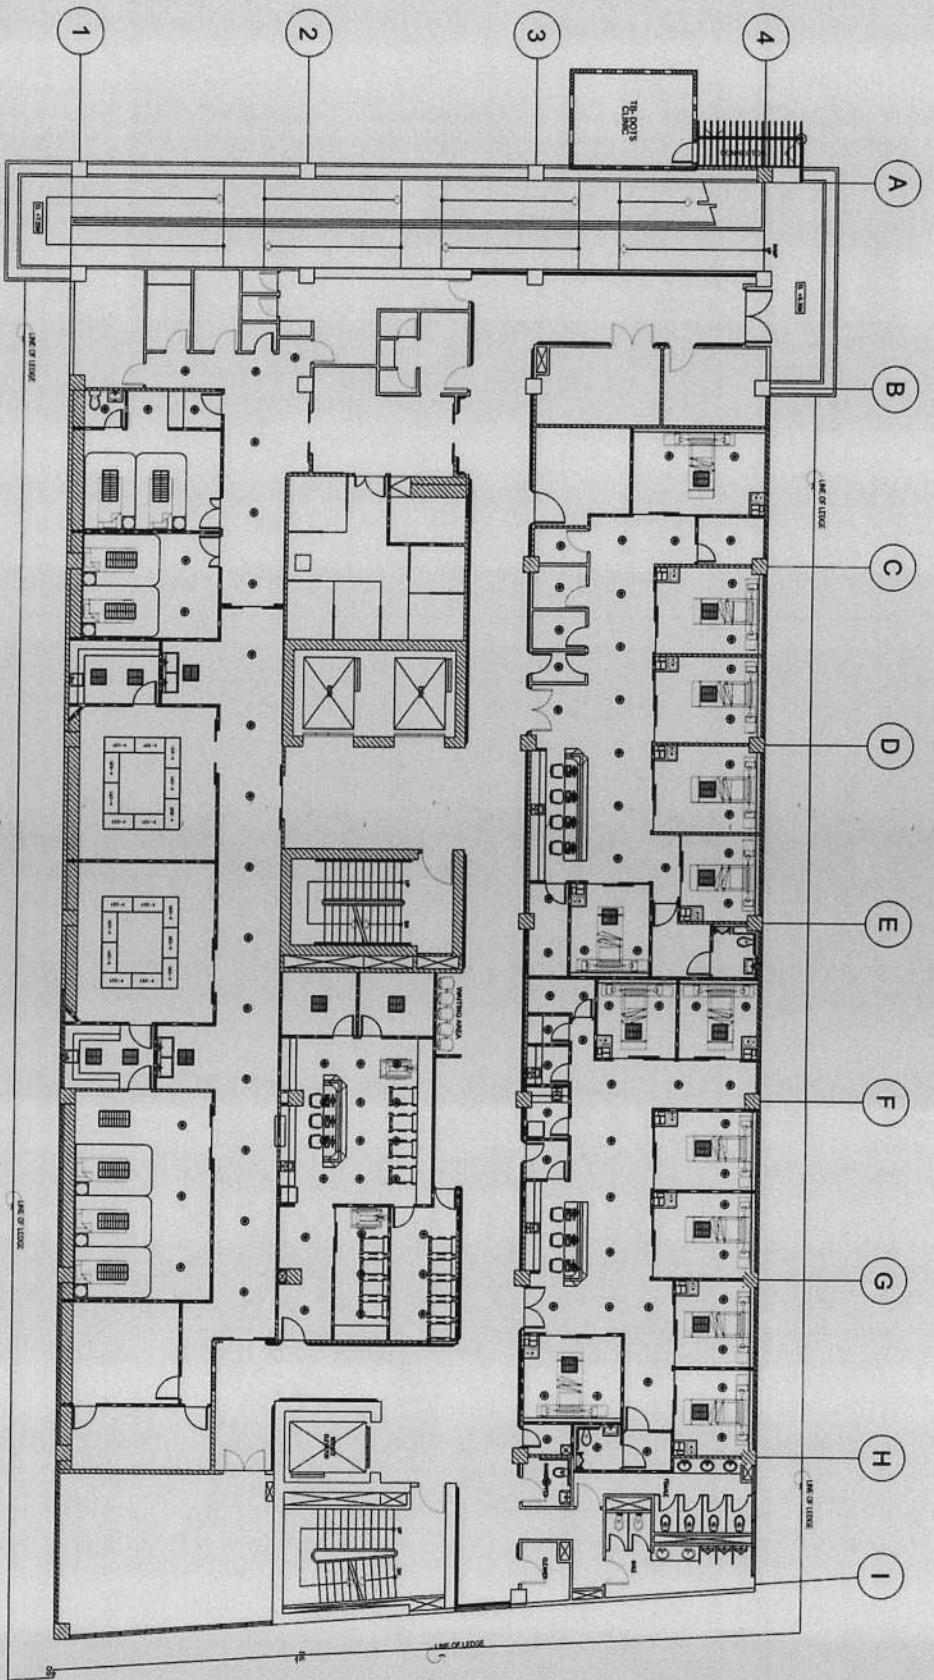

PROPOSED LAYOUT FOR REPAIR WORKS
 SECOND FLOOR LIGHTING LAYOUT
 1:150 SCALE


- SCOPE OF WORKS:
1. Installation of Lighting Fixtures at Intensive Care Unit Wards and Operating Rooms.
 2. Tapped to existing Panels/birds.
 3. Rewiring of Electrical System.

<p>REPUBLIC OF THE PHILIPPINES CITY OF PASIG OFFICE OF THE MAYOR CITY ENGINEERING OFFICE</p>	<p>PROJECT TITLE PROPOSED EXPANSION W/ IMPROVEMENT WORKS AT PASIG CITY CHILDREN'S HOSPITAL</p>	<p>PROJECT IN CHARGE: ENGR. CHRISTOPHER S. SOLONON ENGR. EDUARDO A. MARIQUA JR. ENGR. JOHN JOSEFA T. COOTES</p>	<p>PROGRAMMING AND CONSTRUCTION: ENGR. JEROME L. TIRON O.P.C. Electrical Infrastructure-Electrical</p>	<p>RECOMMENDING APPROVAL: ENGR. ANTONIO B. TRINIDAD ENGR. ARTAVERTES V. GERONIMO</p>	<p>APPROVED BY: VICTOR MA. REGIS N. SOTTO CITY MAYOR</p>	<p>SHEET CONTENT: LIGHTING LAYOUT</p> <p>SHEET NO. E 12173</p>
---	--	--	--	--	--	---

IMPORTANT NOTES:

1. SEE THE GENERAL NOTES AND SPECIFICATIONS OF THE PROJECT FOR THE LOCATION OF THE WORKS.
2. ALL WORKS TO BE DONE IN ACCORDANCE WITH THE CITY ENGINEERING OFFICE STANDARDS AND SPECIFICATIONS.
3. THE CONTRACTOR SHALL BE RESPONSIBLE FOR THE PROTECTION OF ALL EXISTING UTILITIES AND STRUCTURES.
4. THE CONTRACTOR SHALL BE RESPONSIBLE FOR THE PROTECTION OF ALL EXISTING UTILITIES AND STRUCTURES.
5. THE CONTRACTOR SHALL BE RESPONSIBLE FOR THE PROTECTION OF ALL EXISTING UTILITIES AND STRUCTURES.
6. THE CONTRACTOR SHALL BE RESPONSIBLE FOR THE PROTECTION OF ALL EXISTING UTILITIES AND STRUCTURES.


CONFORME & ACCEPTED BY:
 CONTRACTOR

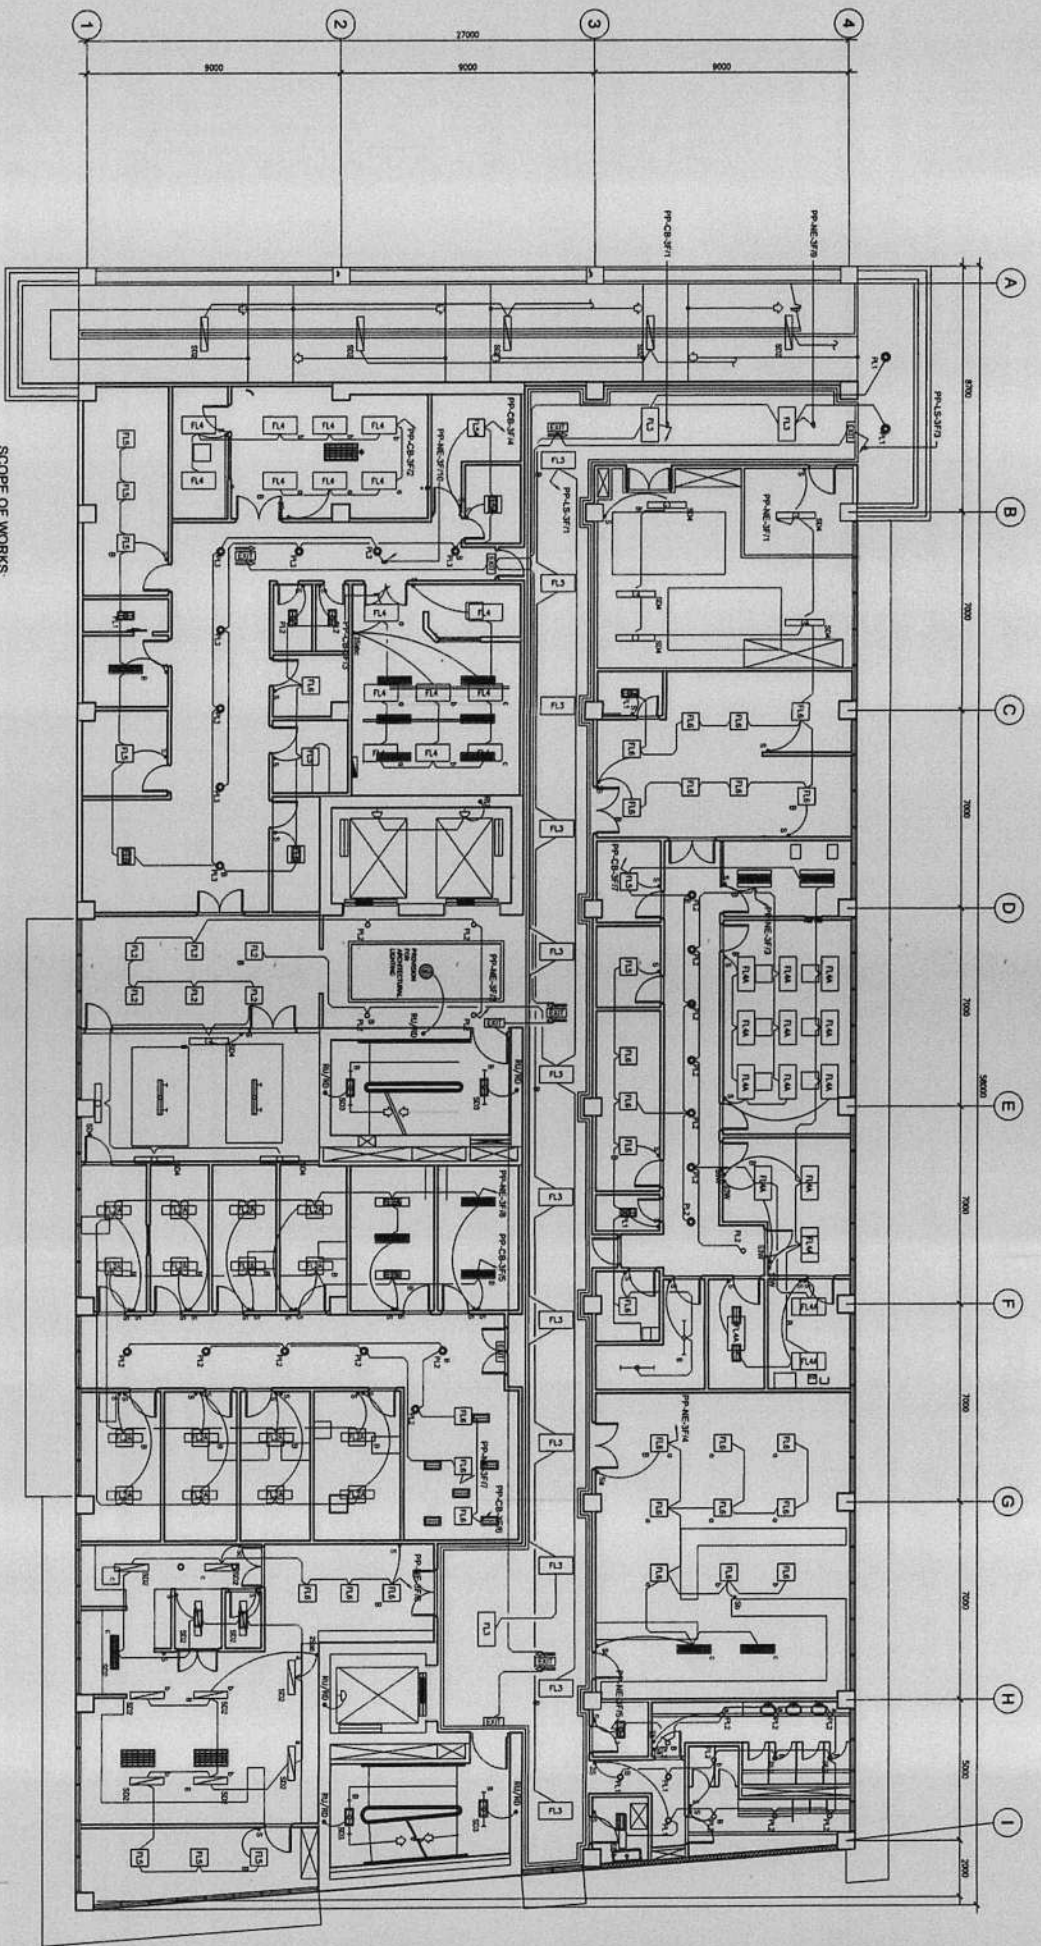

- SCOPE OF WORKS:
1. Replacement of Fluorescent Lamp Tube to LED Lamp Tube
 2. Installation of Emergency Lights
 3. Replacement of Down light fixtures from CFL to LED Panelized Type


EXISTING
THIRD FLOOR LIGHTING LAYOUT
SCALE: 1/8" = 1'-0"


	REPUBLIC OF THE PHILIPPINES CITY OF PASIG OFFICE OF THE MAYOR CITY ENGINEERING OFFICE	PROJECT TITLE PROPOSED EXPANSION W/ IMPROVEMENT WORKS AT PASIG CITY CHILDREN'S HOSPITAL	PROJECT IN CHARGE: ENGR. CHRISTOPHER B. SOLICOMEN ENGR. EDUARDO BARRONCA JR. ENGR. JOYNTI M. CORTES	PROGRAMMING AND CONSTRUCTION: ENGR. JORGE L. TZON	RECOMMENDING APPROVAL: ENGR. PRUDENCIO ENGR. ARTAVARDES V. GERONIMO	APPROVED BY: VICTOR M. REGIS N. SOTTO CITY MAYOR	SHEET CONTENT: EXISTING LIGHTING LAYOUT	SHEET NO.: 1373
	LOCATION: INDUSTRIAL COM. AL CALATE JOSE STS. NO. 10 INDUSTRIAL COM. AL CALATE JOSE STS. UNIT 101 INDUSTRIAL COM. AL CALATE JOSE STS. UNIT 101 INDUSTRIAL COM. AL CALATE JOSE STS. UNIT 101	1. NO. 10 INDUSTRIAL COM. AL CALATE JOSE STS. UNIT 101 2. NO. 10 INDUSTRIAL COM. AL CALATE JOSE STS. UNIT 101 3. NO. 10 INDUSTRIAL COM. AL CALATE JOSE STS. UNIT 101 4. NO. 10 INDUSTRIAL COM. AL CALATE JOSE STS. UNIT 101	1. TO THE ARCHITECT IN THE DRAWING, THE OWNER SHALL BE RESPONSIBLE FOR THE 2. TO THE ARCHITECT IN THE DRAWING, THE OWNER SHALL BE RESPONSIBLE FOR THE 3. TO THE ARCHITECT IN THE DRAWING, THE OWNER SHALL BE RESPONSIBLE FOR THE 4. TO THE ARCHITECT IN THE DRAWING, THE OWNER SHALL BE RESPONSIBLE FOR THE	1. PROJECT IN CHARGE: THE ARCHITECT SHALL OBTAIN THE PROJECT AT ALL 2. THE ARCHITECT SHALL BE RESPONSIBLE FOR THE DESIGN OF THE PROJECT AT ALL 3. THE ARCHITECT SHALL BE RESPONSIBLE FOR THE DESIGN OF THE PROJECT AT ALL 4. THE ARCHITECT SHALL BE RESPONSIBLE FOR THE DESIGN OF THE PROJECT AT ALL	CONTRACTOR			

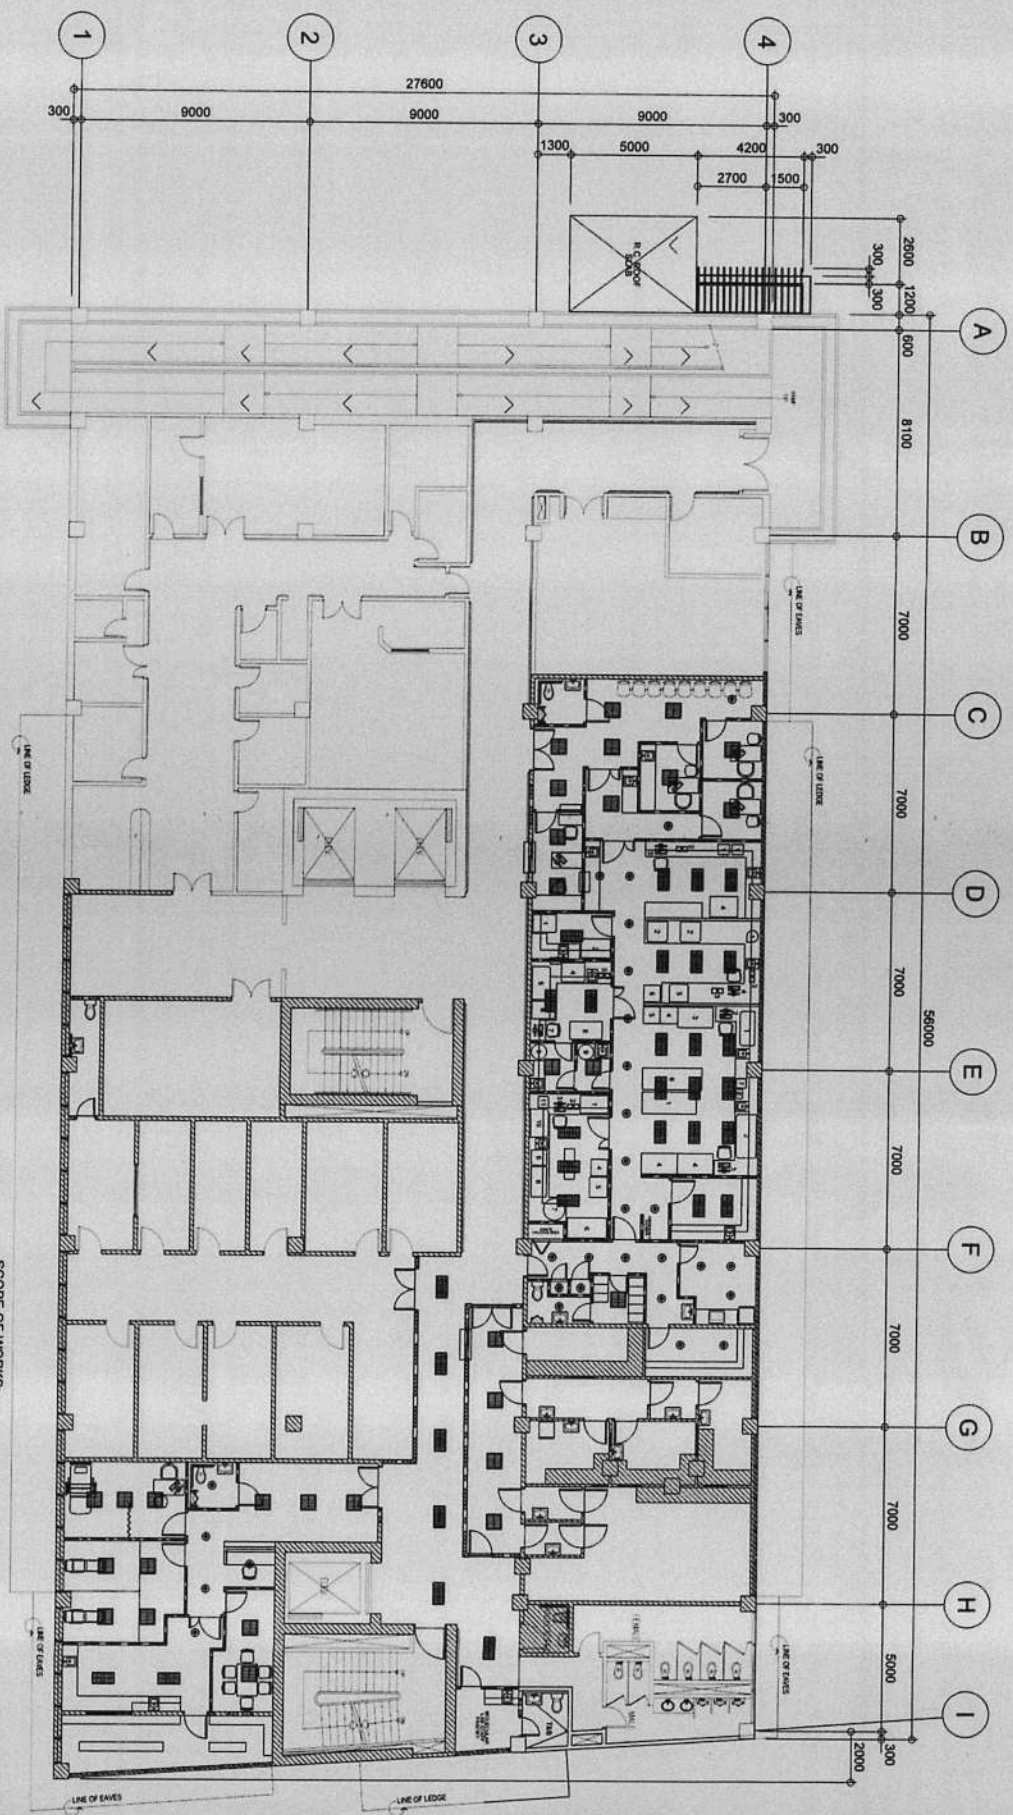

PROPOSED LAYOUT FOR REPAIR WORKS
 THIRD FLOOR LIGHTING LAYOUT
 1/8" = 1'-0" SCALE

- SCOPE OF WORKS:
1. Installation of New Lighting Fixtures at Intensive Care Unit Wards and Operating Rooms
 2. Tapped to existing Lighting Circuit Homeruns of Panelboards.

 REPUBLIC OF THE PHILIPPINES CITY OF PASIG OFFICE OF THE MAYOR CITY ENGINEERING OFFICE		PROJECT TITLE: PROPOSED EXPANSION W/ IMPROVEMENT WORKS AT PASIG CITY CHILDREN'S HOSPITAL		PROJECT IN CHARGE: ENGR. CHERYL S. SOLONON ENGR. DONALD BELIN		PROGRAMMING AND CONSTRUCTION: ENGR. JOHNNIE TIZON ENGR. JOHNNIE TIZON		RECOMMENDING APPROVAL: ENGR. MARCELO ESPINDEO ENGR. ARTAYSERVES V. GERONIMO		APPROVED BY: VICTOR MA. REGIS N. SOTTO CITY MAYOR		SHEET CONTENT: LIGHTING LAYOUT		SHEET NO.: 1473	
LOCATION: INDUSTRIAL COR. ALCOHOL JOSE STS. PASIG CITY		ENGR. ENRIQUE O. BARRERA JR. ENGR. JOHN JESSIE T. CORTES		ENGR. JOHNNIE TIZON ENGR. JOHNNIE TIZON		ENGR. MARCELO ESPINDEO ENGR. ARTAYSERVES V. GERONIMO		APPROVED BY: VICTOR MA. REGIS N. SOTTO CITY MAYOR		SHEET CONTENT: LIGHTING LAYOUT		SHEET NO.: 1473		CONTRACTOR: CONFIRMED & ACCEPTED BY:	
WORKSHEET NOTES: 1. FOR THE PROPOSED EXPANSION WORKS, THE EXISTING STRUCTURE SHALL BE REPAIR AND IMPROVED TO MEET THE REQUIREMENTS OF THE PROPOSED EXPANSION WORKS. 2. THE PROPOSED EXPANSION WORKS SHALL BE CONSTRUCTED IN ACCORDANCE WITH THE REQUIREMENTS OF THE PROPOSED EXPANSION WORKS. 3. THE PROPOSED EXPANSION WORKS SHALL BE CONSTRUCTED IN ACCORDANCE WITH THE REQUIREMENTS OF THE PROPOSED EXPANSION WORKS. 4. APPROVAL OF THIS PROPOSAL SHALL BE SUBJECT TO THE APPROVAL OF THE CITY ENGINEERING OFFICE. 5. PROJECT IN CHARGE SHALL BE RESPONSIBLE FOR THE PROVISION OF ALL NECESSARY PERMITS AND APPROVALS. 6. THE CONTRACTOR SHALL BE RESPONSIBLE FOR THE PROVISION OF ALL NECESSARY PERMITS AND APPROVALS.															

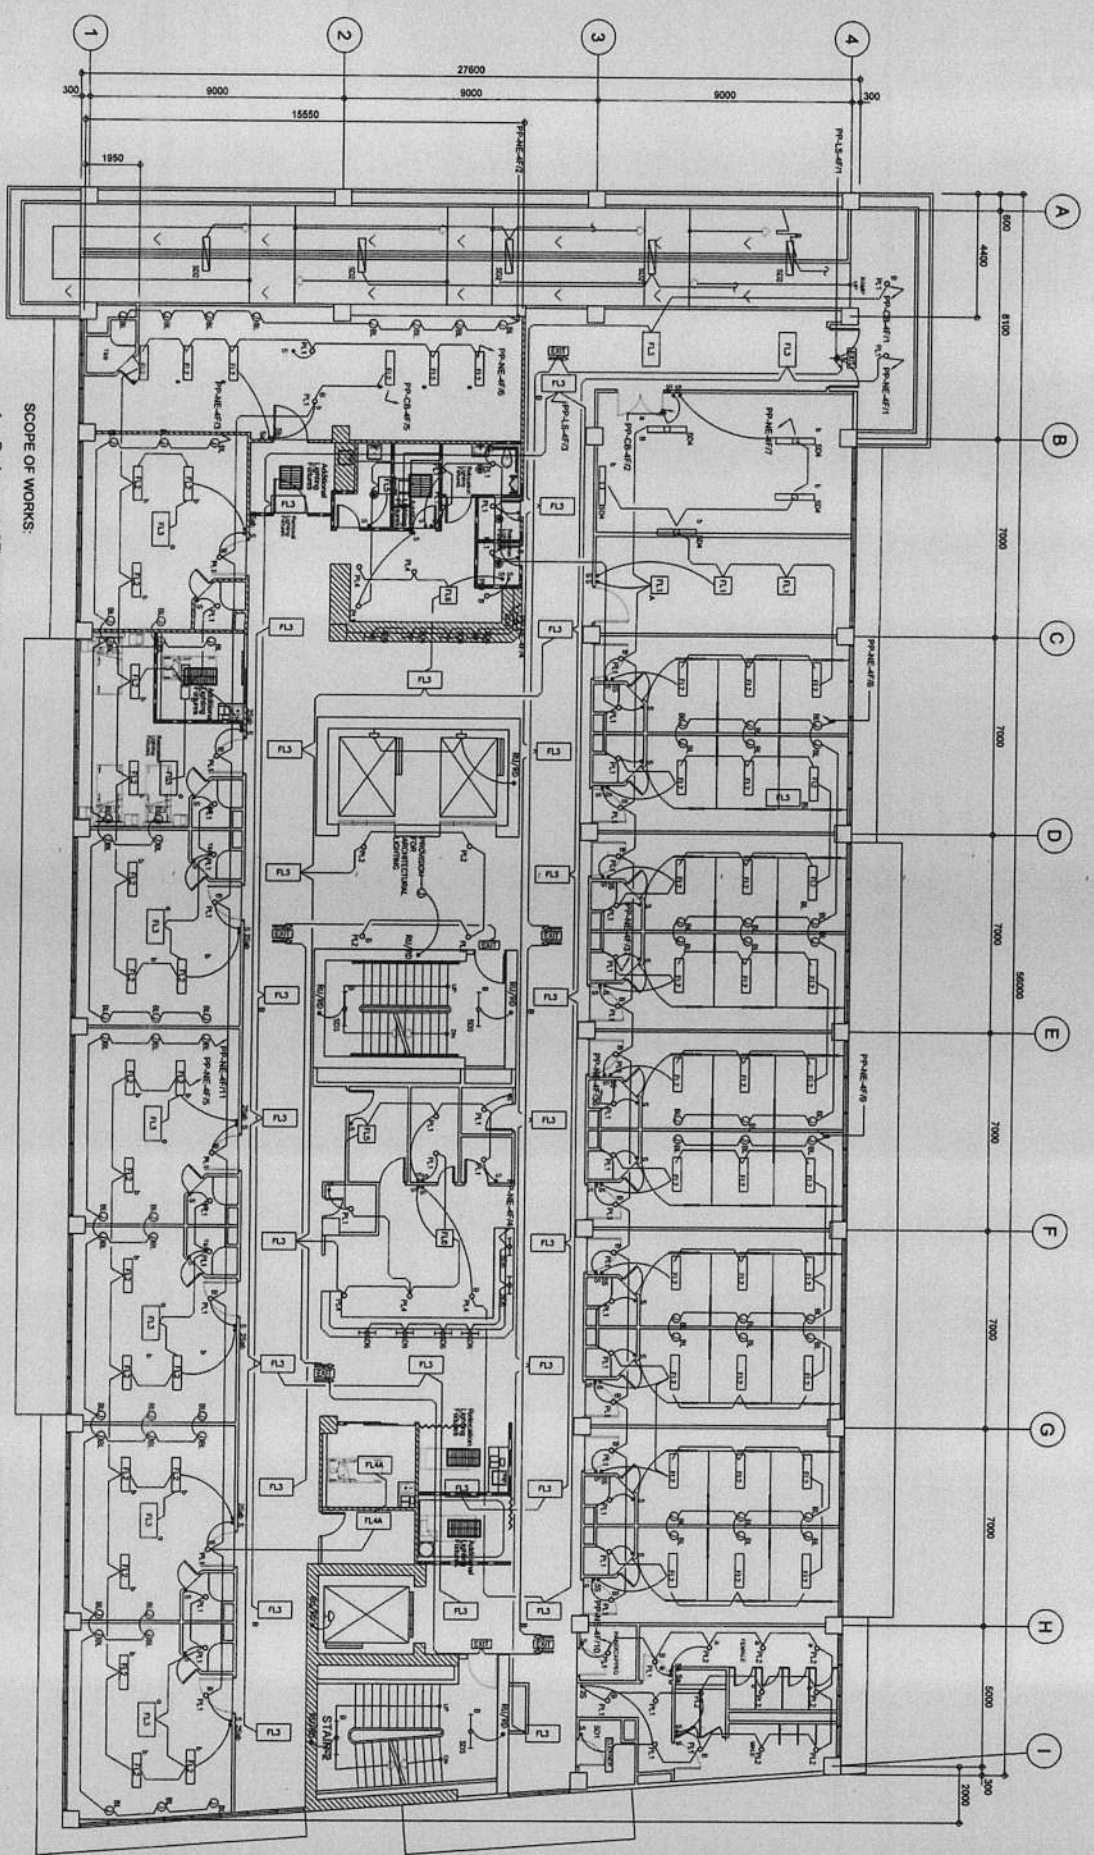

- SCOPE OF WORKS:**
1. Replacement of Fluorescent Lamp Tube to LED Lamp Tube
 2. Relocation of Lighting Fixtures affected by new partition.
 3. Replacement of Down light fixtures from CFL to LED Panelized Type

EXISTING FOURTH FLOOR LIGHTING LAYOUT

1/8" = 1'-0"


- SCOPE OF WORKS:**
1. Additional Hospital grade Outlet Treatment and Medication Room.
 2. Additional Lighting Fixtures at Proposed Revised Rooms.

REPUBLIC OF THE PHILIPPINES CITY OF PASIG CITY ENGINEERING OFFICE		PROJECT TITLE: PROPOSED EXPANSION W/ IMPROVEMENTS AT PASIG CITY CHILDREN'S HOSPITAL PASIGSITAN COR. ALCOVE JOSE STR., PASIGSITAN, PASIG CITY		PROJECT IN CHARGE: ENGR. CHARLES W. SANCHEZ ENGR. EDUARDO G. BARRERA JR. ENGR. JOHANNES T. COITES		PROGRAMMING AND CONSTRUCTION: ENGR. JOYCE L. TIZON OLC. ESTHER S. BARRERA		RECOMMENDING APPROVAL: ENGR. CARLOS BELAN ENGR. JUAN P. BERBERENDIO ENGR. ARTAVERDES V. GERONIMO OLC. CITY ENGINEERING OFFICE		APPROVED BY: VICTOR MA. REGIS N. SOTTO CITY MAYOR		SHEET CONTENT: EXISTING LIGHTING LAYOUT		SHEET NO. E 15173	
--	--	---	--	---	--	--	--	--	--	--	--	---	--	--------------------------------	--

IMPORTANT NOTES:

1. WORK SHALL BE IN ACCORDANCE WITH THE LATEST EDITIONS OF THE PHILIPPINE NATIONAL STANDARD SPECIFICATIONS FOR ELECTRICAL INSTALLATION.
2. IN CASE OF CONFLICT BETWEEN THE DRAWING AND THE SPECIFICATIONS, THE LATTER SHALL BE GIVEN PRIORITY.
3. IN CASE OF CONFLICT BETWEEN THE DRAWING AND THE SPECIFICATIONS, THE LATTER SHALL BE GIVEN PRIORITY.
4. CONSTRUCTION OF THE STRUCTURE SHALL BE COMPLETED AT THE EXPENSE OF THE CONTRACTOR.
5. THERE IS A HAZARD TO THE PROVISION OF WORK ON DAMAGED ELECTRICAL SYSTEMS. THE CONTRACTOR SHALL BE RESPONSIBLE FOR THE PROTECTION OF THE ELECTRICAL SYSTEMS.
6. THE CONTRACTOR SHALL BE RESPONSIBLE FOR THE PROTECTION OF THE ELECTRICAL SYSTEMS.


CONTRACTOR

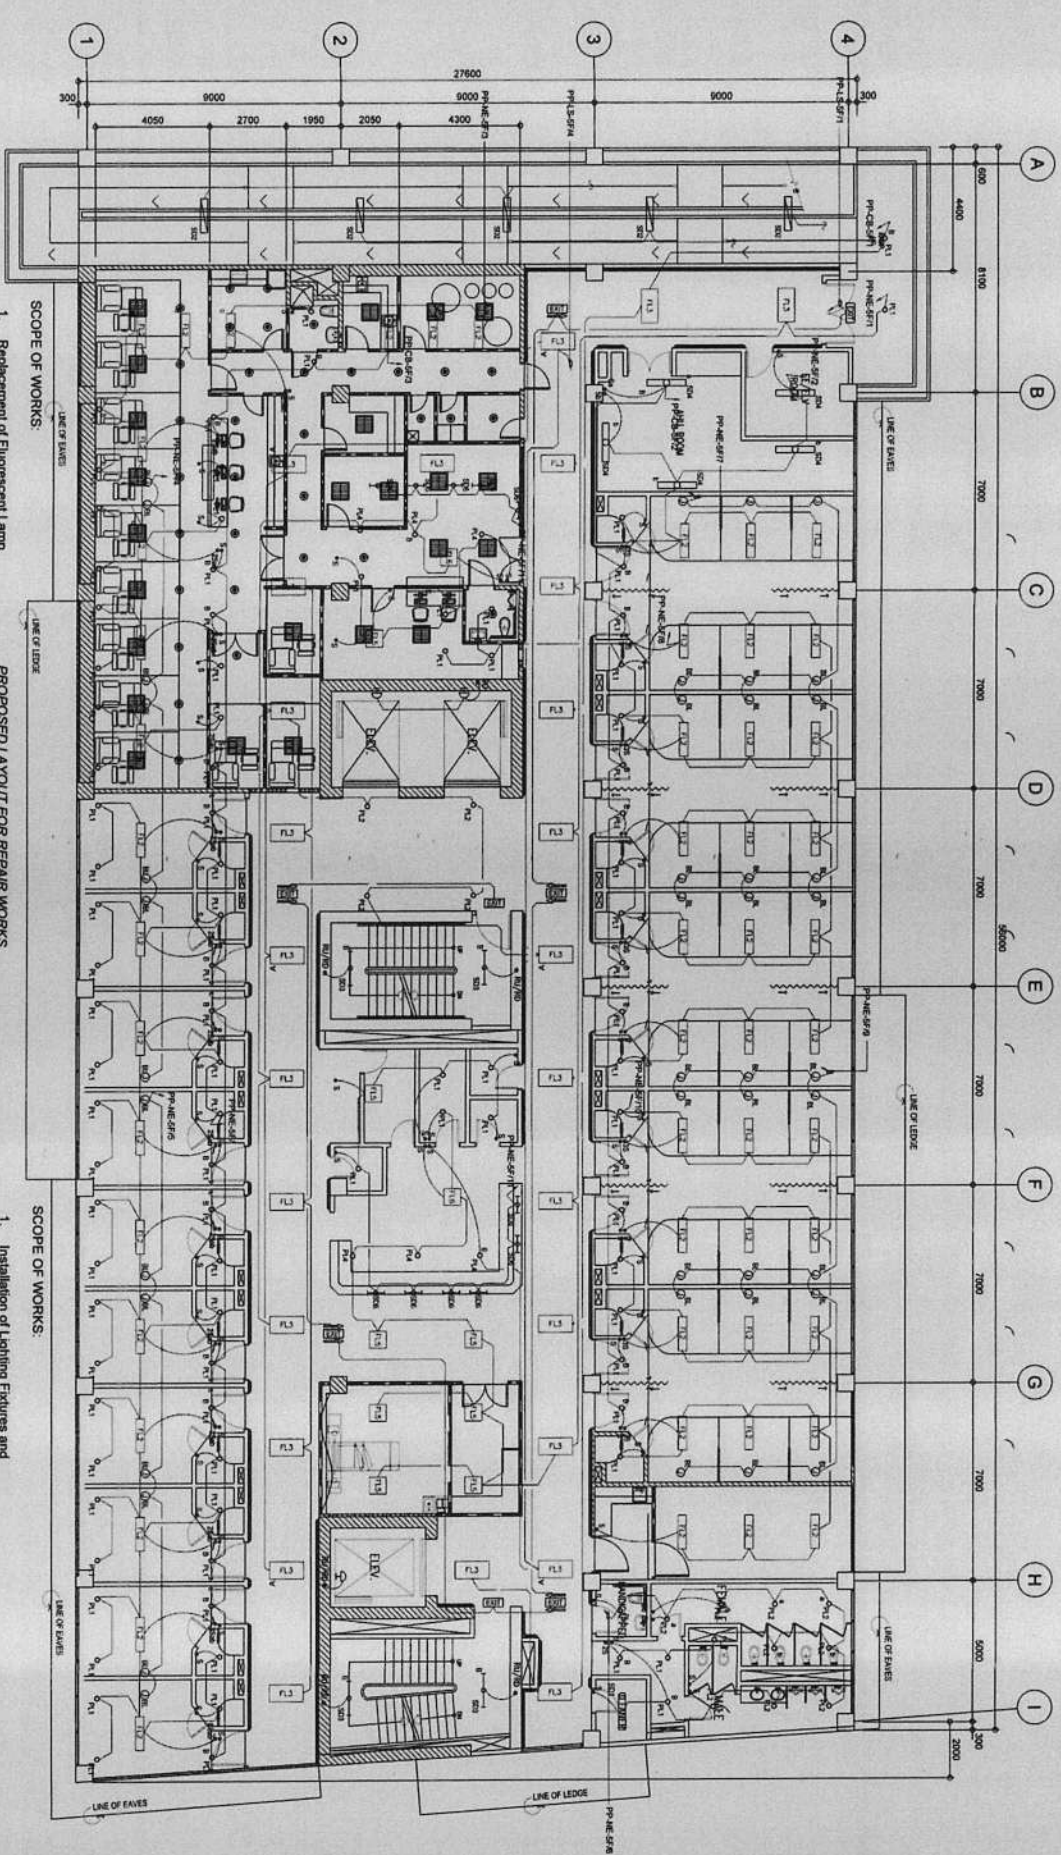

- SCOPE OF WORKS:**
1. Replacement of Fluorescent Lamp Tube to LED Lamp Tube
 2. Relocation of Lighting Fixtures
 3. Replacement of Down light fixtures from CFL to LED Paralelized Type

**PROPOSED LAYOUT FOR REPAIR WORKS
FIFTH FLOOR LIGHTING LAYOUT**

- SCOPE OF WORKS:**
1. Installation of Lighting Fixtures and Convenience Outlets
 2. Replacement of Fluorescent Lamp Tube to LED Lamp Tube
 3. Installation of Emergency Lights

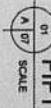


	REPUBLIC OF THE PHILIPPINES CITY OF PASIG OFFICE OF THE MAYOR CITY ENGINEERING OFFICE	PROJECT TITLE: PROPOSED EXPANSION W/ IMPROVEMENT WORKS AT PASIG CITY CHILDREN'S HOSPITAL	PROJECT IN CHARGE: ENGR. CHERYL ANN PEREZ C. SOLIMON ENGR. CARLA L. BELLIN	PROGRAMMING AND CONSTRUCTION: ENGR. JOSEF L. TTON ENGR. JOSEPH M. PRUDENCIO	RECOMMENDING APPROVAL: ENGR. ANTONIO V. GONZALEZ ENGR. ANTONIO V. GONZALEZ	APPROVED BY: VICTOR MA. REGIS N. SOTTO CITY ENGINEER	SHEET CONTENT: EXISTING AND PROPOSED LIGHTING LAYOUT	SHEET NO.: 1673
	LOCATION: PASIG CITY CHILDREN'S HOSPITAL PASIG CITY	PROJECT NO. / DATE: PASIG-2024-001 / 2024-01-15	PROJECT NO. / DATE: PASIG-2024-001 / 2024-01-15	PROJECT NO. / DATE: PASIG-2024-001 / 2024-01-15	PROJECT NO. / DATE: PASIG-2024-001 / 2024-01-15	PROJECT NO. / DATE: PASIG-2024-001 / 2024-01-15	PROJECT NO. / DATE: PASIG-2024-001 / 2024-01-15	PROJECT NO. / DATE: PASIG-2024-001 / 2024-01-15

IMPORTANT NOTES:

1. ALL DIMENSIONS ARE IN METERS UNLESS OTHERWISE SPECIFIED.
2. IN CASE OF CONFLICT BETWEEN DIMENSIONS, THE LARGER ONE SHALL BE USED.
3. TO BE ACCEPTED, THE CONTRACTOR SHALL SUBMIT TO THE ENGINEER A DETAILED REPORT ON THE PROGRESS OF THE WORKS.
4. THE CONTRACTOR SHALL BE RESPONSIBLE FOR OBTAINING ALL NECESSARY PERMITS AND APPROVALS FROM THE APPROPRIATE AGENCIES.
5. THE CONTRACTOR SHALL BE RESPONSIBLE FOR THE PROTECTION OF ALL EXISTING UTILITIES AND STRUCTURES.
6. THE CONTRACTOR SHALL BE RESPONSIBLE FOR THE PROTECTION OF ALL EXISTING UTILITIES AND STRUCTURES.

CONTRACTOR

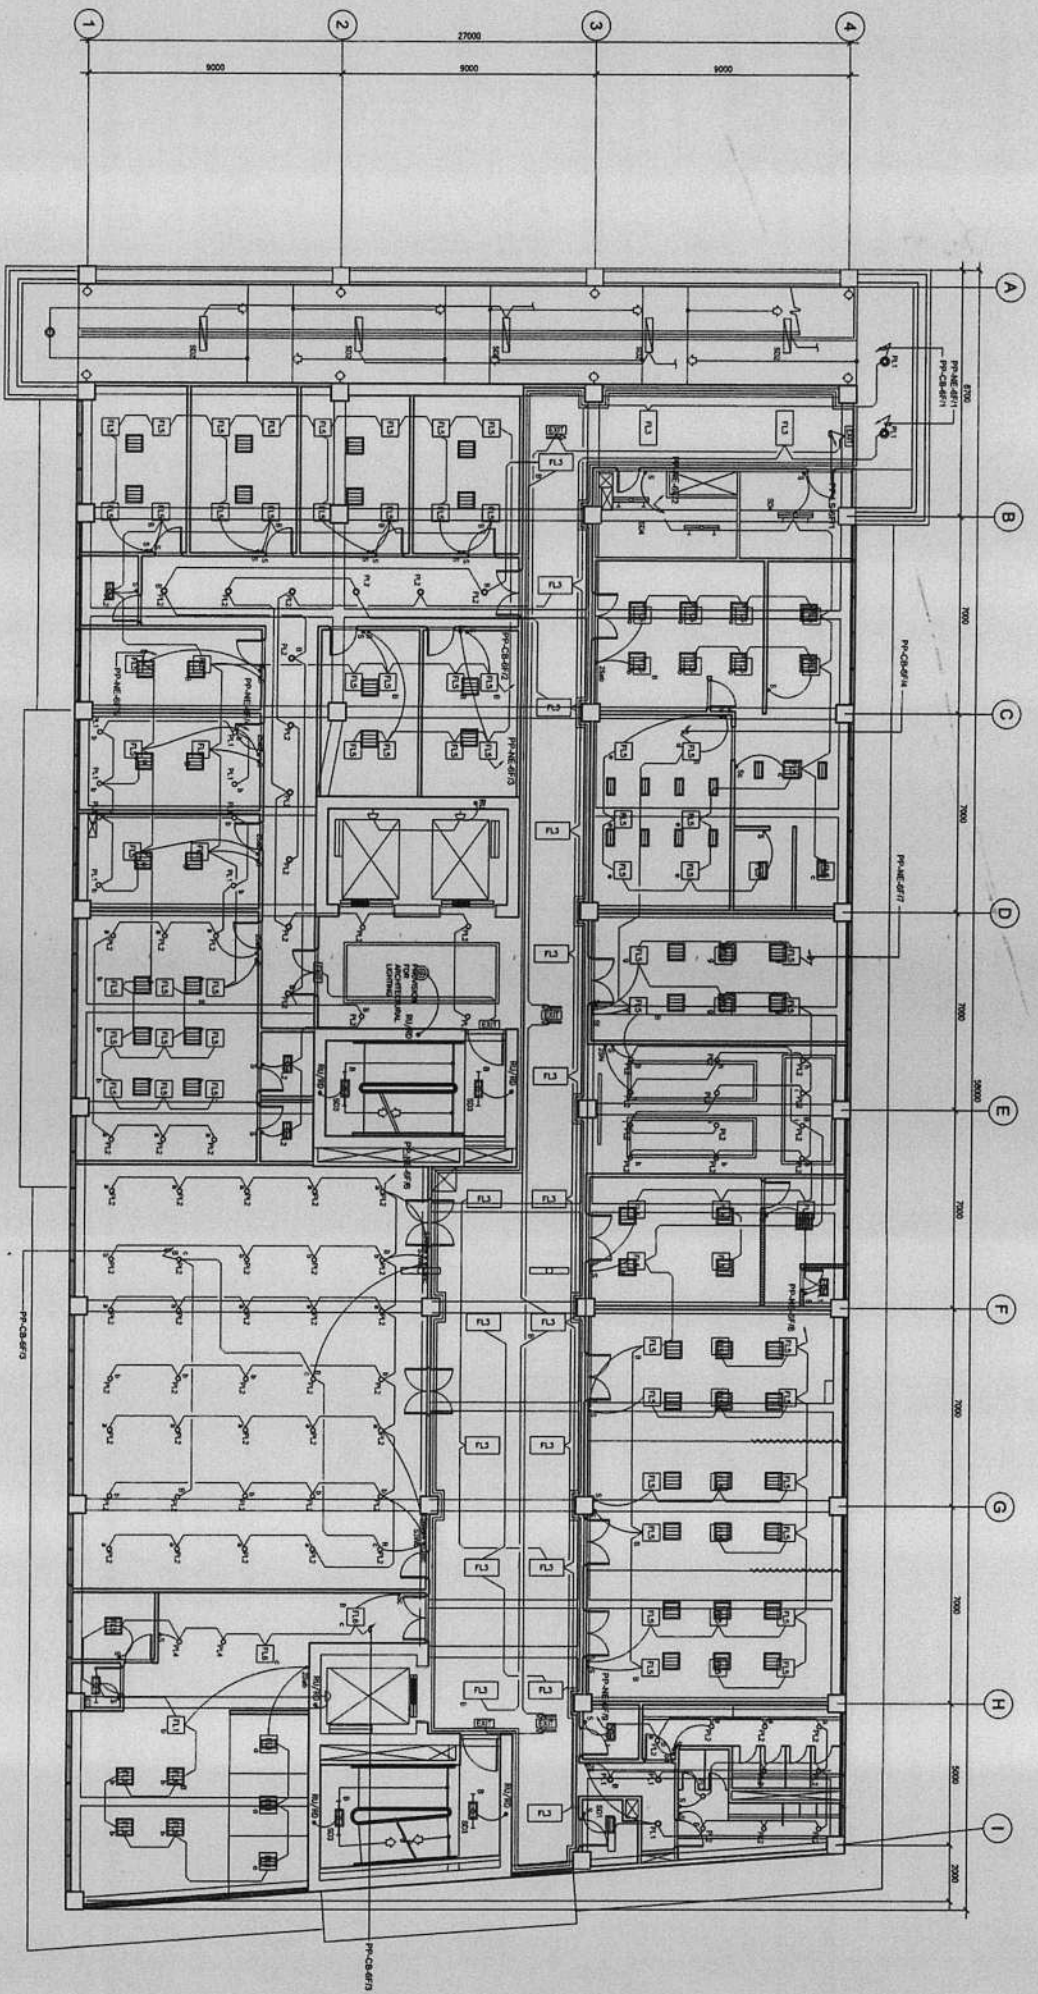

- SCOPE OF WORKS:**
1. Replacement of Fluorescent Lamp Tube to LED Lamp Tube
 2. Installation of Emergency Lights
 3. Replacement of Down light fixtures from CFL to LED Panelized Type

EXISTING LAYOUT FOR REPAIR WORKS
 SIXTH FLOOR LIGHTING LAYOUT
 1:1000 SCALE



REPUBLIC OF THE PHILIPPINES
 CITY OF PASIG
 OFFICE OF THE MAYOR
 CITY ENGINEERING OFFICE

PROJECT TITLE:
**PROPOSED EXPANSION W/
 IMPROVEMENT WORKS AT
 PASIG CITY CHILDREN'S HOSPITAL**

PROJECT IN CHARGE:
 ENGR. CHRISTOPHER MENDY C. SOLOMON
 ENGR. EDUARDO G. BARRERA, JR.

PROGRAMMING AND CONSTRUCTION:
 ENGR. CALAIL BELIN
 ENGR. JOYCE L. TIZON


RECOMMENDING APPROVAL:
 ENGR. JOSEPH B. BRUDENCO
 ENGR. ARTAVERDES V. GERONIMO

APPROVED BY:
 VICTOR MA. REGIS N. SOTTO
 CITY MAYOR

SHEET NO.:
E
 1773


EXISTING LIGHTING LAYOUT
 CONFORME & ACCEPTED BY:
 CONTRACTOR


1. IN ALL DRAWINGS, THE CONTRACTOR SHALL BE RESPONSIBLE FOR THE PROVISION OF ALL MATERIALS AND LABORERS.
 2. IN ALL DRAWINGS, THE CONTRACTOR SHALL BE RESPONSIBLE FOR THE PROVISION OF ALL MATERIALS AND LABORERS.
 3. THE CONTRACTOR SHALL BE RESPONSIBLE FOR THE PROVISION OF ALL MATERIALS AND LABORERS.
 4. THE CONTRACTOR SHALL BE RESPONSIBLE FOR THE PROVISION OF ALL MATERIALS AND LABORERS.

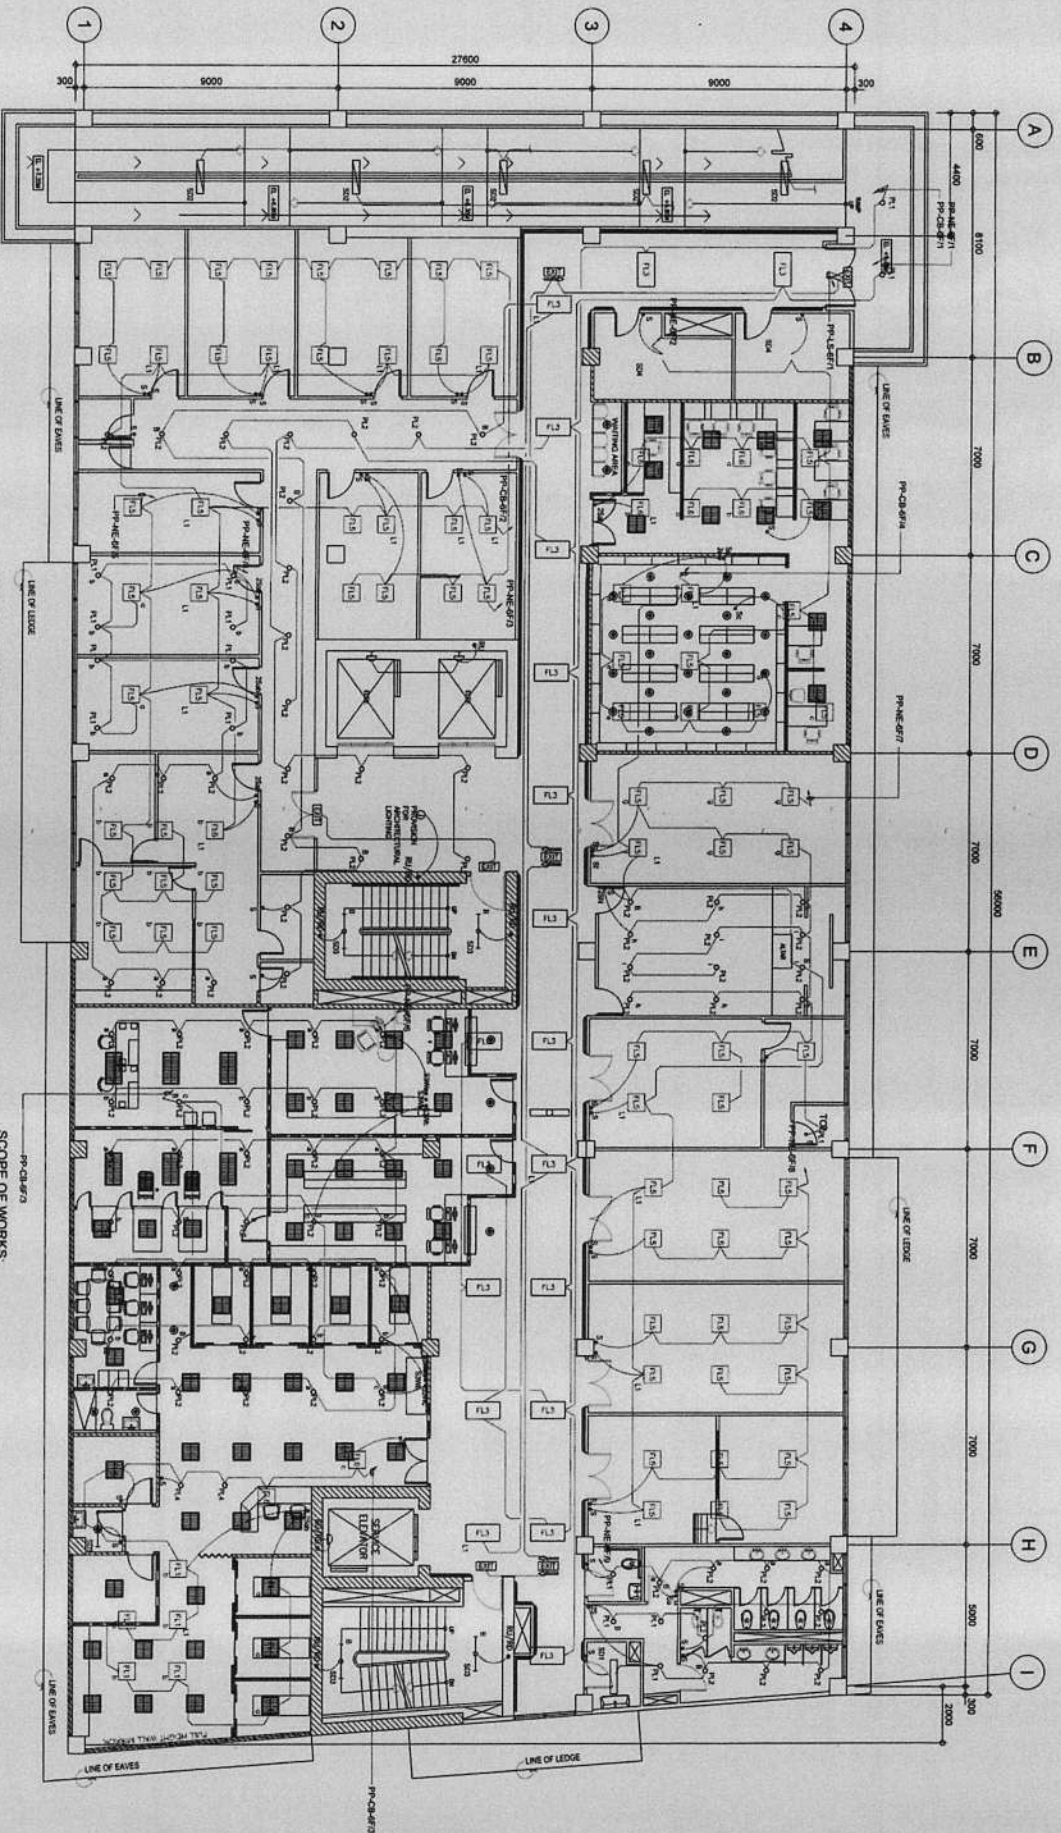

PROPOSED LAYOUT FOR REPAIR WORKS
SIXTH FLOOR LIGHTING LAYOUT

- SCOPE OF WORKS:
1. Installation of Lighting Fixtures Tapped to existing Panels.

 <p>REPUBLIC OF THE PHILIPPINES CITY OF PASIG</p>		<p>PROJECT TITLE: PROPOSED EXPANSION WITH IMPROVEMENT WORKS AT PASIG CITY CHILDREN'S HOSPITAL</p>	
<p>OFFICE OF THE MAYOR CITY ENGINEERING OFFICE</p>		<p>PROJECT IN CHARGE: ENGR. DANIEL B. BENEDECTO C. SOLONKON ENGR. ESPERIDO P. PARRUCIA JR. ENGR. JOHN T. CORTES</p>	
<p>LOCATION: INDUSTRIAL ZONE, N. CALIPE, JOSE STS.</p>		<p>PROGRAMMING AND CONSTRUCTION: ENGR. JORGE L. TIZON OIC, ELECTRICAL ENGINEERING DIVISION</p>	
<p>1. NO. 1. VERIFY THAT ALL MATERIALS AND SERVICES PROVIDED SHALL BE AS PER THE SPECIFICATIONS AND APPROVED BY THE ARCHITECT AND THE ENGINEER.</p> <p>2. IF ANY CASE OF CONFLICT BETWEEN THE SPECIFICATIONS AND APPROVED BY THE ARCHITECT AND THE ENGINEER, THE ENGINEER SHALL BE SOLELY RESPONSIBLE.</p>		<p>RECOMMENDING APPROVAL: ENGR. CAMARINE B. PRUDENCIO OIC, CITY ENGINEERING OFFICE</p>	
<p>3. NO. 2. VERIFY THAT THE CONSTRUCTION SHALL BE IN ACCORDANCE WITH THE SPECIFICATIONS AND APPROVED BY THE ARCHITECT AND THE ENGINEER.</p> <p>4. NO. 3. VERIFY THAT THE CONSTRUCTION SHALL BE IN ACCORDANCE WITH THE SPECIFICATIONS AND APPROVED BY THE ARCHITECT AND THE ENGINEER.</p>		<p>APPROVED BY: VICTOR MA. REGIS N. SOTTO CITY MAYOR</p>	
<p>CONTRACTOR</p>		<p>SHEET NO.: E 1873</p>	

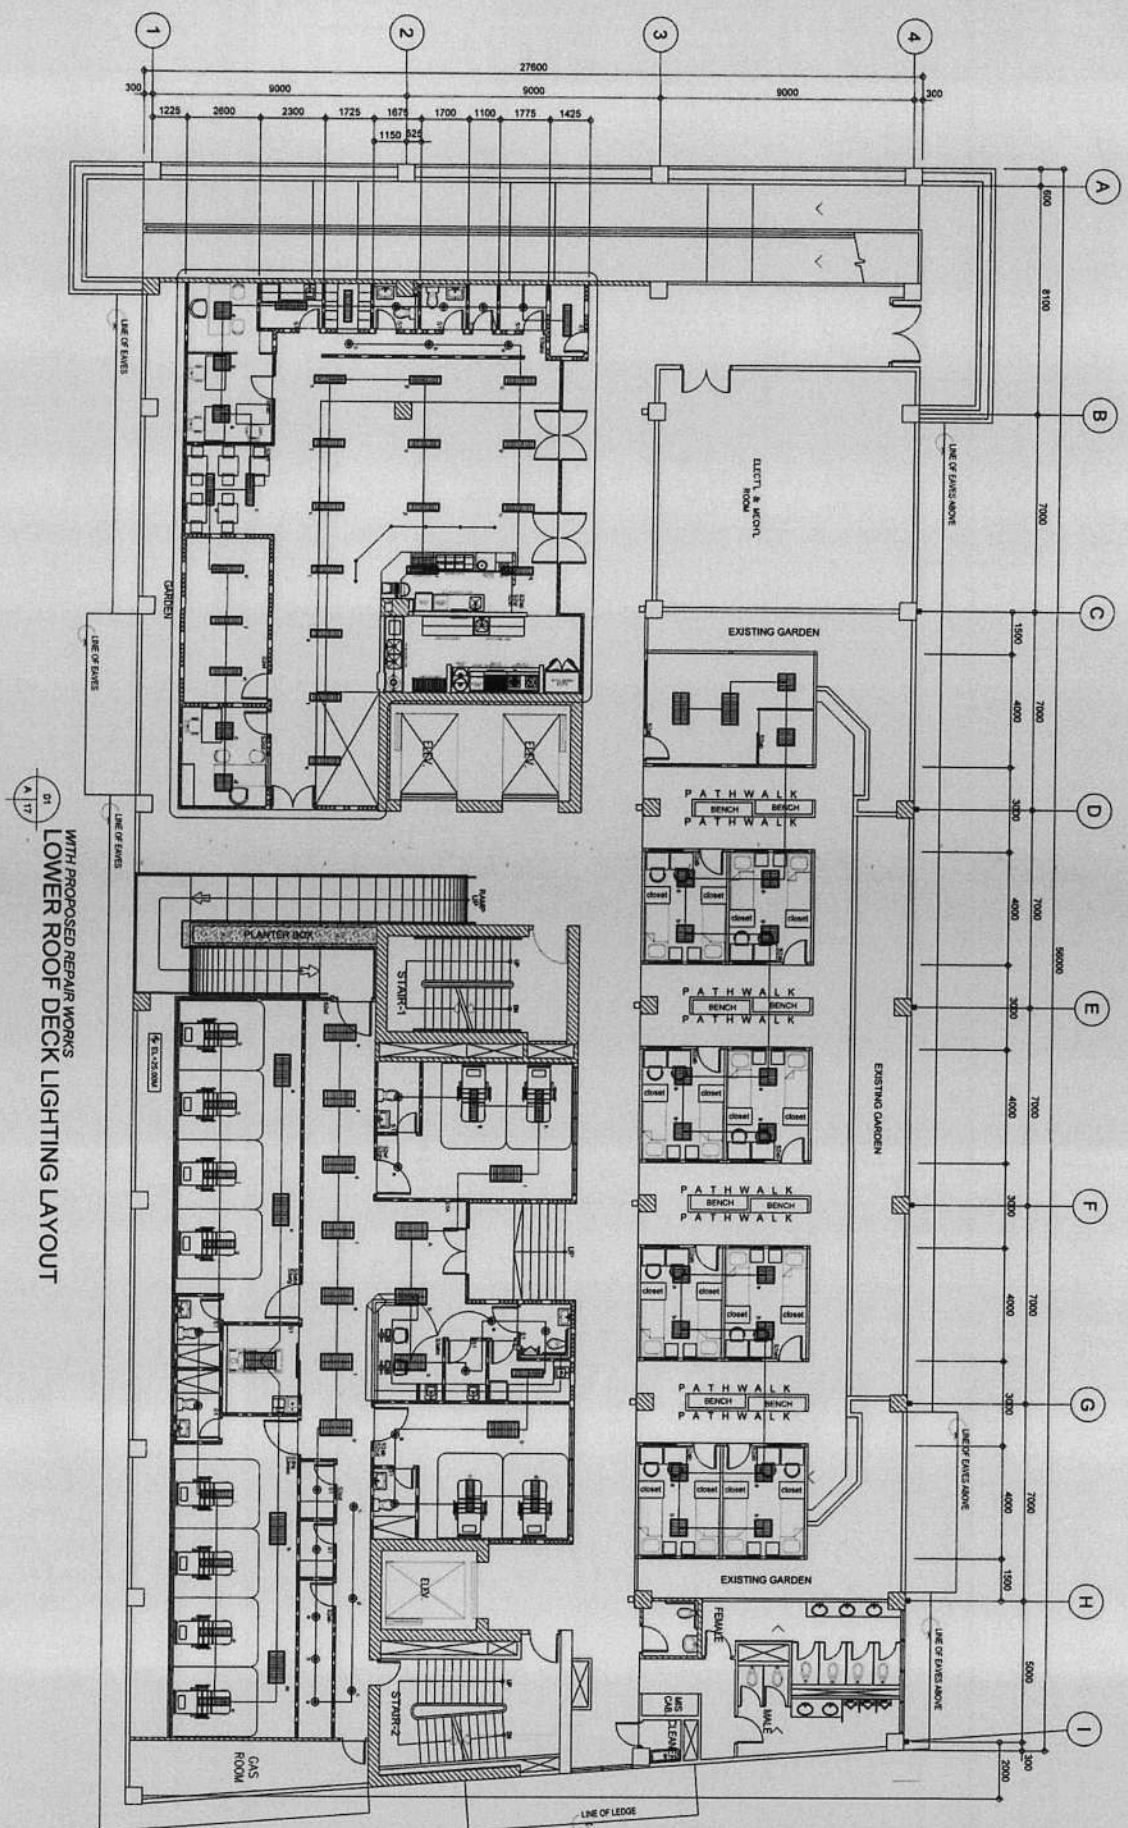


WITH PROPOSED REPAIR WORKS
LOWER ROOF DECK LIGHTING LAYOUT

<p>REPUBLIC OF THE PHILIPPINES CITY OF PASIG OFFICE OF THE MAYOR CITY ENGINEERING OFFICE</p>	<p>PROJECT TITLE: PROPOSED EXPANSION AND IMPROVEMENT WORKS AT PASIG CITY CHILDREN'S HOSPITAL</p>	<p>PROJECT IN CHARGE: ENGR. CHARLES S. SOLOMON</p>	<p>PROGRAMMING AND CONSTRUCTION: ENGR. JOSE L. TIZON</p>	<p>RECOMMENDING APPROVAL: ENGR. ANTHONY P. RUENDICO</p>	<p>APPROVED BY: VICTOR MA. REGIS N. SOTTO CITY MAYOR</p>	<p>SHEET CONTENT: PROPOSED LIGHTING LAYOUT</p>	<p>SHEET NO.: 1973</p>
	<p>LOCATION: INDUSTRIAL COR. ALBUQUE. JOSE STS. PASIG CITY</p>	<p>ENGR. EDUARDO C. BARBUZA, JR.</p>	<p>ENGR. JOHN JESSICA T. COITES</p>	<p>ENGR. JOHN JESSICA T. COITES</p>	<p>ENGR. ANTHONY P. RUENDICO CITY ENGINEERING OFFICE</p>	<p>CONFORME & ACCEPTED BY: 1973</p>	<p>CONTRACTOR</p>

IMPORTANT NOTES:

1. FOR INFORMATION AND RECORD PURPOSES, THE CONTRACTOR SHALL VERIFY THE EXISTING LIGHTING LAYOUT AND PROVIDE A COPY OF THE SAME TO THE CITY ENGINEERING OFFICE.
2. THE CONTRACTOR SHALL VERIFY THE EXISTING LIGHTING LAYOUT AND PROVIDE A COPY OF THE SAME TO THE CITY ENGINEERING OFFICE.
3. THE CONTRACTOR SHALL VERIFY THE EXISTING LIGHTING LAYOUT AND PROVIDE A COPY OF THE SAME TO THE CITY ENGINEERING OFFICE.
4. THE CONTRACTOR SHALL VERIFY THE EXISTING LIGHTING LAYOUT AND PROVIDE A COPY OF THE SAME TO THE CITY ENGINEERING OFFICE.
5. THE CONTRACTOR SHALL VERIFY THE EXISTING LIGHTING LAYOUT AND PROVIDE A COPY OF THE SAME TO THE CITY ENGINEERING OFFICE.
6. THE CONTRACTOR SHALL VERIFY THE EXISTING LIGHTING LAYOUT AND PROVIDE A COPY OF THE SAME TO THE CITY ENGINEERING OFFICE.

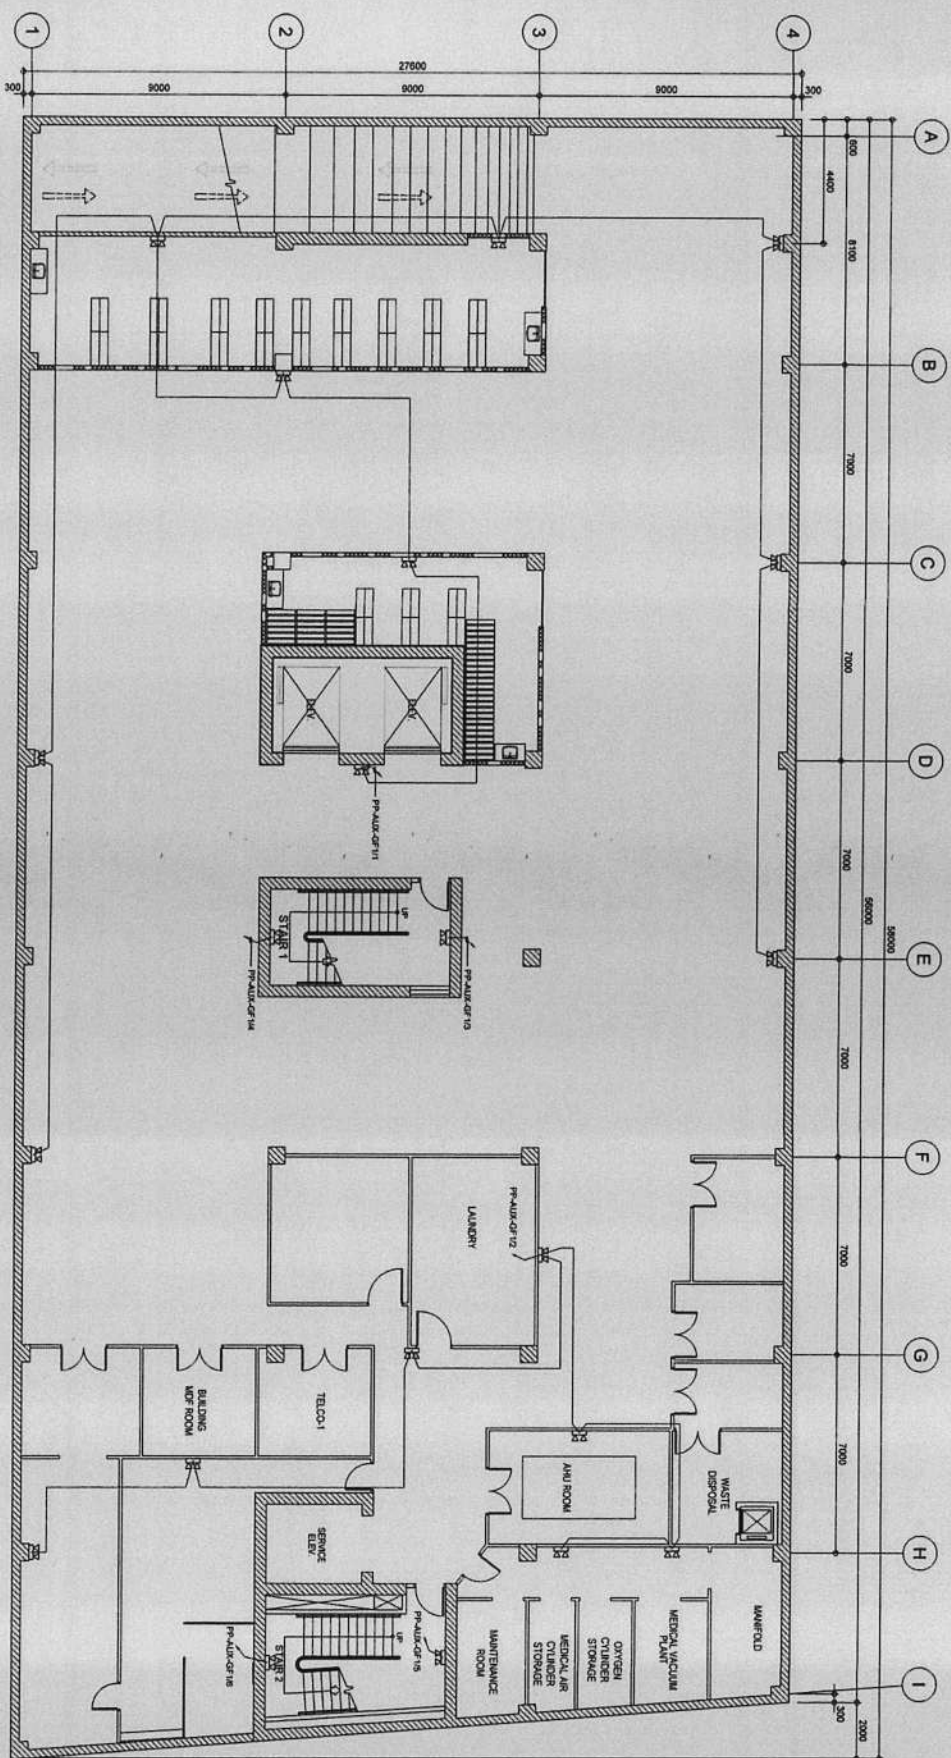


PROPOSED REPAIR WORKS
BASEMENT EMERGENCY LIGHT LAYOUT
 01
 A I
 SCALE
 1:100 MM

- SCOPE OF WORKS:
1. Installation of Emergency Lights
 2. Tapped the electrical supply of Emergency Lights to the existing Panelboards.
 3. Use IMC pipe for conduit homerun.

	REPUBLIC OF THE PHILIPPINES CITY OF PASIG	PROJECT TITLE: PROPOSED EXPANSION W/ IMPROVEMENT WORKS AT PASIG CITY CHILDREN'S HOSPITAL	PROJECT IN CHARGE: ENGR. CHRISTOPHER BENEDICT C. SOLOMON	PROGRAMMING AND CONSTRUCTION: ENGR. JORGE L. TIZON	RECOMMENDING APPROVAL: ENGR. JUAN ESPRUDENCIO	APPROVED BY: VICTOR MA. REGIS N. SOTTO CITY MAYOR	SHEET CONTENT: EMERGENCY LIGHT LAYOUT	SHEET NO. E 2073
	CITY ENGINEERING OFFICE	LOCATION: INDUSTRIAL COR. ALCIQUE JOSE STS. PASIG CITY	ENGR. ENRIQUE G. BARRERA JR. ENGR. JOHN DEYUMA T. CORTES	ENGR. CAROL BELLA	ENGR. JUAN ESPRUDENCIO	ENGR. ARTAÑANES V. GERONIMO DEC. CITY ENGINEERING OFFICE	CONFORME & ACCEPTED BY: CONTRACTOR	

IMPORTANT NOTES:


1. NO. 14 UTILITIES IN THE AREA AND ALL UTILITIES SHALL BE MAINTAINED AND PROTECTED AT ALL TIMES.
2. ALL WORK SHALL BE DONE IN ACCORDANCE WITH THE LATEST EDITIONS OF THE NATIONAL ELECTRICAL CODE AND THE NATIONAL MECHANICAL CODE.
3. IN CASE OF DISCREPANCY IN THE DRAWINGS, THE LATTER SHALL BE SUBMITTED IMMEDIATELY TO THE ARCHITECT FOR HIS REVIEW AND APPROVAL.
4. THE CONTRACTOR SHALL BE RESPONSIBLE FOR THE PROTECTION OF ALL UTILITIES AND STRUCTURES IN THE AREA.

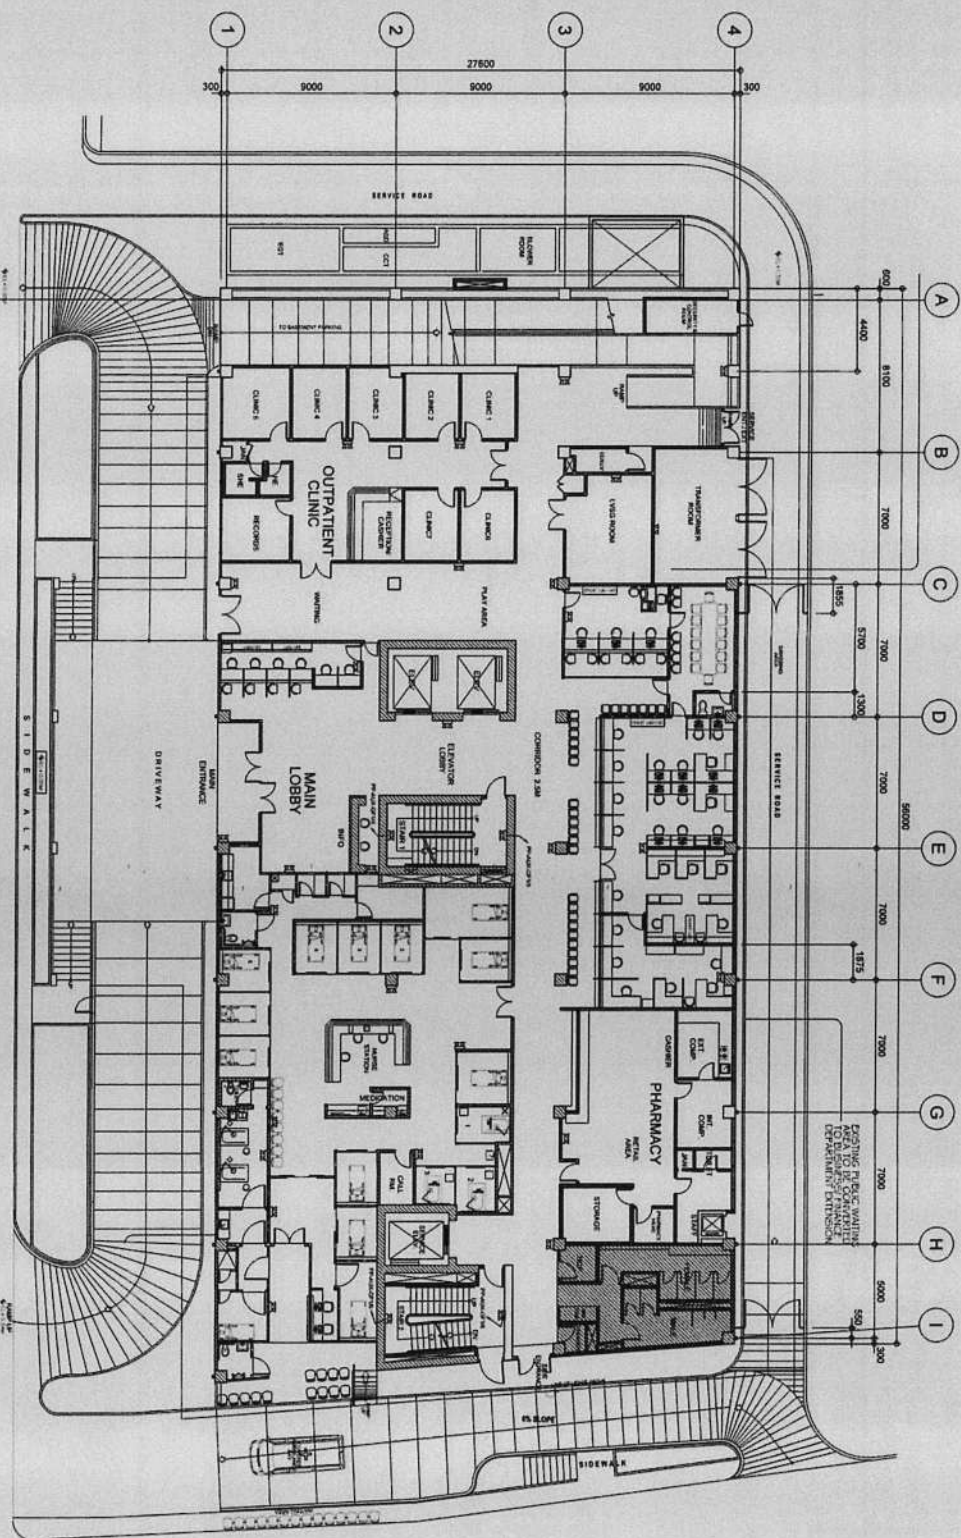

PROPOSED REPAIR WORKS
GROUND FLOOR EMERGENCY LIGHT LAYOUT
SCALE 1:150 N.M.

- SCOPE OF WORKS:
1. Installation of Emergency Lights
 2. Tapped the electrical supply of Emergency Lights to the existing Panelboards.
 3. Use IMC pipe for conduit homerun.

<p>REPUBLIC OF THE PHILIPPINES CITY OF PASIG OFFICE OF THE MAYOR CITY ENGINEERING OFFICE</p>		<p>PROJECT TITLE: PROPOSED EXPANSION W/ IMPROVEMENT WORKS AT PASIG CITY CHILDREN'S HOSPITAL</p> <p>LOCATION: INDUSTRIA COR ALICAYE JOSE STS. INDUSTRIA, PASIG CITY</p>		<p>PROJECT IN CHARGE: ENGR. CHRISTOPHER S. SOLOMON</p>		<p>PROGRAMMING AND CONSTRUCTION: ENGR. JORGE L. TIZON O.I.C. ELECTRICAL MANUFACTURING SECTION</p>		<p>RECOMMENDING APPROVAL: ENGR. LAURENCE B. PRUDENCIO</p>		<p>APPROVED BY: VICTOR MA. REGIS N. SOTTO CITY MAYOR</p>		<p>SHEET CONT'D: EMERGENCY LIGHT LAYOUT</p>		<p>SHEET NO.: E 2173</p>	
<p>IMPORTANT NOTES:</p> <p>1. NO ALTERATION IN SCALE & SPECIFICATIONS SHALL BE MADE WITHOUT THE PRIOR APPROVAL OF THE DESIGNER AND ENGINEER.</p> <p>2. IF ANY CHANGE IN THE CONSTRUCTION METHOD IS TO BE MADE, THE CONTRACTOR SHALL BE RESPONSIBLE FOR THE SAME.</p> <p>3. TO THE EXTENT POSSIBLE, THE CONTRACTOR SHALL BE RESPONSIBLE FOR THE PROTECTION OF ALL UTILITIES AND STRUCTURES TO REMAIN.</p> <p>4. CONSTRUCTION OF THIS PROJECT SHALL BE COMPLETED AT THE DISCRETION OF THE ENGINEER WHO SHALL BE RESPONSIBLE FOR THE PROJECT.</p>												<p>CONTRACTOR & ACCEPTED BY: CONTRACTOR</p>			

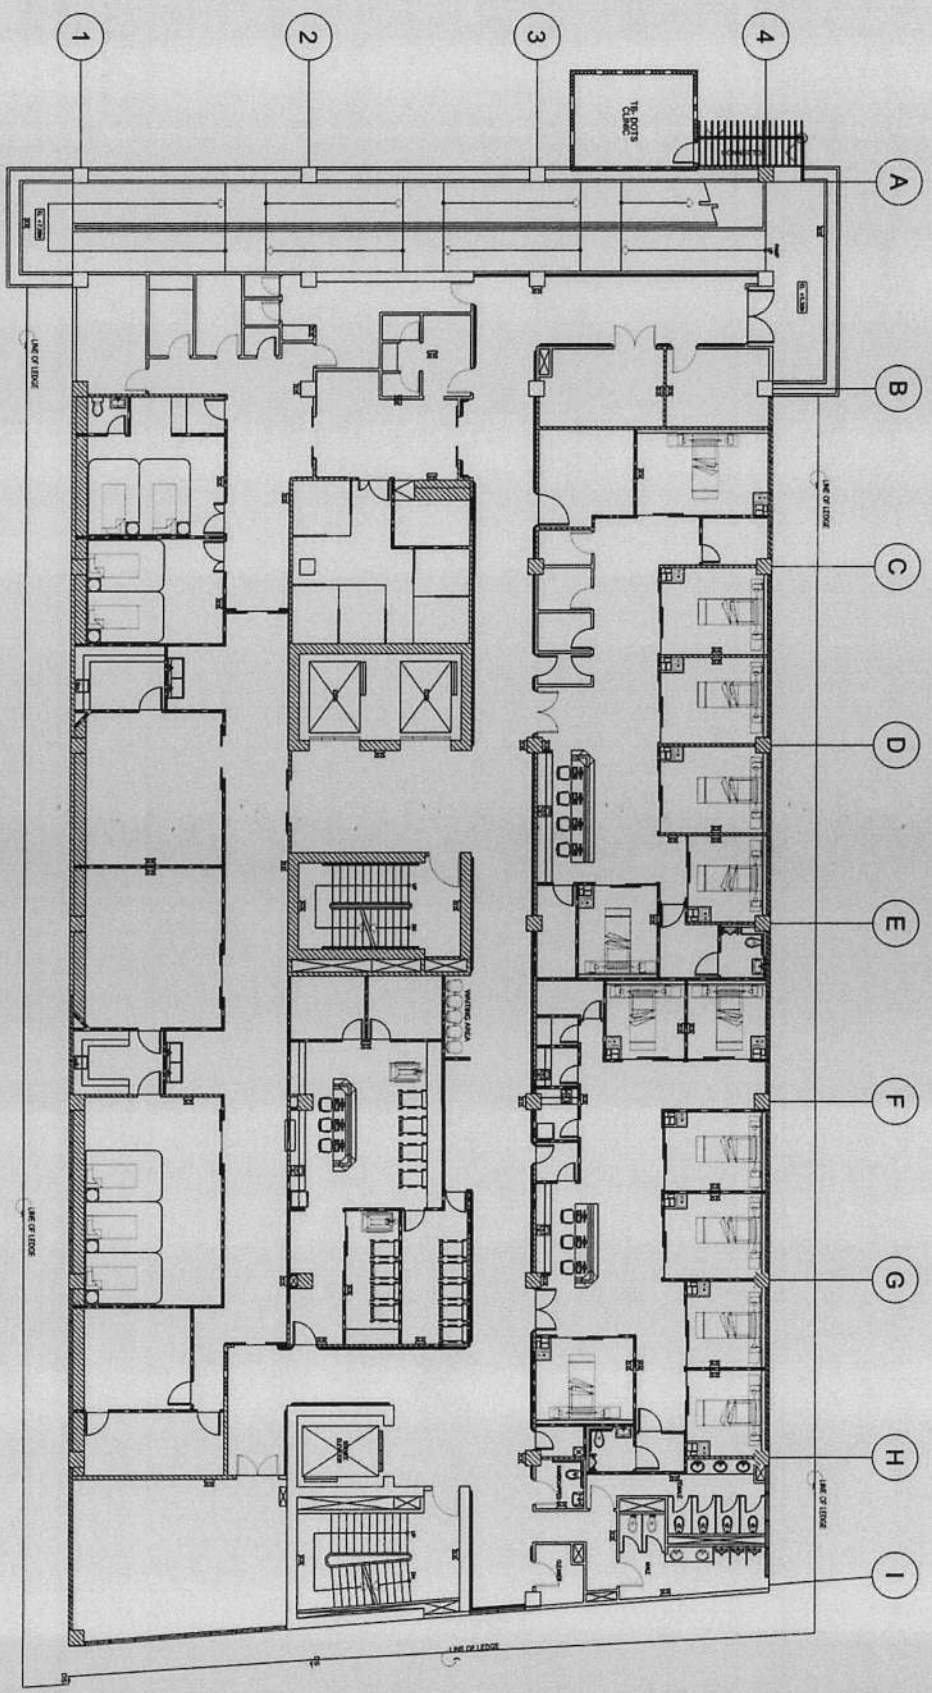

WITH PROPOSED REPAIR WORKS
 SECOND FLOOR EMERGENCY LIGHT LAYOUT
 1" = 16' SCALE


- SCOPE OF WORKS:
1. Installation of Emergency Lights
 2. Tapped the electrical supply of Emergency Lights to the existing Panelboards.
 3. Use IMC pipe for conduit homerun.

	REPUBLIC OF THE PHILIPPINES CITY OF PASIG OFFICE OF THE MAYOR CITY ENGINEERING OFFICE	PROJECT TITLE PROPOSED EXPANSION W/ IMPROVEMENT WORKS AT PASIG CITY CHILDREN'S HOSPITAL	PROJECT IN CHARGE ENGR. CHRISTOPHER EDICT C. SOLICON ENGR. EDUARDO G. BARRUDA JR. ENGR. JOHN JESUALD I. CORTES	PROGRAMMING AND CONSTRUCTION ENGR. CHERYL BELIN ENGR. JORGE L. TIZON O.I.C. ELECTRICAL ADMINISTRATION SECTION	RECOMMENDING APPROVAL ENGR. PRUDENCIO B. PRUDENCIO O.I.C. ELECTRICAL ADMINISTRATION SECTION	APPROVED BY ENGR. VICTOR M.A. REGIS N. SOTTO O.I.C. CITY ENGINEERING OFFICE	SHEET CONTENT EMERGENCY LIGHT LAYOUT	SHEET NO. E 2273
	PROJECT LOCATION INDUSTRIAL CORP. ALCADE JOSE STS. PASIG CITY, METRO MANILA	PROJECT NO.	PROJECT DATE	PROJECT STATUS	PROJECT PHASE	PROJECT BUDGET	PROJECT OWNER	PROJECT CONTRACTOR

IMPORTANT NOTES:


1. THE CONTRACTOR SHALL BE RESPONSIBLE FOR OBTAINING ALL NECESSARY PERMITS AND APPROVALS FROM THE APPROPRIATE AGENCIES AND AUTHORITIES.
2. THE CONTRACTOR SHALL BE RESPONSIBLE FOR OBTAINING ALL NECESSARY PERMITS AND APPROVALS FROM THE APPROPRIATE AGENCIES AND AUTHORITIES.
3. THE CONTRACTOR SHALL BE RESPONSIBLE FOR OBTAINING ALL NECESSARY PERMITS AND APPROVALS FROM THE APPROPRIATE AGENCIES AND AUTHORITIES.
4. THE CONTRACTOR SHALL BE RESPONSIBLE FOR OBTAINING ALL NECESSARY PERMITS AND APPROVALS FROM THE APPROPRIATE AGENCIES AND AUTHORITIES.
5. THE CONTRACTOR SHALL BE RESPONSIBLE FOR OBTAINING ALL NECESSARY PERMITS AND APPROVALS FROM THE APPROPRIATE AGENCIES AND AUTHORITIES.
6. THE CONTRACTOR SHALL BE RESPONSIBLE FOR OBTAINING ALL NECESSARY PERMITS AND APPROVALS FROM THE APPROPRIATE AGENCIES AND AUTHORITIES.


CONTRACTOR

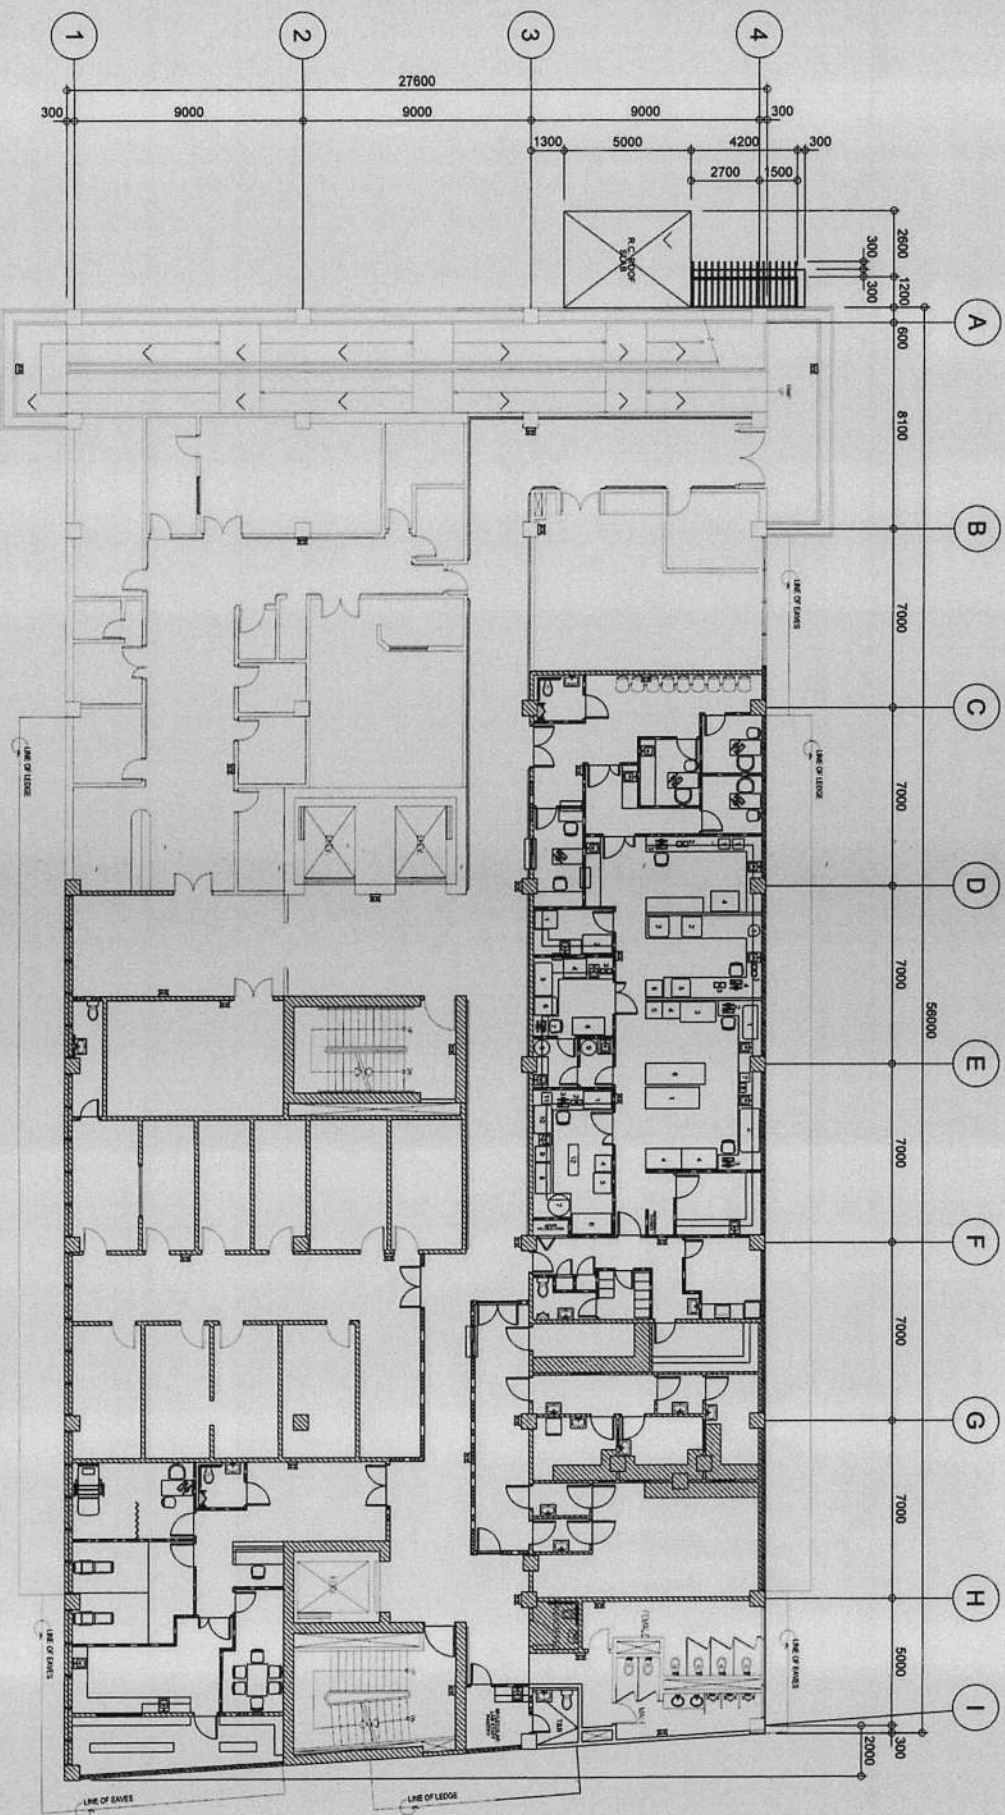

PROPOSED REPAIR WORKS
 THIRD FLOOR EMERGENCY LIGHT LAYOUT
 1:150 MM
 SCALE

- SCOPE OF WORKS:
1. Installation of Emergency Lights
 2. Tapped the electrical supply of Emergency Lights to the existing Panelboards.
 3. Use IMC pipe for conduit homerun.

 REPUBLIC OF THE PHILIPPINES CITY OF PASIG OFFICE OF THE MAYOR CITY ENGINEERING OFFICE	PROJECT TITLE: PROPOSED EXPANSION W/ IMPROVEMENT WORKS AT PASIG CITY CHILDREN'S HOSPITAL	PROJECT IN CHARGE: ENGR. <i>Cherry Ann</i> DEBENECENT C. SOLOMON ENGR. EDUARDO G. BARRERA, JR. ENGR. JOHN JEREMIAH T. CORTES	PROGRAMMING AND CONSTRUCTION: ENGR. JORGE L. TIZON OIC, ELECTRICAL ENGINEERING SECTION	RECOMMENDING APPROVAL: ENGR. <i>Armando B. Prudencio</i> ENGR. ARTAVARDES V. GERONIMO OIC, CITY ENGINEERING OFFICE	APPROVED BY: VICTOR MA. REGIS N. SOTTO CITY MAYOR	SHEET CONTENT: EMERGENCY LIGHT LAYOUT	SHEET NO.: E 2373
	LOCATION: INDUSTRIAL CORAL ALCALDE JOSE STS. PASIG CITY	1. TO BE CONSIDERED AS PART OF THE PROJECT'S BUDGET. 2. CONTRACTOR SHALL BE RESPONSIBLE FOR THE SUPPLY AND INSTALLATION OF ALL MATERIALS. 3. TO BE CONSIDERED AS PART OF THE PROJECT'S BUDGET. 4. CONTRACTOR SHALL BE RESPONSIBLE FOR THE SUPPLY AND INSTALLATION OF ALL MATERIALS. 5. TO BE CONSIDERED AS PART OF THE PROJECT'S BUDGET. 6. CONTRACTOR SHALL BE RESPONSIBLE FOR THE SUPPLY AND INSTALLATION OF ALL MATERIALS.	CONTRACTOR & ACCEPTED BY: CONTRACTOR				

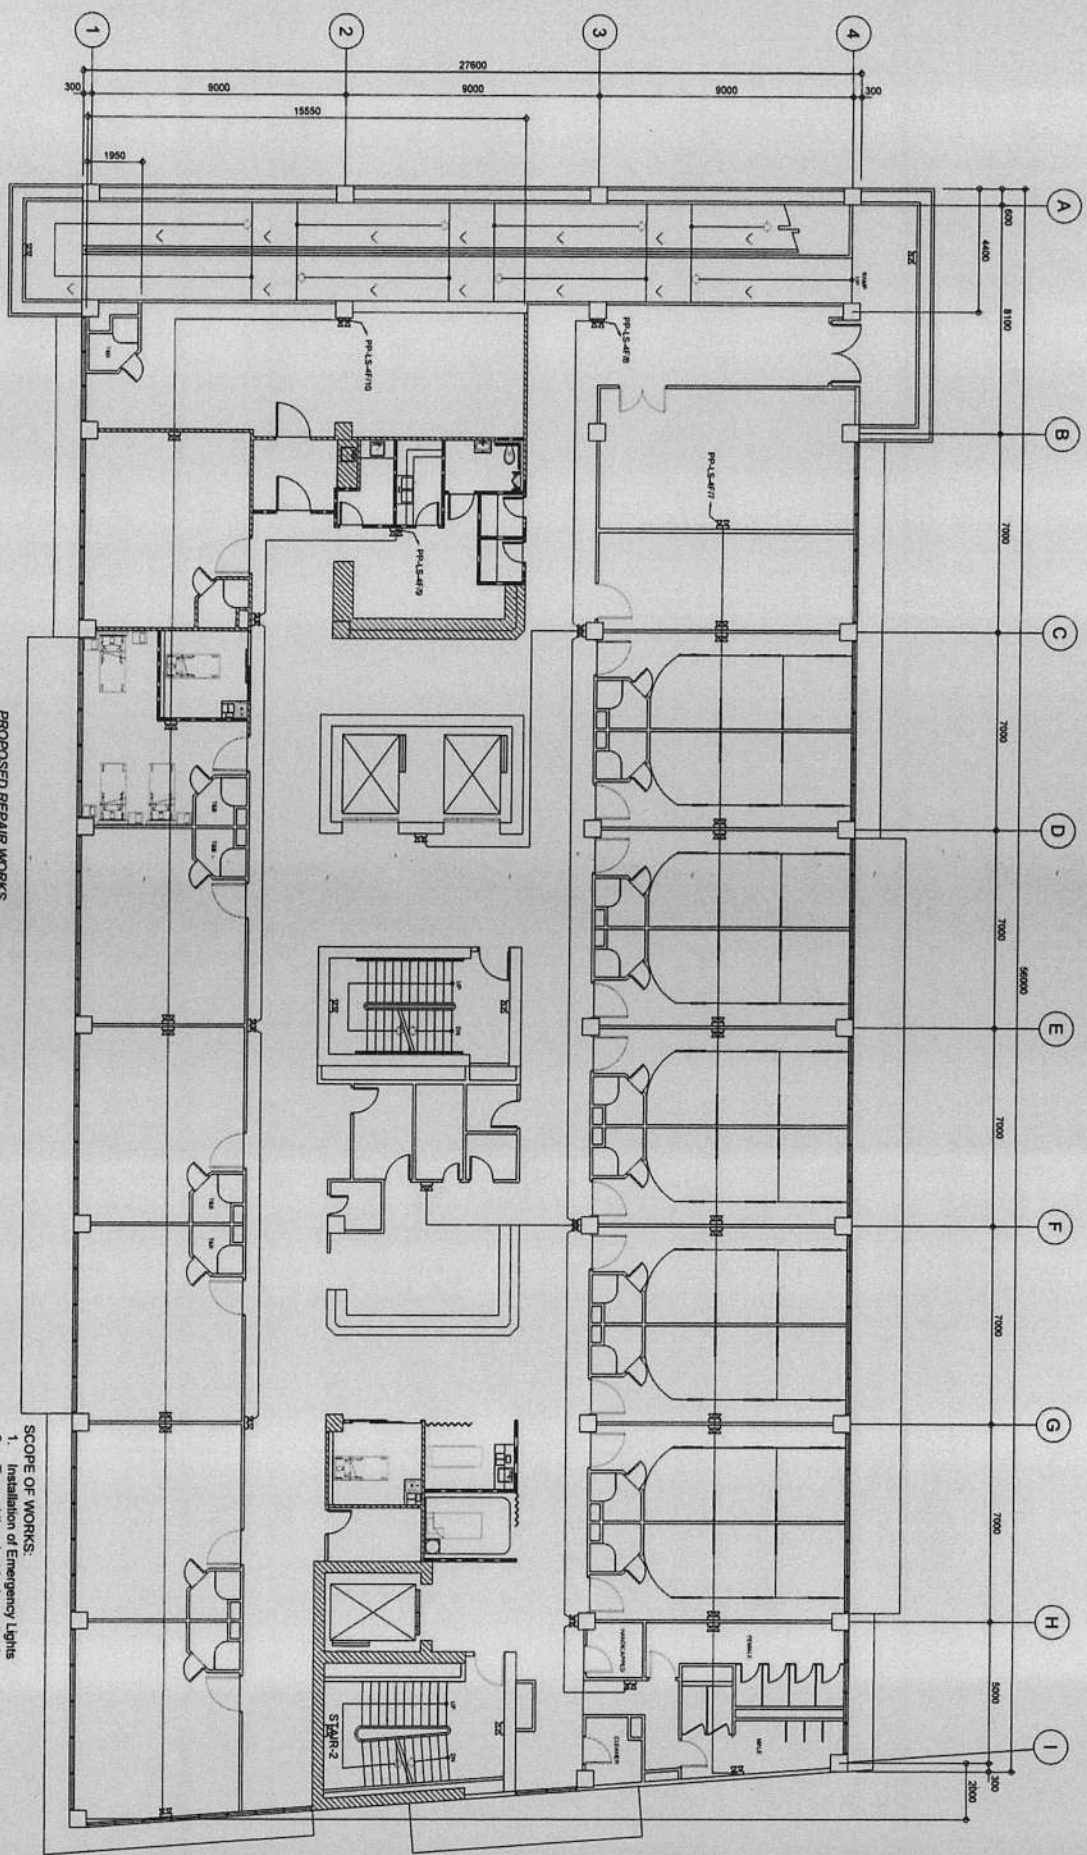


PROPOSED REPAIR WORKS
 FOURTH FLOOR EMERGENCY LIGHT LAYOUT
 1:150 SCALE

- SCOPE OF WORKS:
1. Installation of Emergency Lights
 2. Tapped the electrical supply of Emergency Lights to the nearest Power Circuit Breaker.
 3. Use IMC pipe for conduit homerun.

	REPUBLIC OF THE PHILIPPINES CITY OF PASIG OFFICE OF THE LAYOR CITY ENGINEERING OFFICE	PROJECT TITLE PROPOSED EXPANSION W/ IMPROVEMENT WORKS AT PASIG CITY CHILDREN'S HOSPITAL	PROJECT IN CHARGE ENGR. CHESTER DEVEDICT C. SOLIDUM ENGR. EDUARDO G. BARRERA, JR. ENGR. JOHN DELA CRUZ ENGR. CARLOS BELIN	PROGRAMMING AND CONSTRUCTION ENGR. JORGE L. TIZON OLC, ELECTRICAL INFRASTRUCTURE SECTION	RECOMMENDING APPROVAL ENGR. CARLOS PRUDENCIO ENGR. ARTAVERTES V. GERONIMO	APPROVED BY VICTOR MA. REGIS N. SOTTO CITY LAYOR	SHEET CONTENT EMERGENCY LIGHT LAYOUT	SHEET NO. E 2473
	PROJECT LOCATION INDUSTRIAL CORP. AL CALRE JOSE STS. PASIG CITY	PROJECT NO. 1. NO. 473/2019 IN LAYOR & SUPERVISOR'S SIGNATURE AND DATE 2. NO. 473/2019 IN LAYOR & SUPERVISOR'S SIGNATURE AND DATE 3. NO. 473/2019 IN LAYOR & SUPERVISOR'S SIGNATURE AND DATE 4. NO. 473/2019 IN LAYOR & SUPERVISOR'S SIGNATURE AND DATE	PROJECT NO. 1. NO. 473/2019 IN LAYOR & SUPERVISOR'S SIGNATURE AND DATE 2. NO. 473/2019 IN LAYOR & SUPERVISOR'S SIGNATURE AND DATE 3. NO. 473/2019 IN LAYOR & SUPERVISOR'S SIGNATURE AND DATE 4. NO. 473/2019 IN LAYOR & SUPERVISOR'S SIGNATURE AND DATE	PROJECT NO. 1. NO. 473/2019 IN LAYOR & SUPERVISOR'S SIGNATURE AND DATE 2. NO. 473/2019 IN LAYOR & SUPERVISOR'S SIGNATURE AND DATE 3. NO. 473/2019 IN LAYOR & SUPERVISOR'S SIGNATURE AND DATE 4. NO. 473/2019 IN LAYOR & SUPERVISOR'S SIGNATURE AND DATE	PROJECT NO. 1. NO. 473/2019 IN LAYOR & SUPERVISOR'S SIGNATURE AND DATE 2. NO. 473/2019 IN LAYOR & SUPERVISOR'S SIGNATURE AND DATE 3. NO. 473/2019 IN LAYOR & SUPERVISOR'S SIGNATURE AND DATE 4. NO. 473/2019 IN LAYOR & SUPERVISOR'S SIGNATURE AND DATE	PROJECT NO. 1. NO. 473/2019 IN LAYOR & SUPERVISOR'S SIGNATURE AND DATE 2. NO. 473/2019 IN LAYOR & SUPERVISOR'S SIGNATURE AND DATE 3. NO. 473/2019 IN LAYOR & SUPERVISOR'S SIGNATURE AND DATE 4. NO. 473/2019 IN LAYOR & SUPERVISOR'S SIGNATURE AND DATE	PROJECT NO. 1. NO. 473/2019 IN LAYOR & SUPERVISOR'S SIGNATURE AND DATE 2. NO. 473/2019 IN LAYOR & SUPERVISOR'S SIGNATURE AND DATE 3. NO. 473/2019 IN LAYOR & SUPERVISOR'S SIGNATURE AND DATE 4. NO. 473/2019 IN LAYOR & SUPERVISOR'S SIGNATURE AND DATE	PROJECT NO. 1. NO. 473/2019 IN LAYOR & SUPERVISOR'S SIGNATURE AND DATE 2. NO. 473/2019 IN LAYOR & SUPERVISOR'S SIGNATURE AND DATE 3. NO. 473/2019 IN LAYOR & SUPERVISOR'S SIGNATURE AND DATE 4. NO. 473/2019 IN LAYOR & SUPERVISOR'S SIGNATURE AND DATE

CONTRACTOR

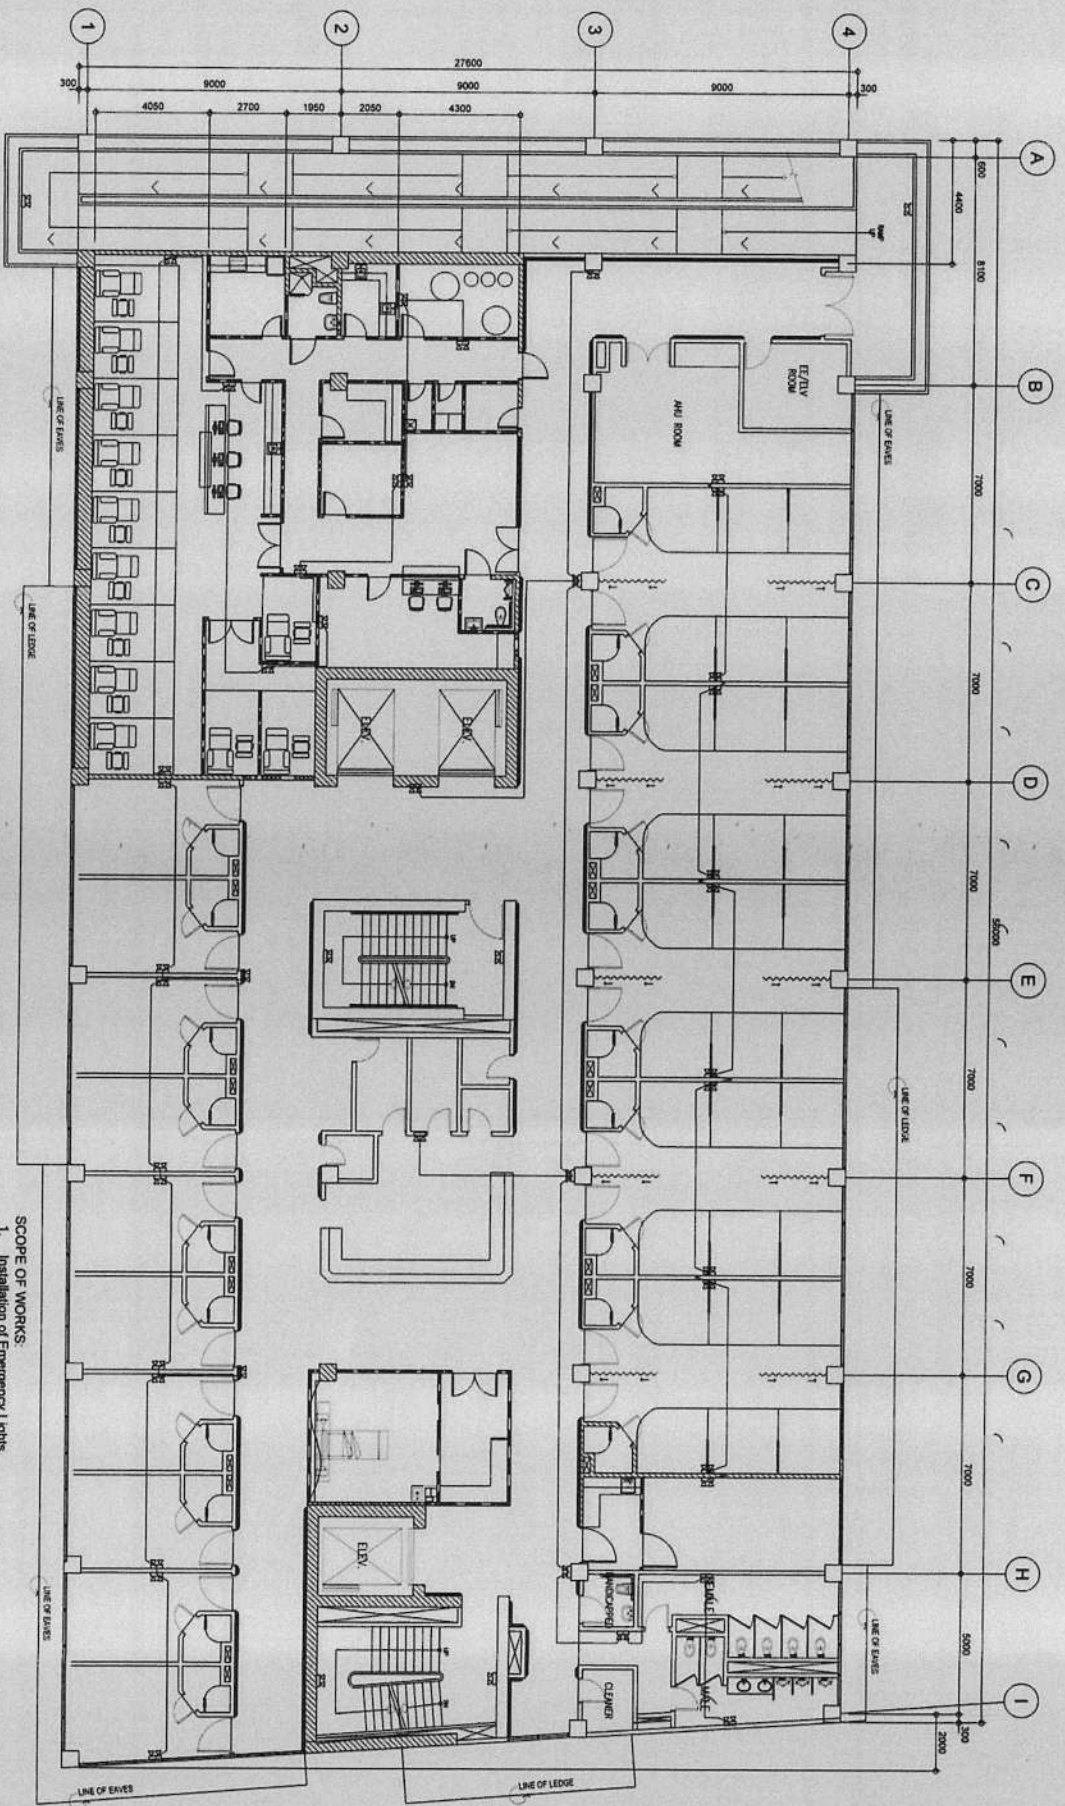


PROPOSED LAYOUT FOR REPAIR WORKS
 FIFTH FLOOR EMERGENCY LIGHT LAYOUT

- SCOPE OF WORKS:
1. Installation of Emergency Lights
 2. Tapped the electrical supply of Emergency Lights to the existing Panels.
 3. Use IMC pipe for conduit homerun.

		REPUBLIC OF THE PHILIPPINES CITY OF PASIG OFFICE OF THE MAYOR CITY ENGINEERING OFFICE	PROJECT TITLE: PROPOSED EXPANSION W/ IMPROVEMENT WORKS AT PASIG CITY CHILDREN'S HOSPITAL	PROJECT IN CHARGE: ENGR. CHRISTOPHER BENJAMIN C. SOLONON ENGR. EDUARDO C. MANUBA, JR. ENGR. JOSEPH MANILA I. CORTES	PROGRAMMING AND CONSTRUCTION: ENGR. JORGE L. TIZON ENGR. LAURENCE S. BRUDENCIO	RECOMMENDING APPROVAL: ENGR. ARTAXERXES V. GERONIMO	APPROVED BY: VICTOR MA. REGIS N. SOTTO CITY MAYOR	SHEET CONTENT: EMERGENCY LIGHT LAYOUT	SHEET NO.:
IMPORTANT NOTES: 1. VERIFY THE EXISTING ELECTRICAL SYSTEM AND THE LOCATION OF THE ELECTRICAL PANELS AND CONDUITS BEFORE THE REPAIR WORKS. 2. VERIFY THE EXISTING ELECTRICAL SYSTEM AND THE LOCATION OF THE ELECTRICAL PANELS AND CONDUITS BEFORE THE REPAIR WORKS. 3. TO THE APPLICABLE CODES AND STANDARDS, THE WORK SHALL BE SUBJECT TO APPROVAL BY THE CITY ENGINEERING OFFICE. 4. CONSTRUCTION OF THIS REPAIR WORKS SHALL BE COMPLETED BY THE EXPIRE OF THE CONTRACT.		LOCATION: INDUSTRIAL COR. ALICAPUE JOSE SITE. PASIG CITY	ENGR. EDUARDO C. MANUBA, JR. ENGR. JOSEPH MANILA I. CORTES	ENGR. JORGE L. TIZON ENGR. LAURENCE S. BRUDENCIO	ENGR. ARTAXERXES V. GERONIMO CITY ENGINEERING OFFICE	APPROVED BY: VICTOR MA. REGIS N. SOTTO CITY MAYOR	SHEET CONTENT: EMERGENCY LIGHT LAYOUT	SHEET NO.: 	

CONFORME & ACCEPTED BY:
 CONTRACTOR

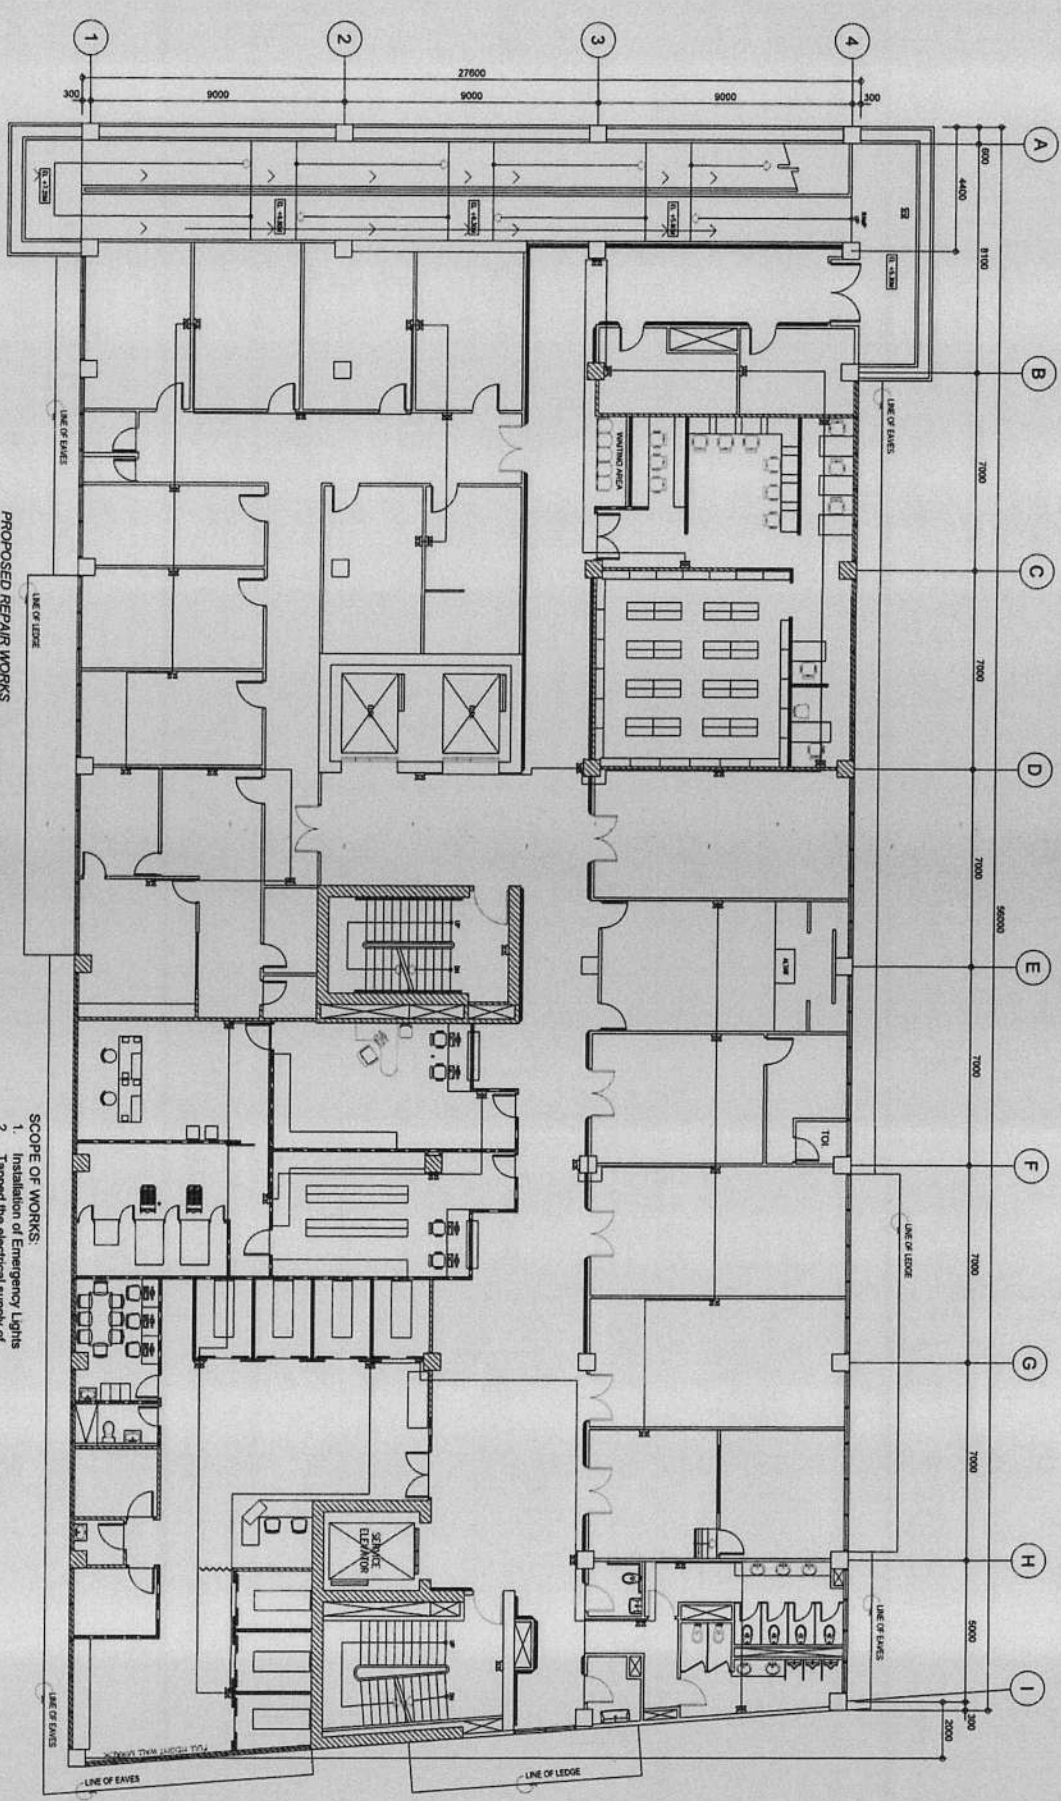


PROPOSED REPAIR WORKS
SIXTH FLOOR EMERGENCY LIGHT LAYOUT
SCALE 1:150

- SCOPE OF WORKS:
1. Installation of Emergency Lights
 2. Tapped the electrical supply of Emergency Lights to the existing Panelboards.
 3. Use IMC pipe for conduit homerun.

<p>REPUBLIC OF THE PHILIPPINES CITY OF PASIG OFFICE OF THE MAYOR CITY ENGINEERING OFFICE</p>	<p>PROJECT TITLE PROPOSED EXPANSION W/ IMPROVEMENT WORKS AT PASIG CITY CHILDREN'S HOSPITAL</p>	<p>PROJECT IN CHARGE ENGR. CHRISTOPHER BENEDICT C. SOLIDUM ENGR. CARLA L. BELIN ENGR. JORGE L. TIZON</p>	<p>PROGRAMMING AND CONSTRUCTION ENGR. CHRISTOPHER BENEDICT C. SOLIDUM ENGR. CARLA L. BELIN ENGR. JORGE L. TIZON</p>	<p>RECOMMENDING APPROVAL ENGR. CHRISTOPHER BENEDICT C. SOLIDUM ENGR. CARLA L. BELIN ENGR. JORGE L. TIZON</p>	<p>APPROVED BY VICTOR MA. REGIS N. SOTTO CITY MAYOR</p>	<p>SHEET CONTENT EMERGENCY LIGHT LAYOUT</p>	<p>SHEET NO. E 2673</p>
	<p>LOCATION MORNING STAR, ALDORE JOSE STS. MORNING STAR, ALDORE JOSE STS.</p>	<p>ENGR. EDUARDO B. BARRERA JR. ENGR. JOSE ANTONIO T. COATES</p>	<p>O.I.C. TECHNICAL SUPERVISOR SECTION</p>	<p>ENGR. CHRISTOPHER BENEDICT C. SOLIDUM ENGR. CARLA L. BELIN ENGR. JORGE L. TIZON</p>	<p>ENGR. CHRISTOPHER BENEDICT C. SOLIDUM ENGR. CARLA L. BELIN ENGR. JORGE L. TIZON</p>	<p>ENGR. CHRISTOPHER BENEDICT C. SOLIDUM ENGR. CARLA L. BELIN ENGR. JORGE L. TIZON</p>	<p>CONTRACTOR</p>

IMPORTANT NOTES:

1. TOTAL CONTRACTOR SHALL BE RESPONSIBLE FOR THE PROVISION OF THE DESCRIBED AND SPECIFIED MATERIALS.
2. IF IN ANY CASE THE CONTRACTOR HAS ANY QUESTIONS REGARDING THE SCOPE OF WORK, HE SHALL CONSULT WITH THE ARCHITECT AND THE ENGINEER BEFORE PROCEEDING WITH THE WORK.
3. TO THE EXTENT POSSIBLE, ALL WORK SHALL BE COMPLETED WITHIN THE SPECIFIED TIME FRAME.
4. THE CONTRACTOR SHALL BE RESPONSIBLE FOR THE PROVISION OF ALL NECESSARY PERMITS AND APPROVALS.
5. THE CONTRACTOR SHALL BE RESPONSIBLE FOR THE PROVISION OF ALL NECESSARY SAFETY MEASURES DURING THE COURSE OF THE WORK.
6. THE CONTRACTOR SHALL BE RESPONSIBLE FOR THE PROVISION OF ALL NECESSARY PROTECTIVE MEASURES TO THE EXISTING STRUCTURE AND UTILITIES.

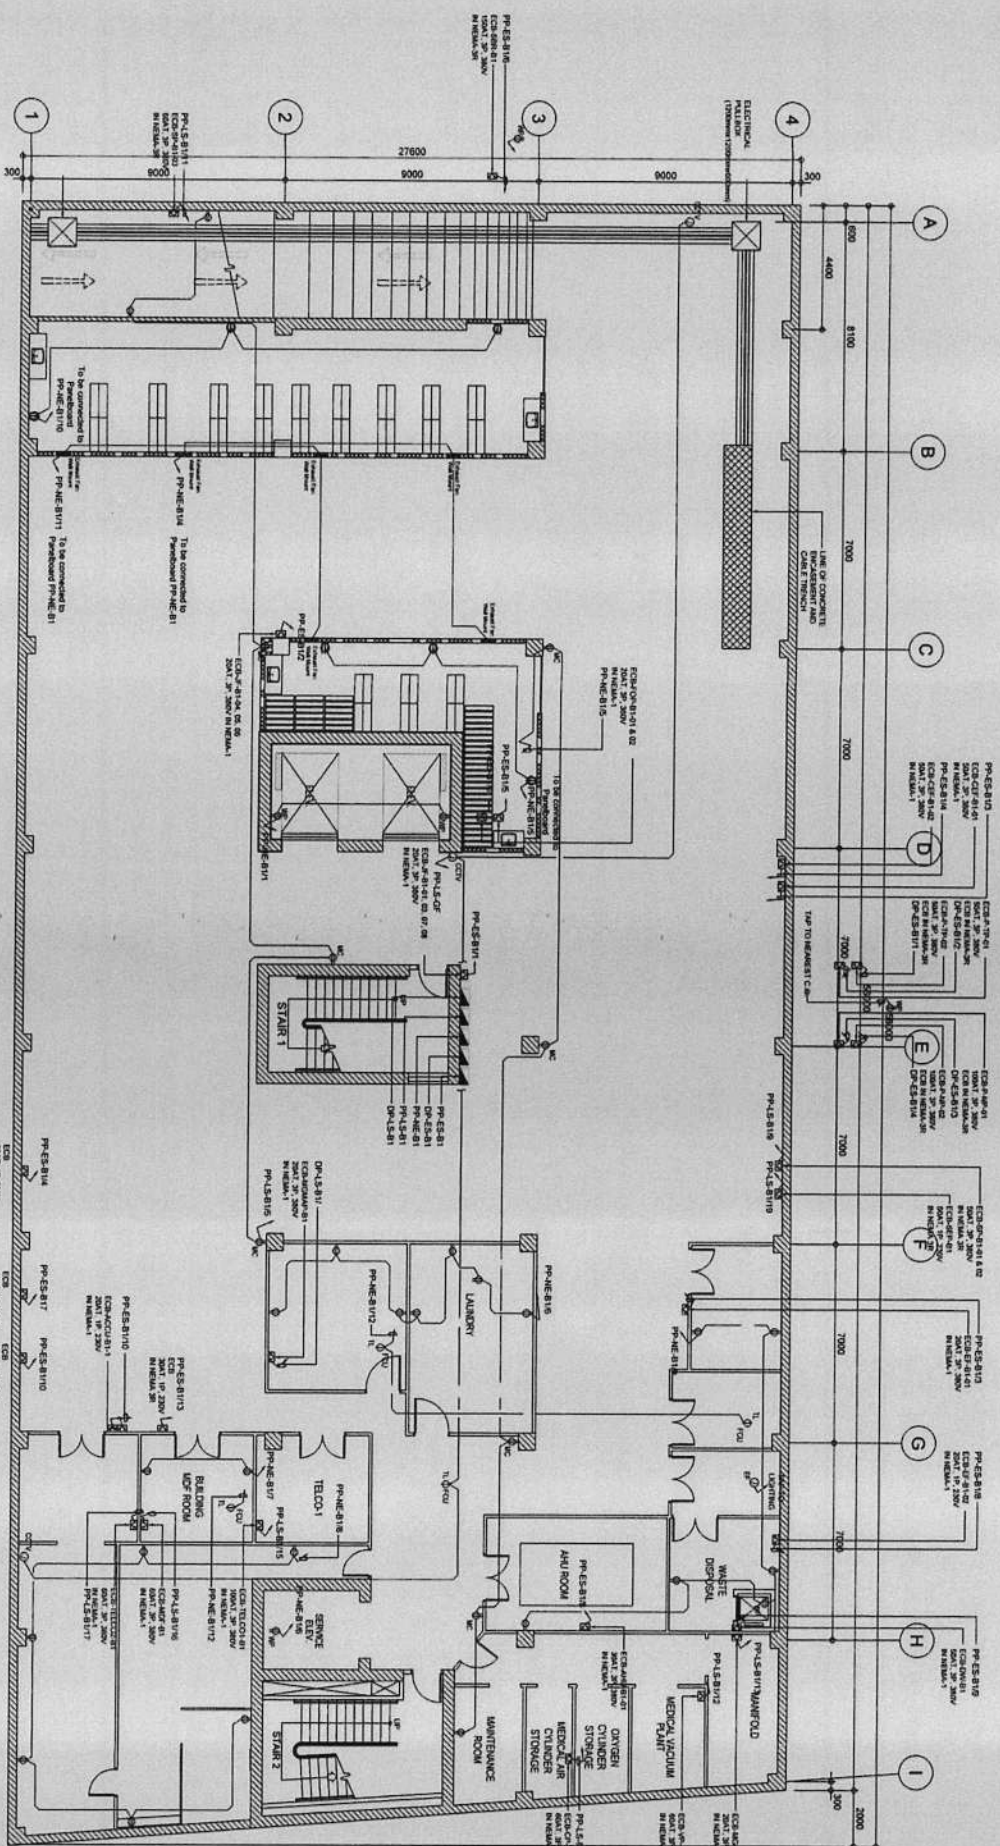


PROPOSED REPAIR WORKS
BASEMENT POWER LAYOUT
SCALE: 1:100 (1/8" = 1'-0")

	REPUBLIC OF THE PHILIPPINES CITY OF PASIG OFFICE OF THE MAYOR CITY ENGINEERING OFFICE	PROJECT TITLE: PROPOSED EXPANSION W/ IMPROVEMENT WORKS AT PASIG CITY CHILDREN'S HOSPITAL	PROJECT IN CHARGE: ENGR. CHRISTOPHER M. SOLIMON ENGR. CARVAL BELLA	PROGRAMMING AND CONSTRUCTION: ENGR. JORGE L. TIZON	RECOMMENDING APPROVAL: ENGR. ANTONIO S. PRUDENTICO ENGR. ARTAVERNES V. GERONIMO	APPROVED BY: VICTOR MA. REGIS N. SOTTO CITY MAYOR	SHEET CONTENT: POWER LAYOUT	SHEET NO.: E 2773
	PROJECT LOCATION: PASIG CITY CHILDREN'S HOSPITAL PASIG CITY, METRO MANILA	PROJECT NO.: PASIG-2018-001	DESIGNER: ENGR. JOSE S. SANTIAGO, JR. ENGR. JOSE M. T. CORTES	CHECKER: ENGR. JOSE M. T. CORTES	DATE OF SUBMISSION: 10/25/2018	DATE OF APPROVAL: 11/15/2018	CONTRACT NO.: PASIG-2018-001	CONTRACTOR: CONFORME & ACCEPTED BY:

REVISIONS:

- NO. 1: REVISION TO THE ELECTRICAL SYMBOLS AND DIMENSIONS.
- NO. 2: REVISION TO THE ELECTRICAL SYMBOLS AND DIMENSIONS.
- NO. 3: REVISION TO THE ELECTRICAL SYMBOLS AND DIMENSIONS.
- NO. 4: REVISION TO THE ELECTRICAL SYMBOLS AND DIMENSIONS.

CONTRACTOR

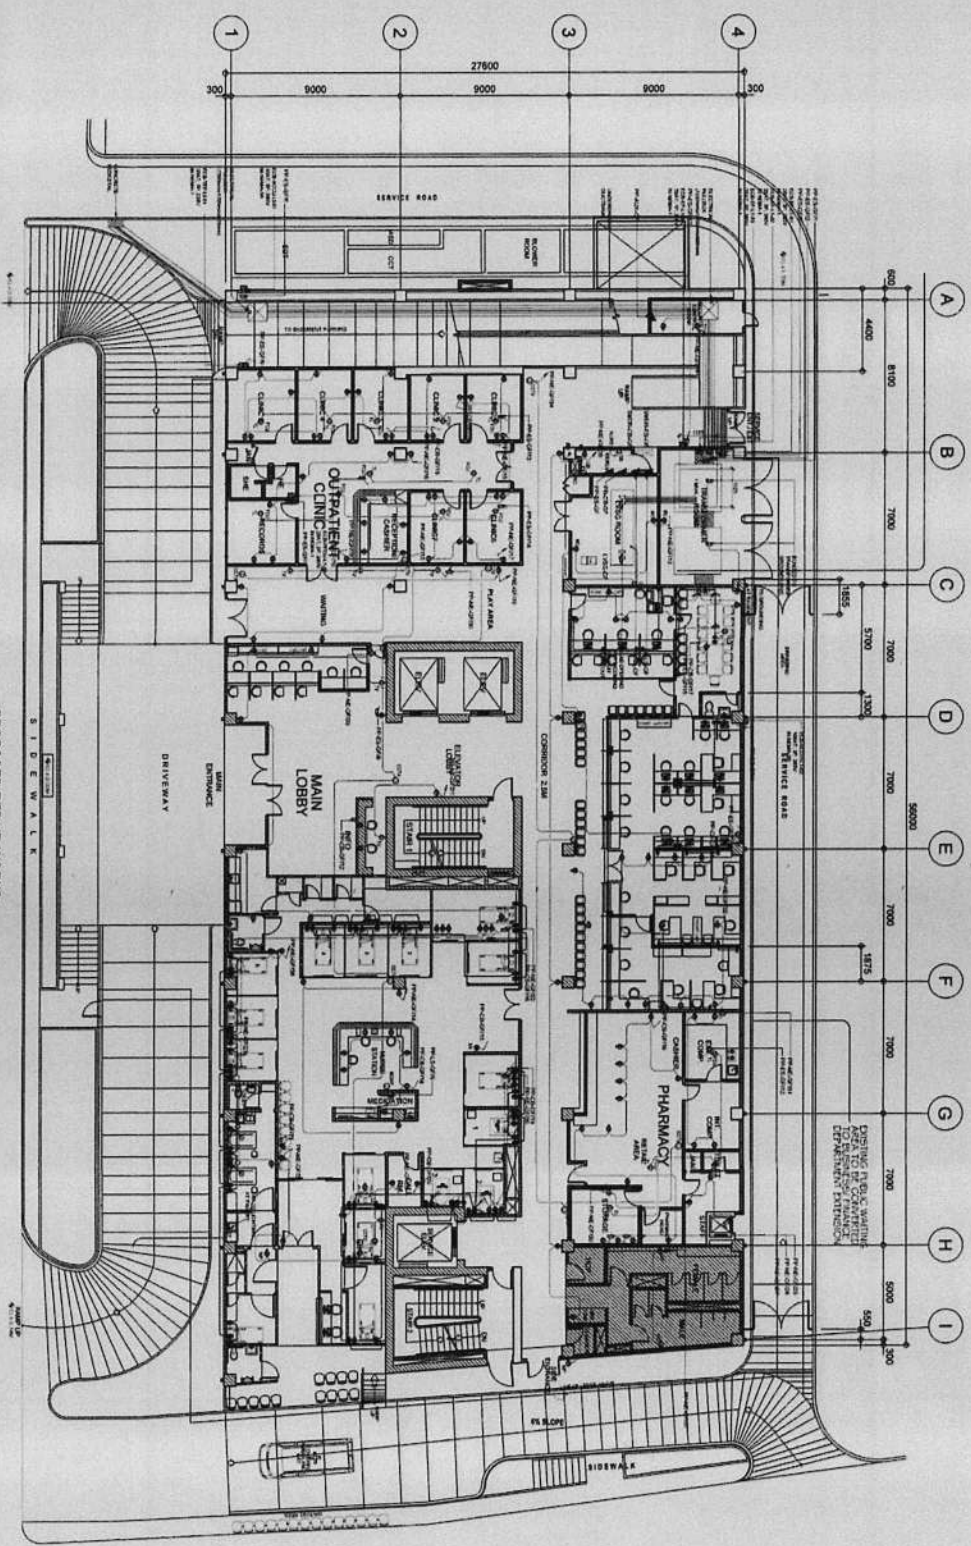

PROPOSED REPAIR WORKS
GROUND FLOOR POWER LAYOUT
SCALE 1:150 MM


- SCOPE OF WORKS:
1. Installation of Lighting Fixtures and Conduit and some areas at Department and some areas at Emergency Room.
 2. Installation of Emergency Lights
 3. Installation of Hospital Grade Outlets at Emergency Room.

	REPUBLIC OF THE PHILIPPINES CITY OF PASIG OFFICE OF THE MAYOR CITY ENGINEERING OFFICE	PROJECT TITLE PROPOSED EXPANSION W/ IMPROVEMENT WORKS AT PASIG CITY CHILDREN'S HOSPITAL	PROJECT IN CHARGE ENGR. CHRISTOPHER BENEDICT C. SOLOMON ENGR. EDUARDO G. BARRERA, JR. ENGR. JOSE JESHERA T. CORTES	PROGRAMMING AND CONSTRUCTION ENGR. CAROL BELIN ENGR. JORGE L. TIZON ENGR. LARRY PRUDENCIO	RECOMMENDING APPROVAL ENGR. ARTAVARDES Y. CERONIMO	APPROVED BY: VICTOR MA. REGIS N. SOTTO CITY MAYOR	SHEET CONTENT POWER LAYOUT	SHEET NO. E 2873
	PROJECT LOCATION INDUSTRIAL COR. AL CALDER, JOSE STS. PASIG, PASIG CITY	PROJECT NO. CHANGE 01	PROJECT NO. CONSTRUCTION 01	PROJECT NO. APPROVAL 01	PROJECT NO. APPROVAL 01	PROJECT NO. APPROVAL 01	PROJECT NO. APPROVAL 01	PROJECT NO. APPROVAL 01

IMPORTANT NOTES:



1. ALL INSTALLATIONS SHALL BE IN ACCORDANCE WITH THE NATIONAL ELECTRICAL CODE (NEC) AND THE NATIONAL WIRING CODE (NWC).
2. CONDUIT SHALL BE INSTALLED IN ACCORDANCE WITH THE NATIONAL ELECTRICAL CODE (NEC) AND THE NATIONAL WIRING CODE (NWC).
3. THE TYPE AND SIZE OF CONDUIT SHALL BE AS SPECIFIED IN THE CONTRACT DOCUMENTS.
4. THE TYPE AND SIZE OF WIRING SHALL BE AS SPECIFIED IN THE CONTRACT DOCUMENTS.
5. THE TYPE AND SIZE OF LIGHTING FIXTURES SHALL BE AS SPECIFIED IN THE CONTRACT DOCUMENTS.
6. THE TYPE AND SIZE OF EMERGENCY LIGHTS SHALL BE AS SPECIFIED IN THE CONTRACT DOCUMENTS.

CONFORME & ACCEPTED BY:
CONTRACTOR

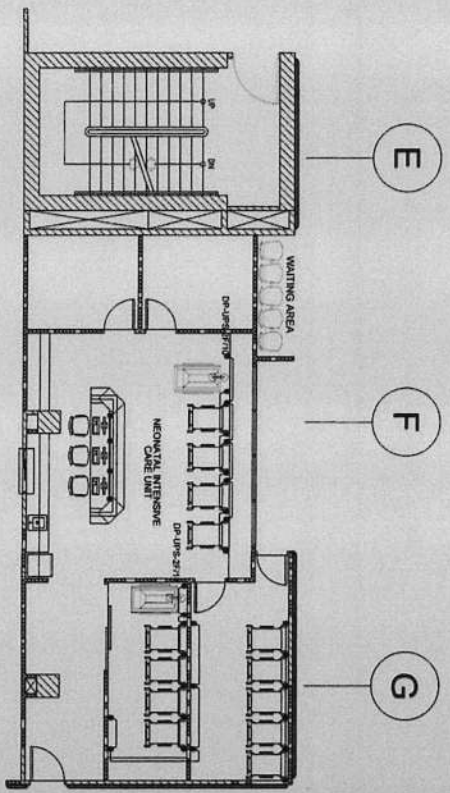

WITH PROPOSED REPAIR WORKS
SECOND FLOOR POWER LAYOUT

- SCOPE OF WORKS:
1. Installation of Convenience Outlets (Hospital Grade) at Intensive Care Unit Wards and Operating Rooms.
 2. Rewiring of Electrical System.

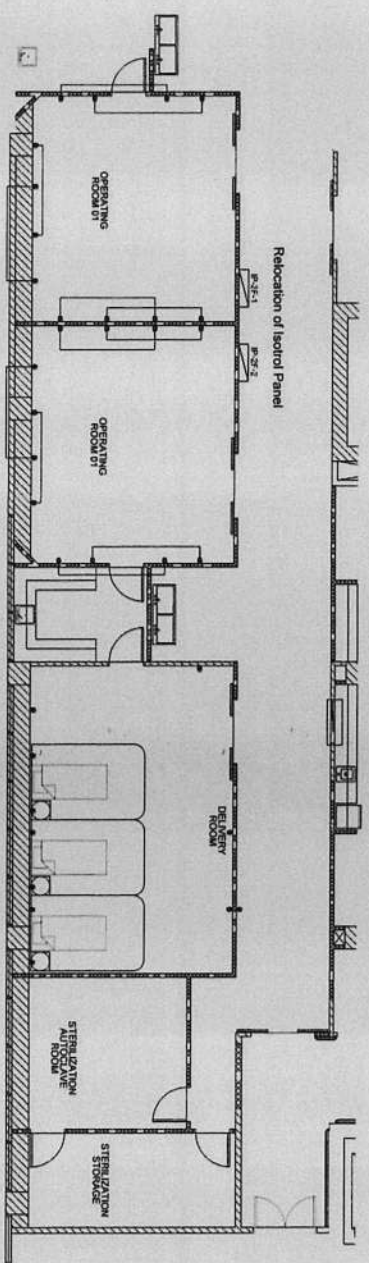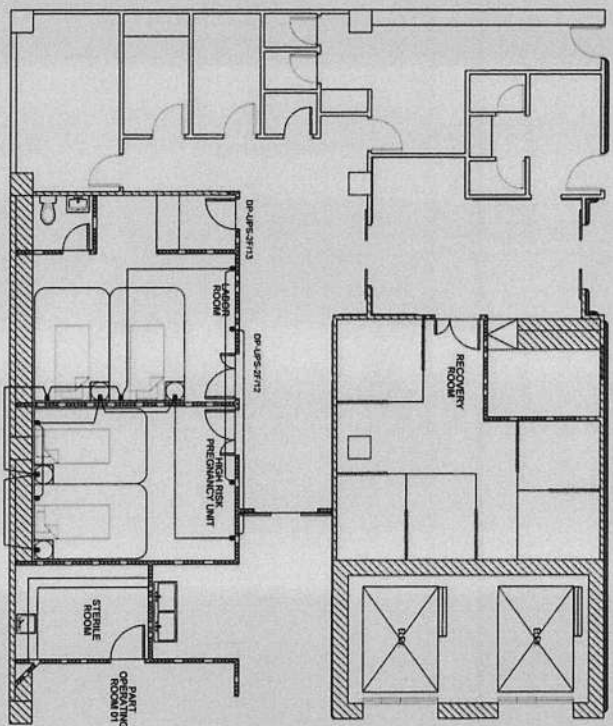


- SCOPE OF WORKS:
1. Installation of Convenience Outlets (Hospital Grade) at Operating Rooms.
 2. Rewiring of Electrical System.

	REPUBLIC OF THE PHILIPPINES CITY OF PASIG OFFICE OF THE MAYOR CITY ENGINEERING OFFICE	PROJECT TITLE: PROPOSED EXPANSION W/ IMPROVEMENT WORKS AT PASIG CITY CHILDREN'S HOSPITAL	PROJECT IN CHARGE: ENGR. CHERRY S. SANCHEZ ENGR. EDUARDO S. SANCHEZ ENGR. JONAS T. SANCHEZ	PROGRAMMING AND CONSTRUCTION: ENGR. JORGE L. TIZON ENGR. JUAN T. SANCHEZ	RECOMMENDING APPROVAL: ENGR. EDUARDO S. SANCHEZ ENGR. ARTAVERTES V. GERONIMO	APPROVED BY: VICTOR MA. REGIS N. SOTTO CITY MAYOR	SHEET CONTENT: POWER LAYOUT	SHEET NO.:
	PROJECT LOCATION: MONTECALA CON. AL CALICE JOSE STS.	PROJECT NO.: PASIG CHILDREN'S HOSPITAL	PROJECT DATE: 2018	PROJECT STATUS: PRELIMINARY	PROJECT REVIEWER: ENGR. JORGE L. TIZON	PROJECT APPROVAL DATE: 2018	PROJECT APPROVAL SIGNATURE: 	PROJECT APPROVAL DATE: 2018

IMPORTANT NOTES:

1. NO ALTERATION IN AREA & STRUCTURE SHALL BE MADE WITHOUT THE APPROVAL OF THE ARCHITECT.
2. IN ANY CASE, THE CONTRACTOR SHALL BE RESPONSIBLE FOR THE PROTECTION OF THE EXISTING STRUCTURE.
3. TO THE EXTENT OF THE INSTRUCTIONS, THE CONTRACTOR SHALL BE RESPONSIBLE FOR THE PROTECTION OF THE EXISTING STRUCTURE.
4. THE CONTRACTOR SHALL BE RESPONSIBLE FOR THE PROTECTION OF THE EXISTING STRUCTURE.
5. THE CONTRACTOR SHALL BE RESPONSIBLE FOR THE PROTECTION OF THE EXISTING STRUCTURE.
6. THE CONTRACTOR SHALL BE RESPONSIBLE FOR THE PROTECTION OF THE EXISTING STRUCTURE.

CONFIRMED & ACCEPTED BY:
C O N T R A C T O R

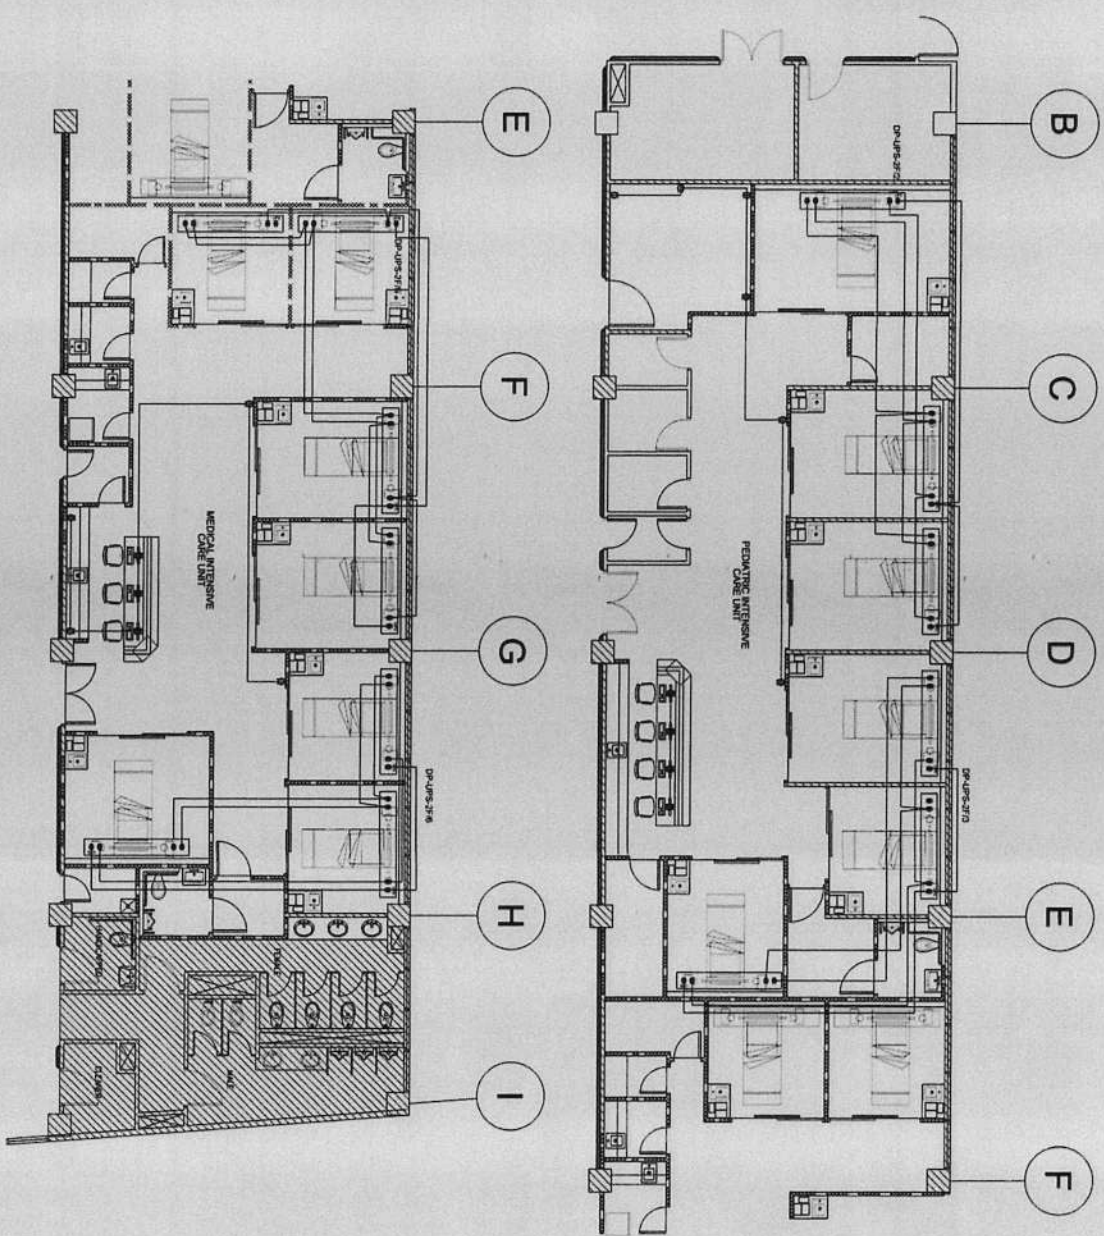

WITH PROPOSED REPAIR WORKS
SECOND FLOOR POWER LAYOUT
 01
 A/B SCALE
 NTS


- SCOPE OF WORKS:
1. Installation of Convenience Outlets (Hospital Grade) at Intensive Care Unit Wards and Operating Rooms.
 2. Rewiring of Electrical System.

	REPUBLIC OF THE PHILIPPINES CITY OF PASIG OFFICE OF THE MAYOR CITY ENGINEERING OFFICE	PROJECT TITLE: PROPOSED EXPANSION W/ IMPROVEMENT WORKS AT PASIG CITY CHILDREN'S HOSPITAL	PROJECT IN CHARGE: ENGR. CHRISTOPHER M. SOLORZANO ENGR. EDUARDO C. BERNUCA, JR. ENGR. JOHN M. BELTRAN, I. COATES	PROGRAMMING AND CONSTRUCTION: ENGR. JOSE T. TIOU OIC, ELECTRICAL ENGINEERING SECTION	RECOMMENDING APPROVAL: ENGR. ANTONIO P. RIVERA OIC, ELECTRICAL ENGINEERING SECTION	APPROVED BY: VICTOR MA. REGIS N. SOTTO CITY MAYOR	SHEET CONTENT: POWER LAYOUT	SHEET NO.: 3073
	PROJECT LOCATION: PASIG CITY CHILDREN'S HOSPITAL PASIG CITY	PROJECT NO.: PASIG-2016-001	PROJECT DATE: 2016	PROJECT STATUS: PRELIMINARY	PROJECT COST: P1,000,000.00	PROJECT OWNER: PASIG CITY GOVERNMENT	PROJECT CONTRACTOR: PASIG CITY GOVERNMENT	PROJECT SCHEDULE: 2016-2017

IMPORTANT NOTES:

1. ALL ELECTRICAL WORK SHALL BE IN ACCORDANCE WITH THE NATIONAL ELECTRICAL CODE (NEC) AND THE NATIONAL ELECTRICAL ENGINEERING BOARD (NEEB) REGULATIONS.
2. ALL ELECTRICAL WORK SHALL BE IN ACCORDANCE WITH THE NATIONAL ELECTRICAL CODE (NEC) AND THE NATIONAL ELECTRICAL ENGINEERING BOARD (NEEB) REGULATIONS.
3. THE CONTRACTOR SHALL BE RESPONSIBLE FOR OBTAINING ALL NECESSARY PERMITS AND APPROVALS FROM THE PASIG CITY GOVERNMENT AND THE PASIG CITY ENGINEERING OFFICE.
4. THE CONTRACTOR SHALL BE RESPONSIBLE FOR OBTAINING ALL NECESSARY PERMITS AND APPROVALS FROM THE PASIG CITY GOVERNMENT AND THE PASIG CITY ENGINEERING OFFICE.
5. THE CONTRACTOR SHALL BE RESPONSIBLE FOR OBTAINING ALL NECESSARY PERMITS AND APPROVALS FROM THE PASIG CITY GOVERNMENT AND THE PASIG CITY ENGINEERING OFFICE.

CONTRACTOR

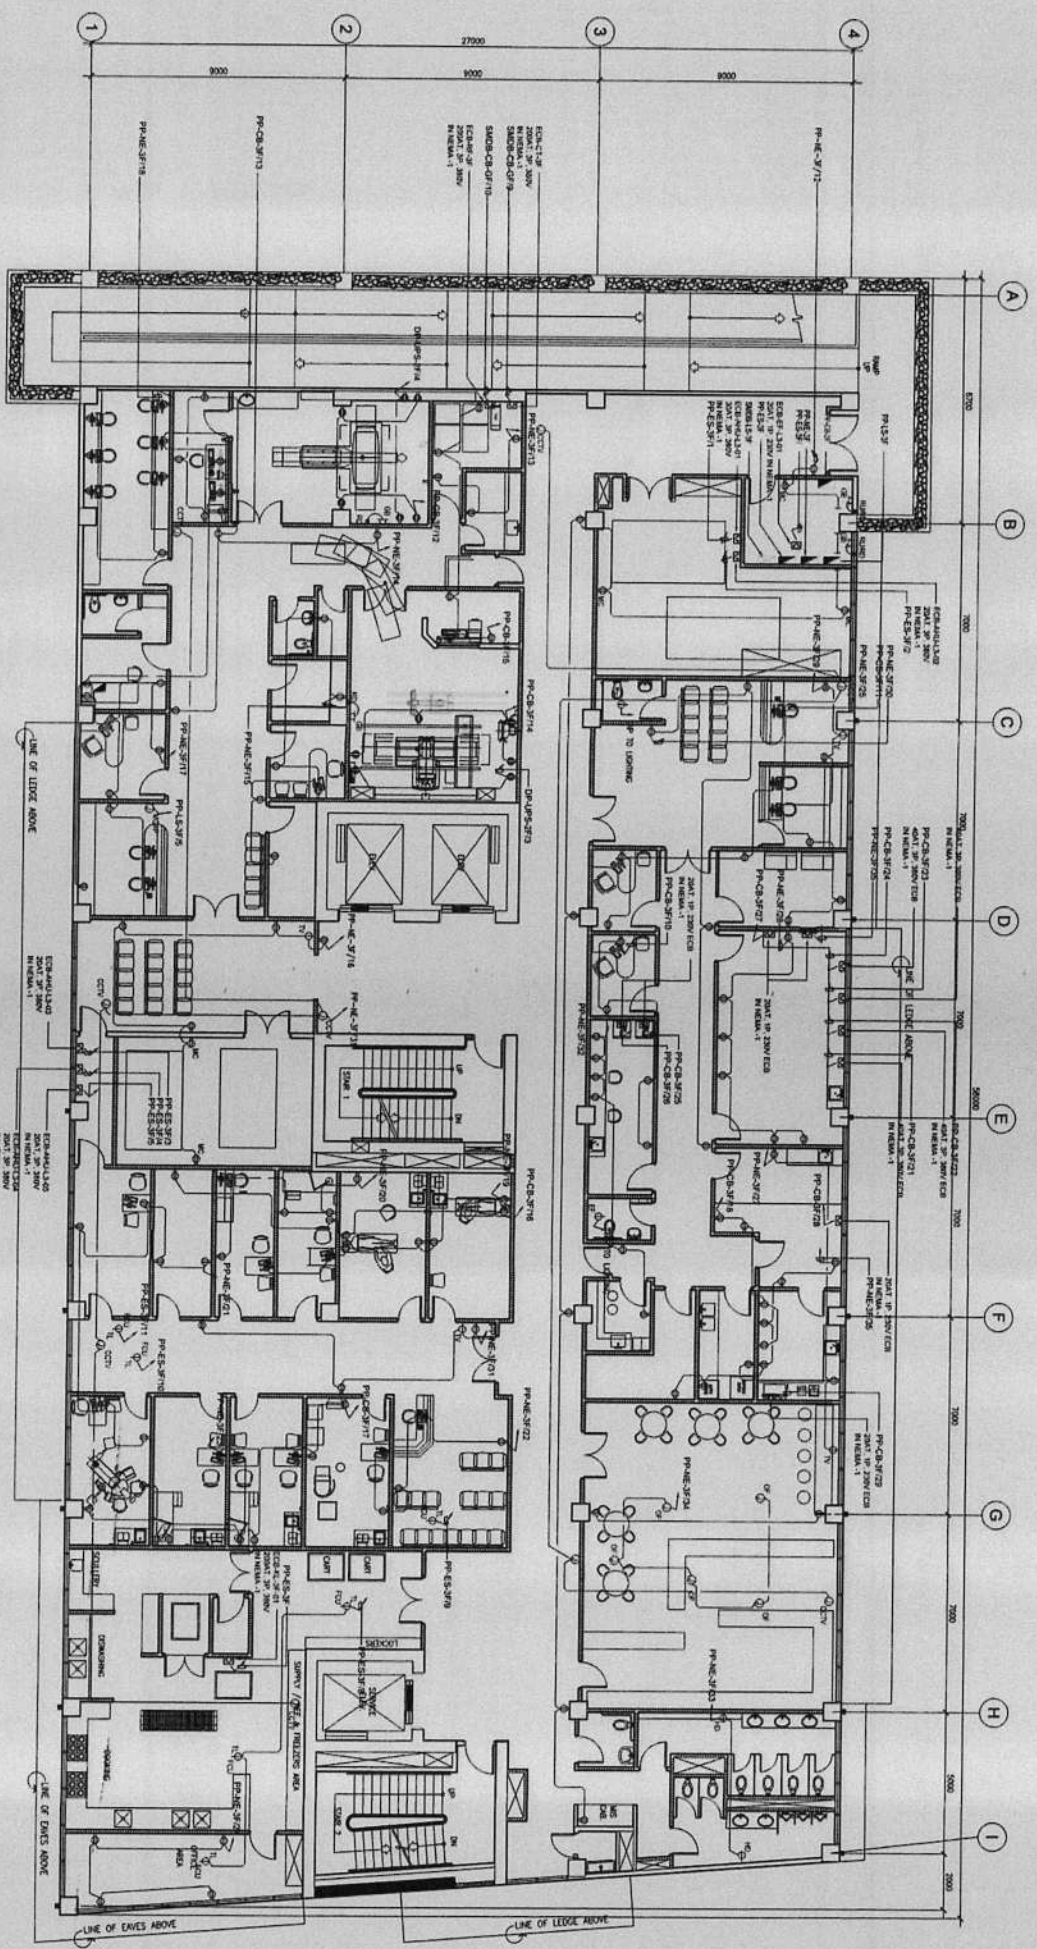


WITH PROPOSED REPAIR WORKS
THIRD FLOOR POWER LAYOUT

- SCOPE OF WORKS:**
1. Rewiring of Power Outlet base on power requirements of laboratory equipments on actual location.
 2. Additional Laboratory Equipments shall be connected to New PB-Laboratory.

<p>REPUBLIC OF THE PHILIPPINES OFFICE OF THE MAYOR CITY ENGINEERING OFFICE</p>	<p>PROJECT TITLE</p> <p>PROPOSED EXPANSION W/ IMPROVEMENT WORKS AT PASIG CITY CHILDREN'S HOSPITAL</p>	<p>PROJECT IN CHARGE</p> <p>ENGR. Campana <i>[Signature]</i> PRINCIPAL C SOLUTION</p>	<p>PROGRAMMING AND CONSTRUCTION</p> <p>ENGR. JOSE L. TIZON</p>	<p>RECOMMENDING APPROVAL</p> <p>ENGR. ARTAVARDES V. GERONIMO</p>	<p>APPROVED BY:</p> <p>VICTOR MAR REGIS N. SOTTO CITY MAYOR</p>	<p>SHEET CONTENT</p> <p>POWER LAYOUT</p>	<p>SHEET NO.</p> <p>E 317/3</p>
	<p>LOCATION: PASIG CITY CHILDREN'S HOSPITAL PASIG CITY</p>	<p>ENGR. EDUARDO S. BERNALDO, JR. ENGR. JOHN ANASTASIO I. CORTES</p>	<p>ENGR. JOSE L. TIZON O.I.C. ELECTRICAL DEPARTMENT</p>	<p>ENGR. ARTAVARDES V. GERONIMO O.P. CITY ENGINEERING OFFICE</p>	<p>CONTRACTOR</p>		

IMPORTANT NOTES:

1. ALL ELECTRICAL WORK SHALL BE IN ACCORDANCE WITH THE NATIONAL ELECTRICAL CODE AND THE PASIG CITY ELECTRICAL REGULATIONS.
2. ALL ELECTRICAL WORK SHALL BE IN ACCORDANCE WITH THE PASIG CITY ELECTRICAL REGULATIONS.
3. NO USE OF ELECTRICAL WORK SHALL BE MADE IN THE WORKING AREA WITHOUT THE APPROVAL OF THE ELECTRICAL ENGINEER IN CHARGE.
4. ALL ELECTRICAL WORK SHALL BE IN ACCORDANCE WITH THE PASIG CITY ELECTRICAL REGULATIONS.
5. THE CONTRACTOR SHALL BE RESPONSIBLE FOR THE PROTECTION OF ALL EXISTING UTILITIES AND STRUCTURES.
6. ALL ELECTRICAL WORK SHALL BE IN ACCORDANCE WITH THE PASIG CITY ELECTRICAL REGULATIONS.

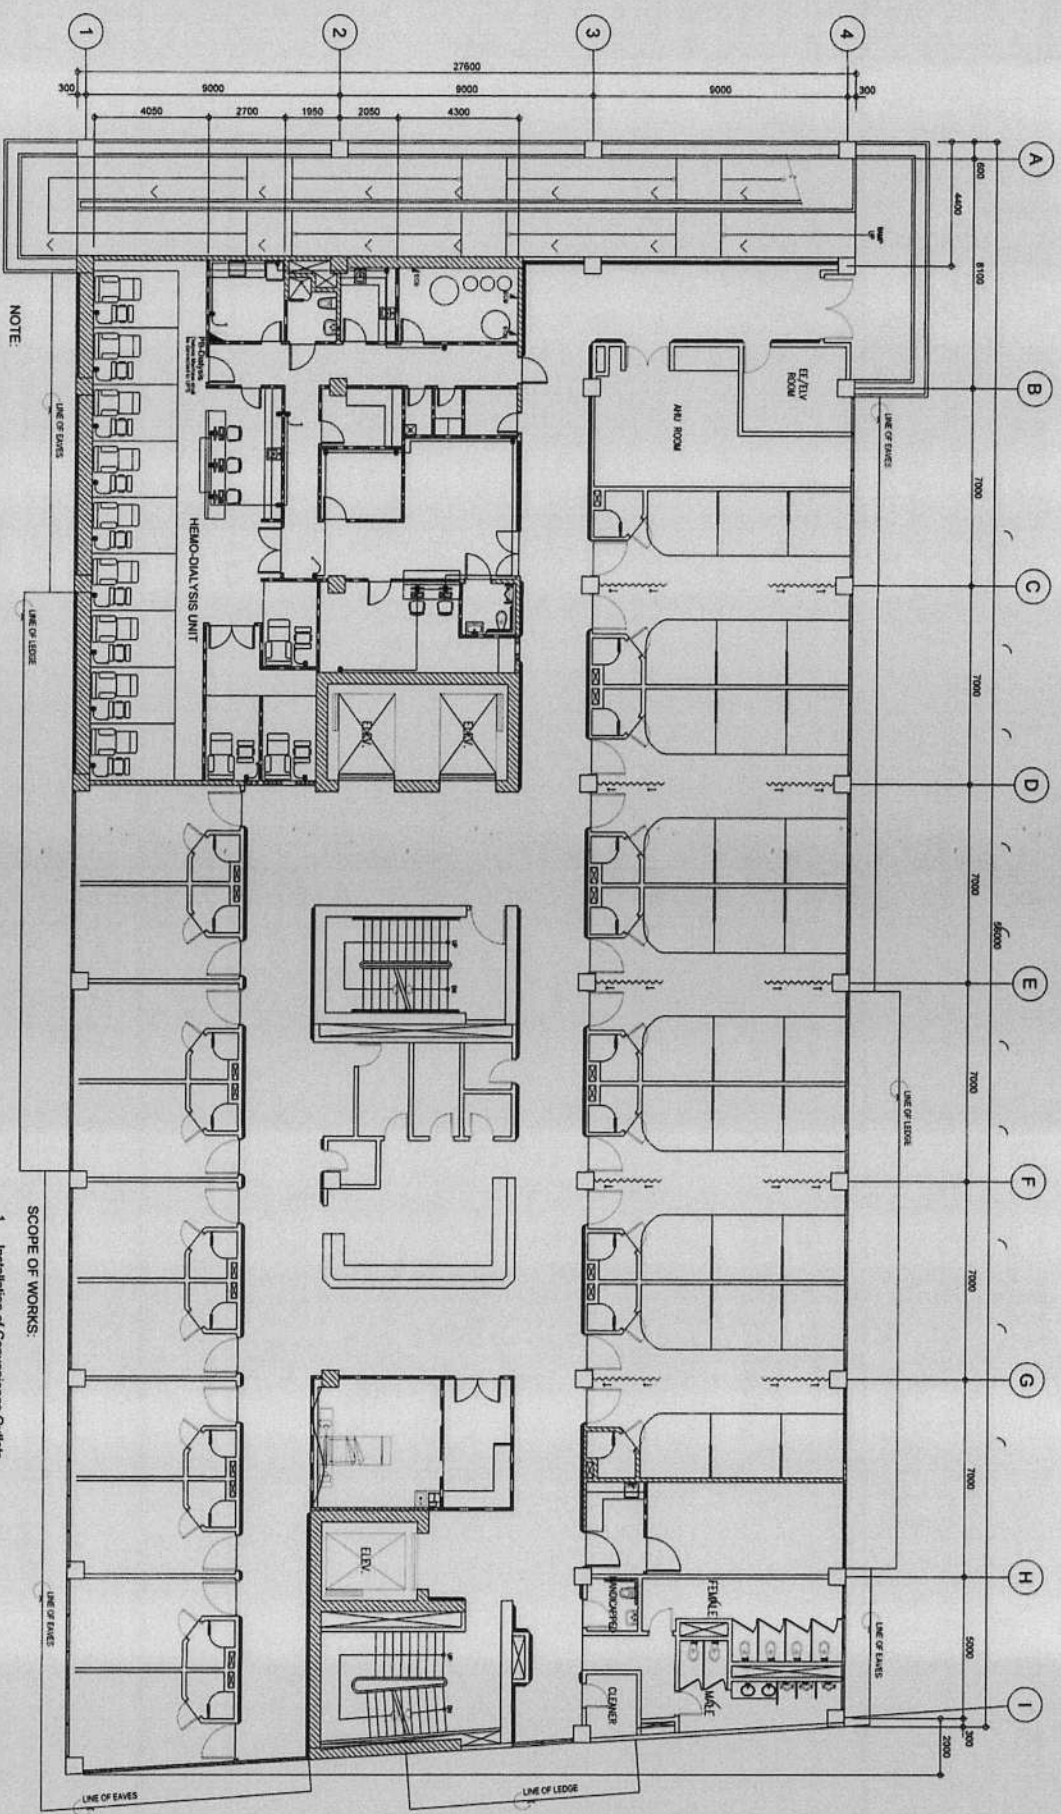

NOTE:
1. NEED SPACE FOR UPS EQUIPMENT

**PROPOSED LAYOUT FOR REPAIR WORKS
FIFTH FLOOR POWER LAYOUT**

SCALE
1:50

- SCOPE OF WORKS:
1. Installation of Convenience Outlets and Special Purpose Outlet for Dialysis Machine
 2. Tapped to New Panelboard (PB-Dialysis)



REPUBLIC OF THE PHILIPPINES
CITY OF PASIG
OFFICE OF THE MAJOR
CITY ENGINEERING OFFICE

PROJECT TITLE:
**PROPOSED EXPANSION W/
IMPROVEMENT WORKS AT
PASIG CITY CHILDREN'S HOSPITAL**

PROJECT IN CHARGE:
ENGR. **DIANE B. BENEDECIO C. SOLONON**
ENGR. **EDUARDO B. BARRERA JR.**

PROGRAMMING AND CONSTRUCTION:
ENGR. **CELALE BELIN**
ENGR. **JORGE L. TIZON**

RECOMMENDING APPROVAL:
ENGR. **LAWRENCE S. PRUDENCIO**
ENGR. **ARTAJANES V. GERONIMO**


APPROVED BY:
VICTOR M. REGIS N. SOTTO
CITY MAJOR

SHEET NO. **E 3273**

SHEET CONTENT:
POWER LAYOUT

CONTRACTOR:
CONFIRMED & ACCEPTED BY:

IMPORTANT NOTES:
1. ALL ELECTRICAL WORKS SHALL BE IN ACCORDANCE WITH THE NATIONAL ELECTRICAL CODE (NEC) AND THE PASIG CITY ELECTRICAL CODE.
2. ALL ELECTRICAL WORKS SHALL BE IN ACCORDANCE WITH THE PASIG CITY ELECTRICAL CODE.
3. ALL ELECTRICAL WORKS SHALL BE IN ACCORDANCE WITH THE PASIG CITY ELECTRICAL CODE.
4. ALL ELECTRICAL WORKS SHALL BE IN ACCORDANCE WITH THE PASIG CITY ELECTRICAL CODE.
5. ALL ELECTRICAL WORKS SHALL BE IN ACCORDANCE WITH THE PASIG CITY ELECTRICAL CODE.
6. ALL ELECTRICAL WORKS SHALL BE IN ACCORDANCE WITH THE PASIG CITY ELECTRICAL CODE.

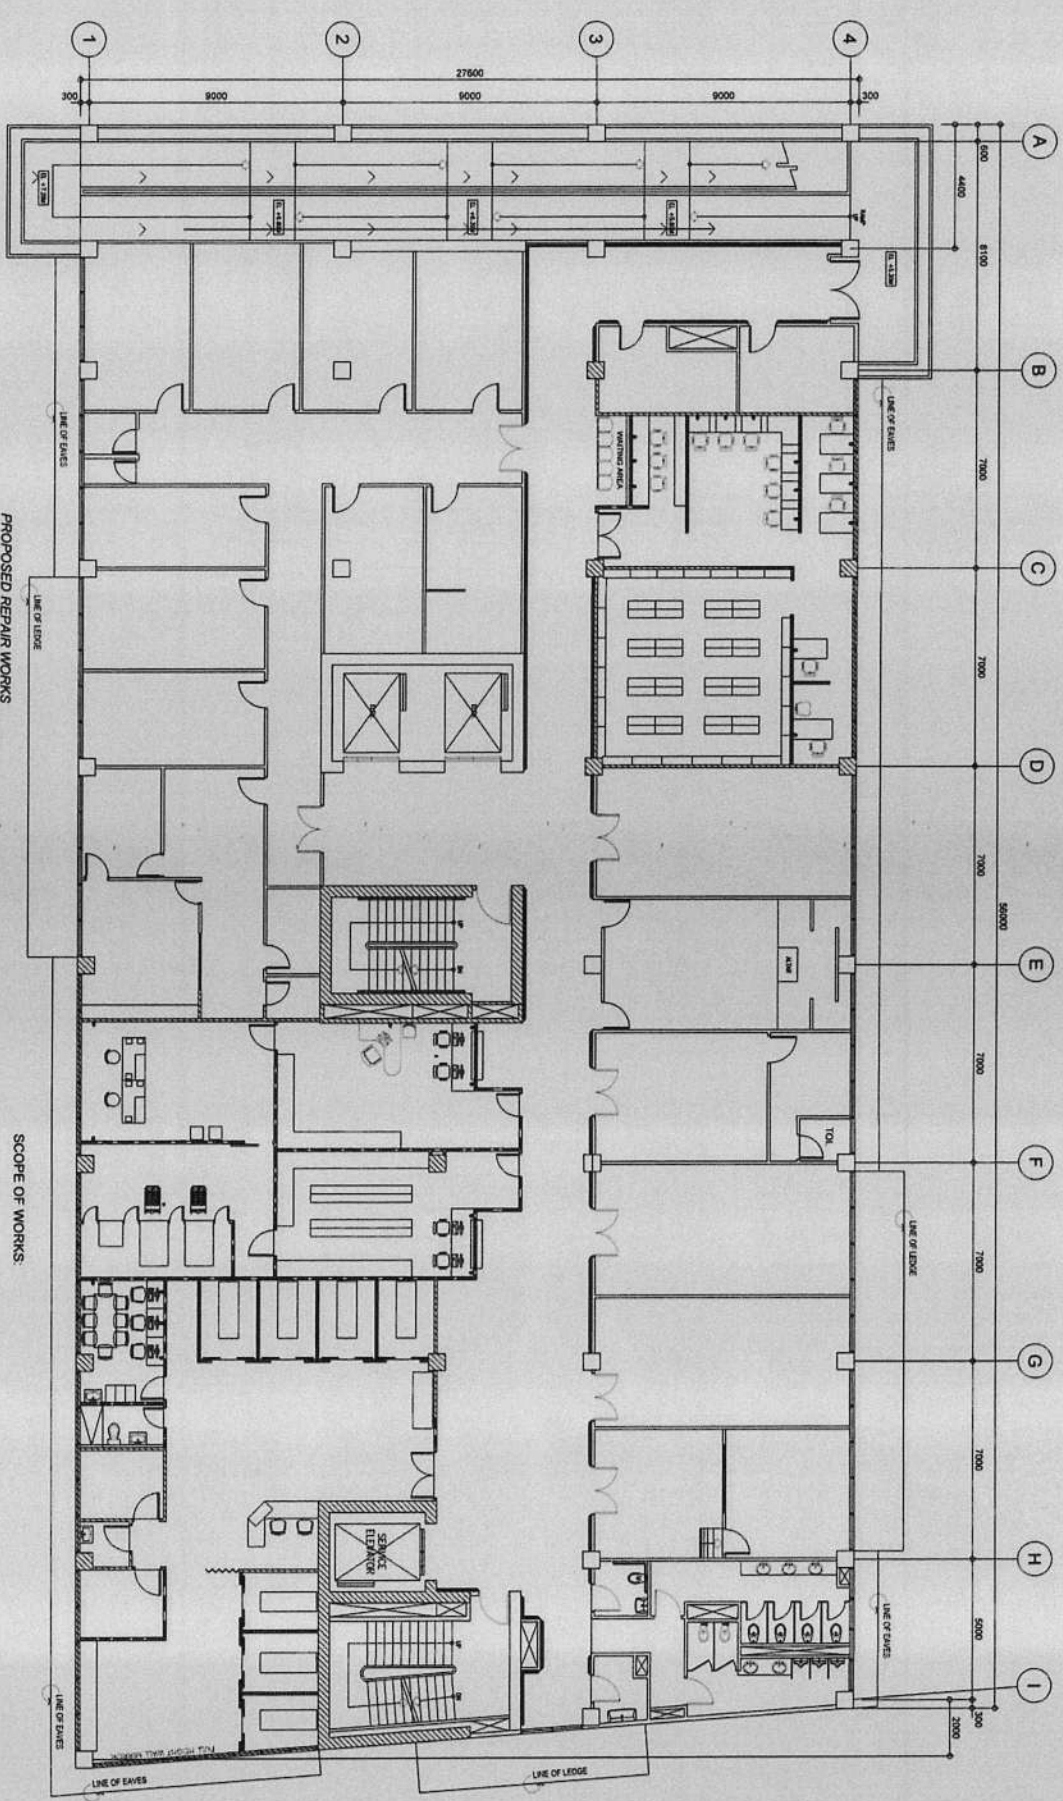

PROPOSED REPAIR WORKS
SIXTH FLOOR POWER LAYOUT
1:150 SCALE


- SCOPE OF WORKS:
1. Installation of Convenience Outlets
 2. Tapped to existing Power Outlet to Existing Panelboards.

<p>REPUBLIC OF THE PHILIPPINES CITY OF PASIG OFFICE OF THE MAYOR CITY ENGINEERING OFFICE</p>	PROJECT TITLE:	PROJECT IN CHARGE:	PROGRAMMING AND CONSTRUCTION:	RECOMMENDING APPROVAL:	APPROVED BY:	SHEET CONTENT:	SHEET NO.:
	<p>PROPOSED EXPANSION W/ IMPROVEMENT WORKS AT PASIG CITY CHILDREN'S HOSPITAL</p> <p>LOCATION: INDUSTRIAL COR. ALBUQUE JOSE STS. PASIG CITY</p>	<p>ENGR. CHERYL JENNIFER C. SOLMON ENGR. EDUARDO Z. FABRICA JR. ENGR. JOHN PAUL T. CORTES</p> <p>ENGR. JOSE L. TIZON OIC. ELECTRICAL INSPECTORIAL SECTION</p> <p>ENGR. LAYMAN R. FRIEDRICO OIC. ELECTRICAL INSPECTORIAL SECTION</p> <p>ENGR. ARTABERRES V. GERONIMO OIC. CITY ENGINEERING OFFICE</p>	<p>VICTOR M.A. REGIS N. SOTTO CITY MAYOR</p>	<p>POWER LAYOUT</p>	<p>3373</p>		

WORKING NOTES:

1. CONSULT THE ELECTRICAL ENGINEER FOR THE PROPOSED WORKS AND VERIFY THE LOCATION OF THE ELECTRICAL PANELS AND CONDUITS.
2. VERIFY THE LOCATION OF THE ELECTRICAL PANELS AND CONDUITS WITH THE ELECTRICAL ENGINEER.
3. VERIFY THE LOCATION OF THE ELECTRICAL PANELS AND CONDUITS WITH THE ELECTRICAL ENGINEER.
4. VERIFY THE LOCATION OF THE ELECTRICAL PANELS AND CONDUITS WITH THE ELECTRICAL ENGINEER.
5. VERIFY THE LOCATION OF THE ELECTRICAL PANELS AND CONDUITS WITH THE ELECTRICAL ENGINEER.
6. VERIFY THE LOCATION OF THE ELECTRICAL PANELS AND CONDUITS WITH THE ELECTRICAL ENGINEER.

CONFORMABLE & ACCEPTED BY:
C O N T R A C T O R

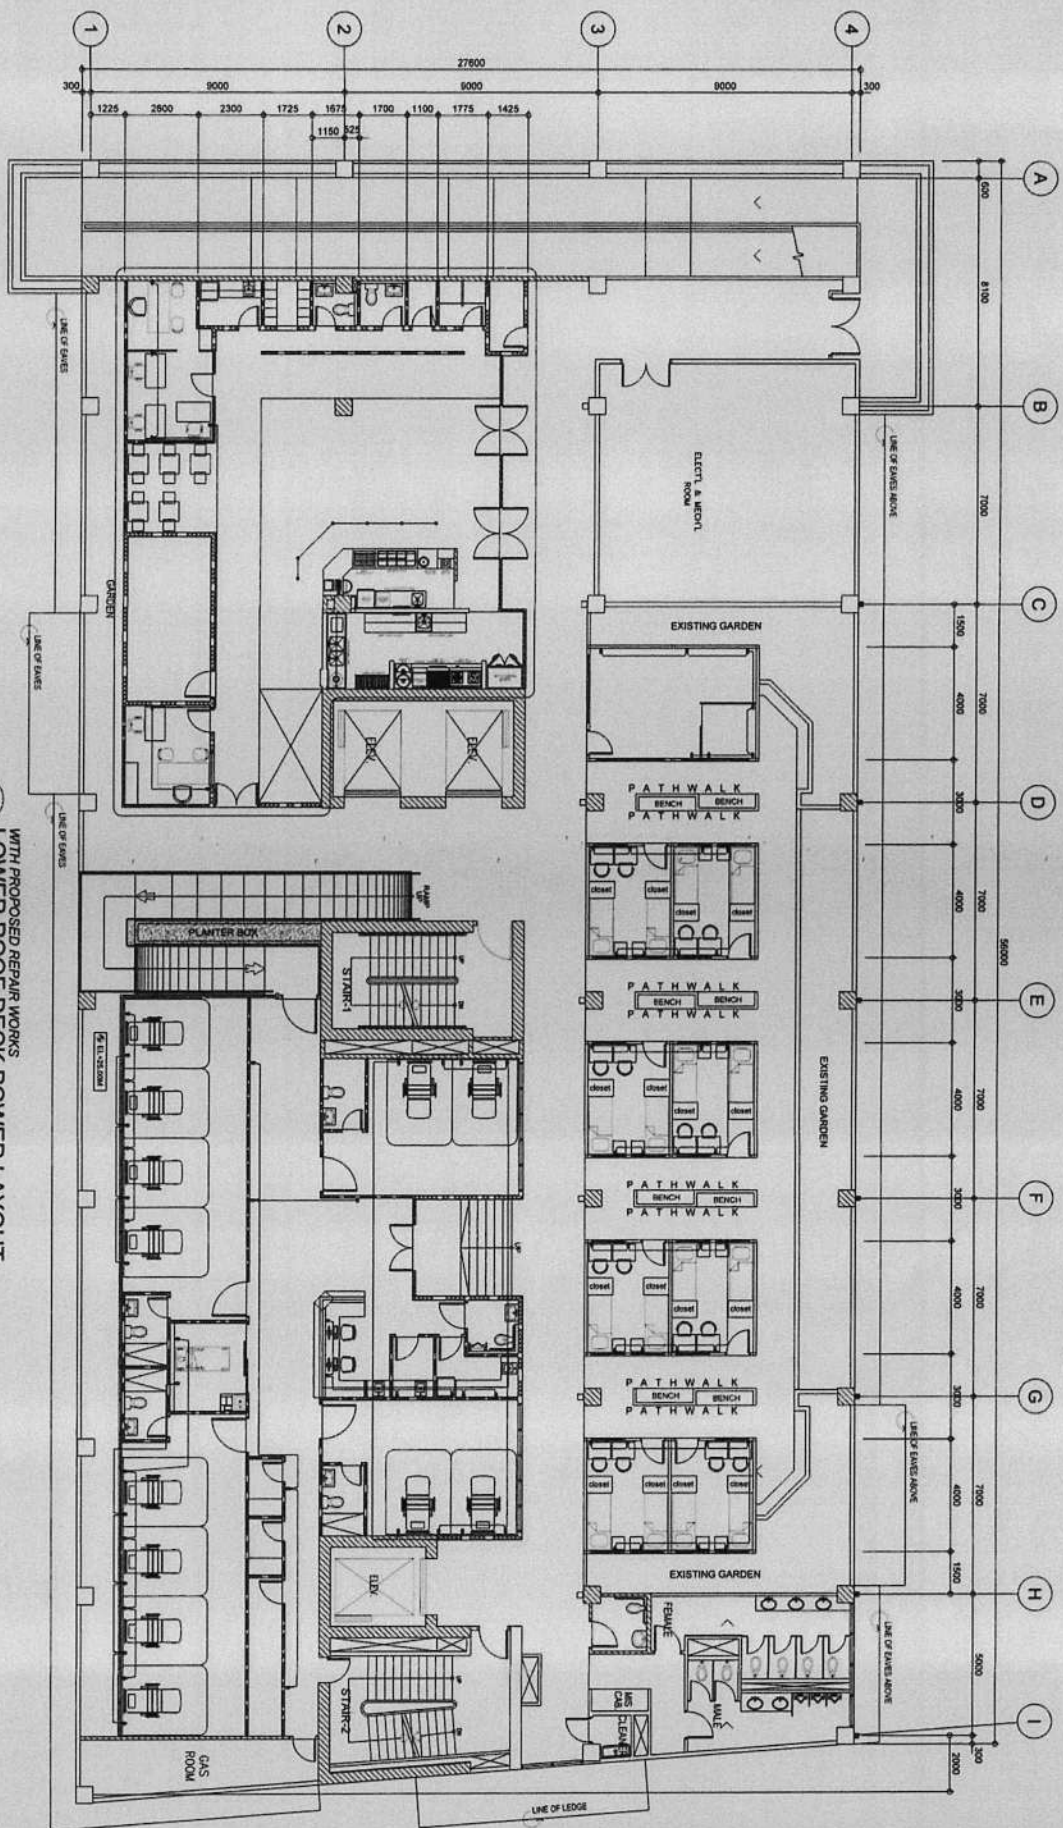

WITH PROPOSED REPAIR WORKS
LOWER ROOF DECK POWER LAYOUT

1 : 100 MM

01
A 17
SCALE



REPUBLIC OF THE PHILIPPINES
CITY OF PASIG
OFFICE OF THE MAYOR
CITY ENGINEERING OFFICE

PROJECT TITLE:
**PROPOSED EXPANSION W/
IMPROVEMENT WORKS AT
PASIG CITY CHILDREN'S HOSPITAL**

PROJECT IN CHARGE:
ENGR. CHESTER B. BENEDECIO C. SOLADON
ENGR. EDUARDO B. BARRERA JR.
ENGR. JOSE L. TIZON
ENGR. JORGE L. TIZON
ENGR. LAMARQUE B. FRUENDENCO
ENGR. ARTAVERNES V. GERONIMO

PROGRAMMING AND CONSTRUCTION:
ENGR. CARLA L. BELLA
ENGR. JOSE L. TIZON
ENGR. LAMARQUE B. FRUENDENCO

RECOMMENDING APPROVAL:
ENGR. VICTOR M. REGIS N. SOTTO


APPROVED BY:
VICTOR M. REGIS N. SOTTO
CITY MAYOR

SHEET CONTENT:
POWER LAYOUT


SHEET NO.:
E
3473

IMPORTANT NOTES:
1. CONSULT THE CONTRACT DOCUMENTS AND SPECIFICATIONS FOR THE PROJECT.
2. THE CONTRACTOR SHALL BE RESPONSIBLE FOR THE PROVISION OF ALL MATERIALS AND LABOR.
3. THE CONTRACTOR SHALL BE RESPONSIBLE FOR THE PROVISION OF ALL NECESSARY PERMITS AND APPROVALS.
4. THE CONTRACTOR SHALL BE RESPONSIBLE FOR THE PROVISION OF ALL NECESSARY SAFETY MEASURES.
5. THE CONTRACTOR SHALL BE RESPONSIBLE FOR THE PROVISION OF ALL NECESSARY PROTECTION OF EXISTING UTILITIES.
6. THE CONTRACTOR SHALL BE RESPONSIBLE FOR THE PROVISION OF ALL NECESSARY PROTECTION OF EXISTING STRUCTURES.
CONTRACTOR


PIPING GROUND FLOOR SYSTEM 1

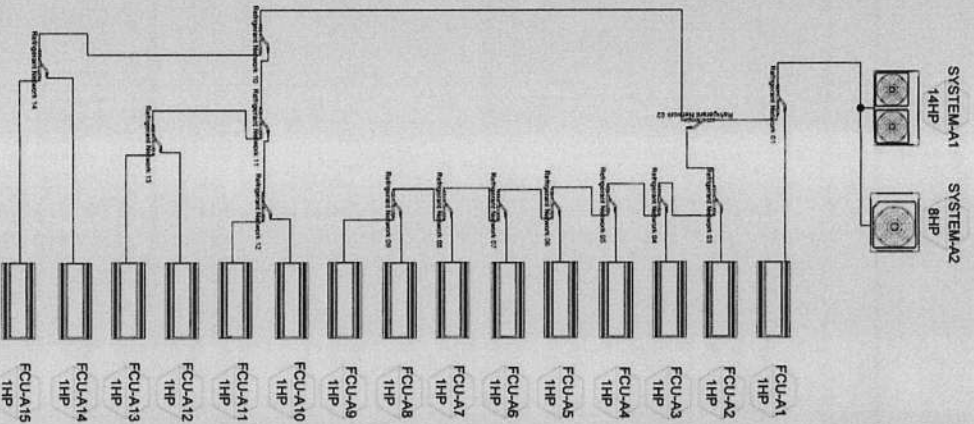

PIPING GROUND FLOOR SYSTEM 2

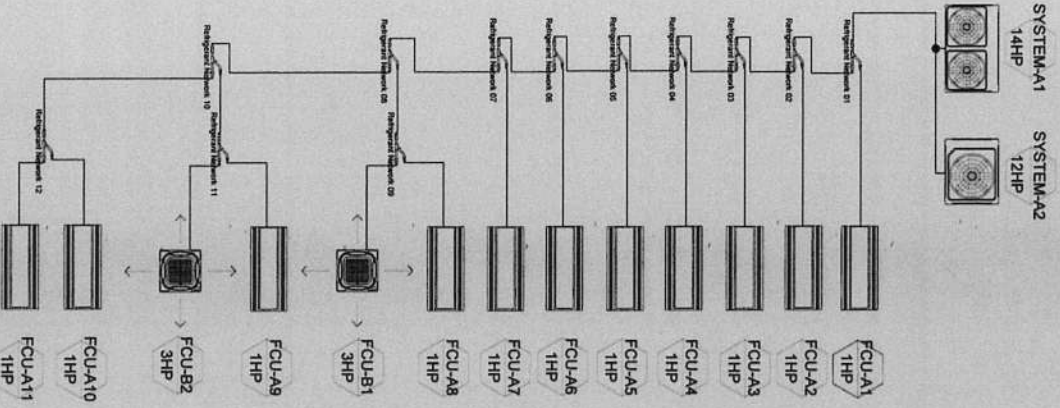

PIPING GROUND FLOOR SYSTEM 3

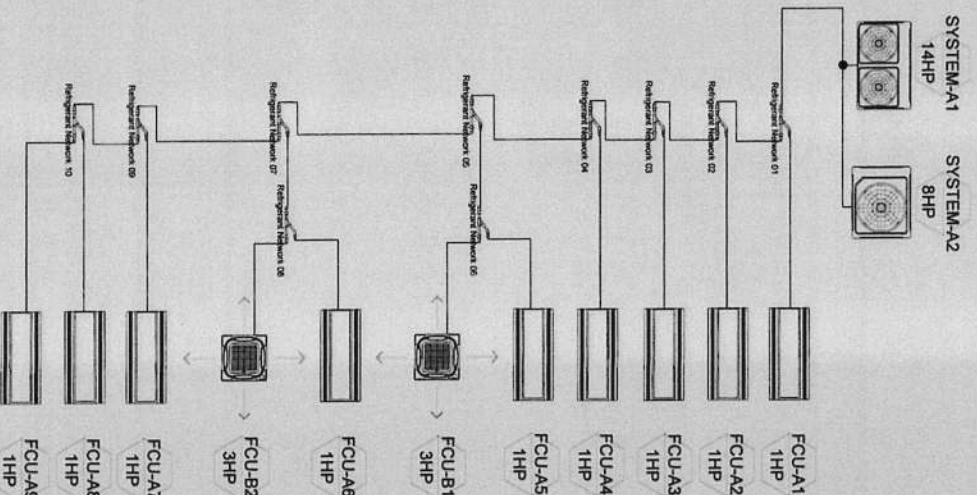

REPUBLIC OF THE PHILIPPINES
CITY OF PASIG
OFFICE OF THE MAYOR
CITY ENGINEERING OFFICE

PROJECT TITLE:
PROPOSED EXPANSION W/
IMPROVEMENT WORKS AT
PASIG CITY CHILDREN'S HOSPITAL
LOCATION: INDUSTRIAL CORP. ALI GARZA JOSE STS.,
MAYORALDA PASIG CITY

PROJECT IN CHARGE:
ENGR. CHRISTOPHER S. SOLONON
ENGR. EDUARDO G. BARRERA, JR.
ENGR. JOHN EDUARDO T. CORTES

PROGRAMMING AND CONSTRUCTION:
ENGR. CAROL BELLI
ENGR. JOSE L. TIRON
DR. ESTRELLA MARIANAS SECTION


RECOMMENDING APPROVAL:
ENGR. EMILIO E. PRUDENCIO
ENGR. ARTAXERXES V. GERONIMO

APPROVED BY:
VICTOR MA. REGIS N. SOTTO
CITY MAYOR


SHEET CONTENT: AIRCONDITION SYSTEM DETAILS
SHEET NO.: M 35/73
CONFORME & ACCEPTED BY: CONTRACTOR

1. NO PART OF THIS DRAWING SHALL BE REPRODUCED OR TRANSMITTED IN ANY FORM OR BY ANY MEANS, ELECTRONIC OR MECHANICAL, WITHOUT THE WRITTEN PERMISSION OF THE ENGINEER.
2. THE CONTRACTOR SHALL BE RESPONSIBLE FOR THE ACCURACY OF THE INFORMATION PROVIDED IN THIS DRAWING.
3. THE CONTRACTOR SHALL BE RESPONSIBLE FOR THE ACCURACY OF THE INFORMATION PROVIDED IN THIS DRAWING.
4. THE CONTRACTOR SHALL BE RESPONSIBLE FOR THE ACCURACY OF THE INFORMATION PROVIDED IN THIS DRAWING.
5. THE CONTRACTOR SHALL BE RESPONSIBLE FOR THE ACCURACY OF THE INFORMATION PROVIDED IN THIS DRAWING.


PIPING SECOND FLOOR SYSTEM 1

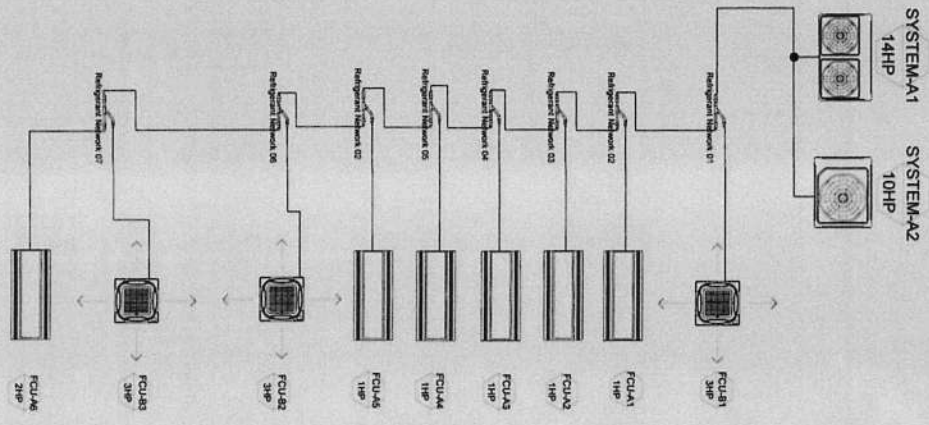


PIPING SECOND FLOOR SYSTEM 2

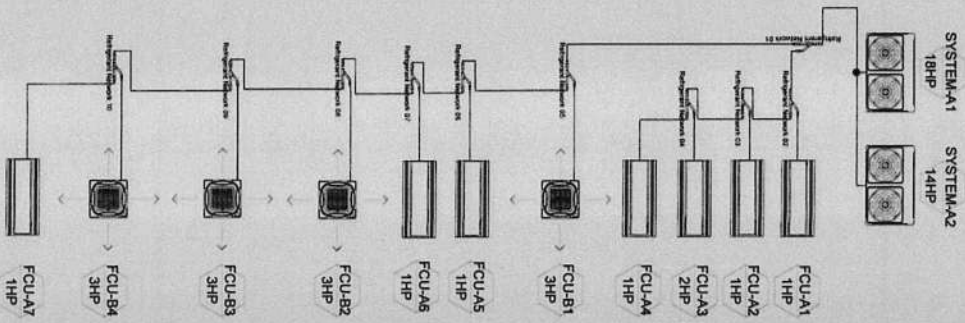


PIPING SECOND FLOOR SYSTEM 3

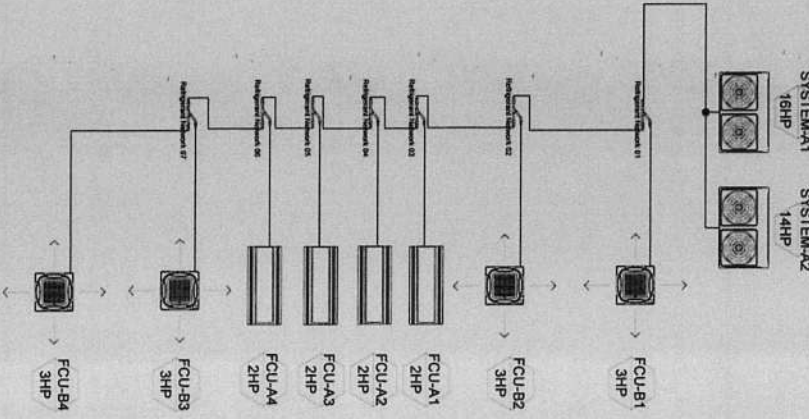

PIPING SECOND FLOOR SYSTEM 1

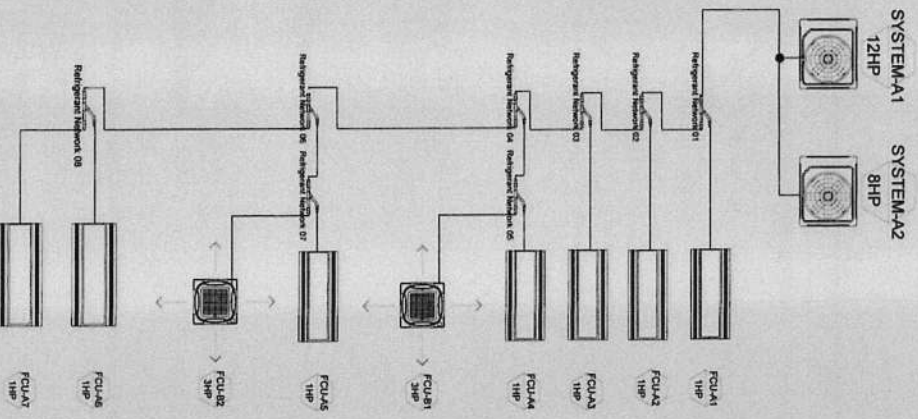


 <p>REPUBLIC OF THE PHILIPPINES CITY OF PASIG OFFICE OF THE MAYOR CITY ENGINEERING OFFICE</p>	PROJECT TITLE	PROJECT IN CHARGE	PROGRAMMING AND CONSTRUCTION	RECOMMENDING APPROVAL	APPROVED BY:	SHEET CONTENT:	SHEET NO.:
	<p>PROPOSED EXPANSION W/ IMPROVEMENT WORKS AT PASIG CITY CHILDREN'S HOSPITAL</p> <p>LOCATION: MODERNA CORP. ALCADE ROSE STS. INDUSTRIAL PARK PASIG CITY</p>	<p>ENGR. CHRISTOPHER J. SOLORSON ENGR. EDUARDO O. BARBUCA JR. ENGR. JOHN JOSHUA T. CORTES</p>	<p>ENGR. ROBERTO L. UTZOU ENGR. CAROL SELLIN ENGR. JOSE L. UTZOU ENGR. LAMARCA S. PRUDENCIO ENGR. ARTAVARDES V. GERONIMO</p>	<p>ENGR. JOSE L. UTZOU ENGR. CAROL SELLIN ENGR. LAMARCA S. PRUDENCIO ENGR. ARTAVARDES V. GERONIMO</p>	<p>ENGR. LAMARCA S. PRUDENCIO ENGR. ARTAVARDES V. GERONIMO</p>	<p>VICTOR MA. REGIS N. SOTTO CITY MAYOR</p>	<p>REFRIGERATION SYSTEM DETAILS</p>

IMPORTANT NOTES:


1. ALL MATERIALS AND WORKMANSHIP SHALL BE IN ACCORDANCE WITH THE SPECIFICATIONS AND STANDARDS OF THE BUREAU OF FIRE PROTECTION AND THE BUREAU OF SANITATION.
2. THE CONTRACTOR SHALL BE RESPONSIBLE FOR OBTAINING ALL NECESSARY PERMITS AND APPROVALS FROM THE APPROPRIATE AGENCIES.
3. THE CONTRACTOR SHALL BE RESPONSIBLE FOR THE PROTECTION AND PRESERVATION OF ALL EXISTING UTILITIES AND STRUCTURES.
4. ALL CONSTRUCTION SHALL BE IN ACCORDANCE WITH THE LATEST REVISIONS OF THE PHILIPPINE NATIONAL STANDARD (PNS) FOR MECHANICAL ENGINEERING.
5. THE CONTRACTOR SHALL BE RESPONSIBLE FOR THE PROTECTION AND PRESERVATION OF ALL EXISTING UTILITIES AND STRUCTURES.
6. THE CONTRACTOR SHALL BE RESPONSIBLE FOR THE PROTECTION AND PRESERVATION OF ALL EXISTING UTILITIES AND STRUCTURES.
7. THE CONTRACTOR SHALL BE RESPONSIBLE FOR THE PROTECTION AND PRESERVATION OF ALL EXISTING UTILITIES AND STRUCTURES.
8. THE CONTRACTOR SHALL BE RESPONSIBLE FOR THE PROTECTION AND PRESERVATION OF ALL EXISTING UTILITIES AND STRUCTURES.
9. THE CONTRACTOR SHALL BE RESPONSIBLE FOR THE PROTECTION AND PRESERVATION OF ALL EXISTING UTILITIES AND STRUCTURES.


CONFORME & ACCEPTED BY:
CONTRACTOR

PIPING THIRD FLOOR SYSTEM 1

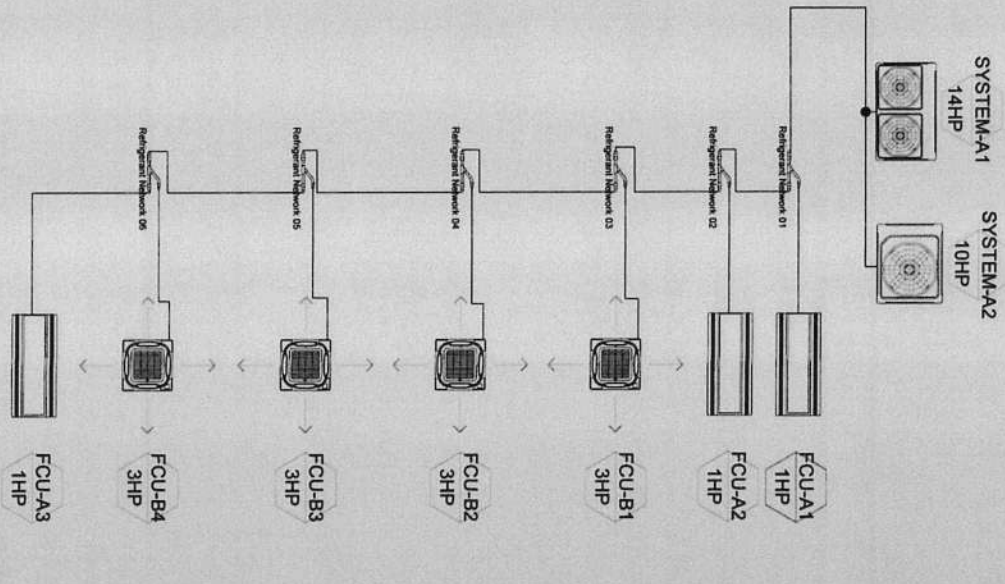


PIPING THIRD FLOOR SYSTEM 2

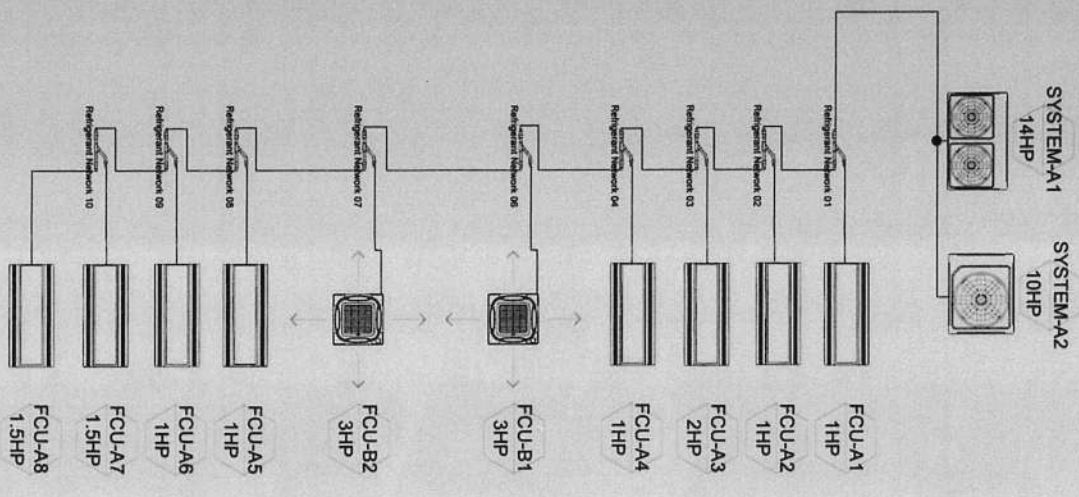


 <p>REPUBLIC OF THE PHILIPPINES CITY OF PASIG OFFICE OF THE MAYOR CITY ENGINEERING OFFICE</p>	<p>PROJECT TITLE PROPOSED EXPANSION W/ IMPROVEMENT WORKS AT PASIG CITY CHILDREN'S HOSPITAL</p> <p>LOCATION: INDUSTRIAL CORNER OF CALAYAN JOSE STS.</p>	<p>PROJECT IN CHARGE ENGR. CHRISTOPHER EDICTO C. SOLLOMON ENGR. EDUARDO M. BARBUOLA JR. ENGR. JOYNTI M. CORTES</p>	<p>PROGRAMMING AND CONSTRUCTION ENGR. JOSE L. TOLON ENGR. JUAN T. CORTES</p>	<p>RECOMMENDING APPROVAL ENGR. JUAN T. CORTES</p>	<p>ENGR. ARTAVARDES V. GERONIMO CITY ENGINEERING OFFICE</p>	<p>APPROVED BY: VICTOR MA. REGIS N. SOTTO CITY MAYOR</p>	<p>SHEET CONTENT: AIR-CONDITIONING SYSTEM DETAILS SHEET NO.: M 3773 CONFORME & ACCEPTED BY: CONTRACTOR</p>
--	---	--	--	---	---	--	--

1. NO ALTERATION IN LOADS & BRIDGE PLACEMENTS SHALL BE MADE
2. IF EXISTING OR NEW BRIDGE OR STRUCTURE IS TO BE CONSTRUCTED, THE CONTRACTOR SHALL BE RESPONSIBLE FOR THE DESIGN & CONSTRUCTION OF THE BRIDGE
3. IN CASE OF DISCREPANCY IN THE DRAWINGS, THE MATTER SHALL BE SETTLED INTERNALLY
4. TO THE EXTENT OF THE DRAWINGS, THE CONTRACTOR SHALL BE RESPONSIBLE FOR THE DESIGN & CONSTRUCTION OF THE BRIDGE
5. THE CONTRACTOR SHALL BE RESPONSIBLE FOR THE DESIGN & CONSTRUCTION OF THE BRIDGE
6. THE CONTRACTOR SHALL BE RESPONSIBLE FOR THE DESIGN & CONSTRUCTION OF THE BRIDGE

FOURTH FLOOR SYSTEM 1

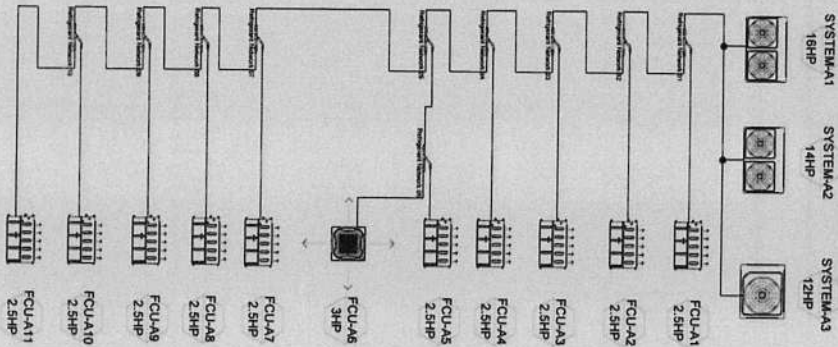

FOURTH FLOOR SYSTEM 2

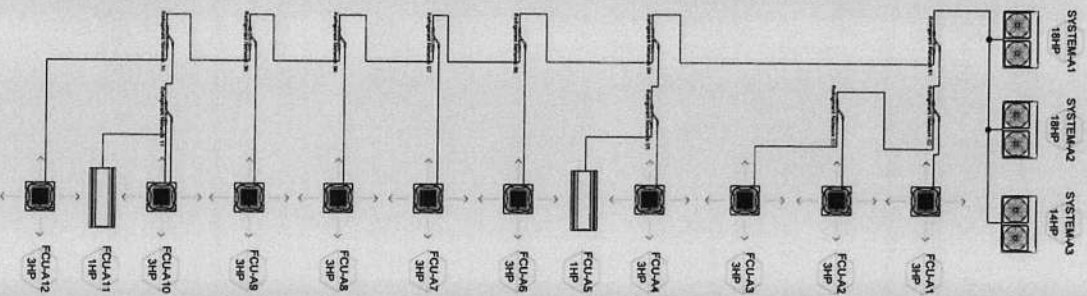

REPUBLIC OF THE PHILIPPINES
CITY OF PASIG
OFFICE OF THE MAYOR
CITY ENGINEERING OFFICE

PROJECT TITLE:

PROPOSED EXPANSION W/
IMPROVEMENT WORKS AT
PASIG CITY CHILDREN'S HOSPITAL

PROJECT IN CHARGE:

ENGR. CHRISTOPHER M. SOROLONG
ENGR. EDUARDO C. BARRERA JR.
ENGR. JOSEPH S. SORIANO T. CORTES

PROGRAMMING AND CONSTRUCTION:

ENGR. LUIS L. TIRON
ENGR. LUIS L. TIRON

RECOMMENDING APPROVAL:

ENGR. ALBERTO S. RUIZ
ENGR. ARTAVERDE V. GERONIMO

APPROVED BY:

VICTOR MA. REGIS N. SOTTO
CITY MAYOR

SHEET NO. 38173

ARCONITON SYSTEM DETAILS


CONFIRMED & ACCEPTED BY

CONTRACTOR


IMPORTANT NOTES:

1. SO A CONTRACTOR SHALL BE RESPONSIBLE FOR THE PROVISION OF ALL MATERIALS AND LABORERS TO BE USED IN THE CONSTRUCTION OF THE STRUCTURE.
2. CONTRACTOR SHALL BE RESPONSIBLE FOR THE PROVISION OF ALL MATERIALS AND LABORERS TO BE USED IN THE CONSTRUCTION OF THE STRUCTURE.
3. IN CASE OF ANY DISCREPANCY OR AMBIGUITY IN THE DRAWINGS, THE CONTRACTOR SHALL BE RESPONSIBLE FOR THE CLARIFICATION OF THE SAME.
4. APPROVAL OF THE CONTRACTOR SHALL BE OBTAINED AT THE EXPENSE OF THE CONTRACTOR.
5. THERE IS NO WARRANTY FOR THE DESIGN OR CONSTRUCTION OF THE PROJECT AT ALL.
6. CONTRACTOR SHALL BE RESPONSIBLE FOR THE PROVISION OF ALL MATERIALS AND LABORERS TO BE USED IN THE CONSTRUCTION OF THE STRUCTURE.

FIFTH FLOOR SYSTEM 1

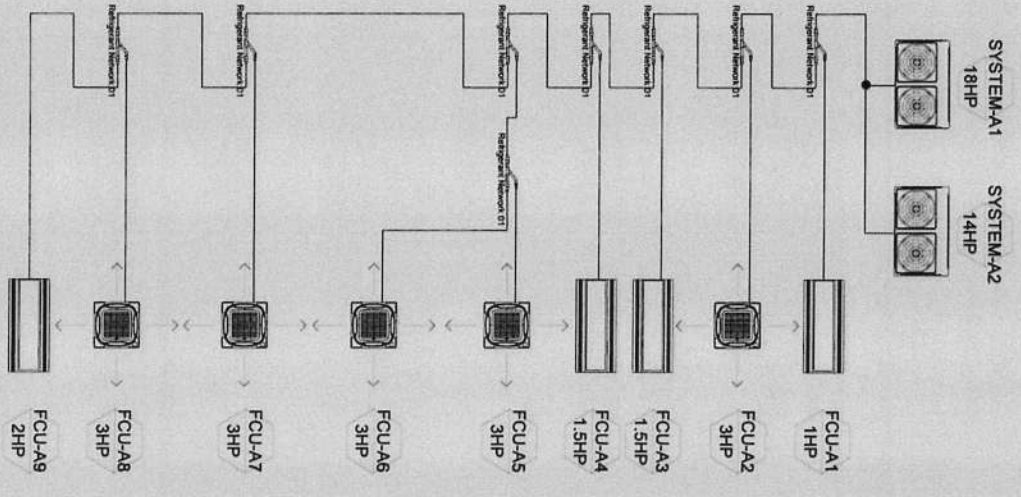

FIFTH FLOOR SYSTEM 3

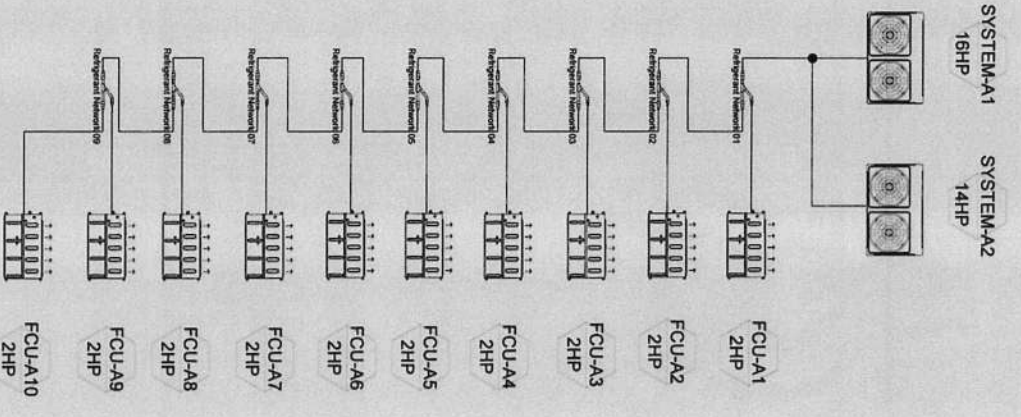

REPUBLIC OF THE PHILIPPINES
CITY OF PASIG
OFFICE OF THE MAYOR
CITY ENGINEERING OFFICE

PROJECT TITLE:
PROPOSED EXPANSION W/
IMPROVEMENT WORKS AT
PASIG CITY CHILDREN'S HOSPITAL

PROJECT IN CHARGE:
ENGR. CHRISTOPHER C. SOLACION
ENGR. EDUARDO G. BARROCA, JR.
ENGR. JOYNTA T. CORTES

PROGRAMMING AND CONSTRUCTION:
ENGR. JONEL L. TIZON
ENGR. SYRICAL V. MALABON

RECOMMENDING APPROVAL:
ENGR. CARMEN B. PRUDENCIO
ENGR. ARTAVERTES V. GERONIMO

APPROVED BY:
VICTOR MA. REGIS N. SOTTO
CITY MAYOR




SHEET CONTENT:
AIR-CONDITION
SYSTEM DETAILS

SHEET NO.:
M
39/73

CONTRACTOR: CONFORME & ACCEPTED BY:

IMPORTANT NOTES:
1. NO ALTERATION IN ANY OF THE SPECIFICATIONS SHALL BE MADE WITHOUT THE PRIOR APPROVAL OF THE ARCHITECT AND ENGINEER.
2. IN ANY CASE THE CONTRACTOR SHALL BE RESPONSIBLE FOR THE PROTECTION OF THE EXISTING UTILITIES AND STRUCTURES.
3. RECORD OF DIMENSIONS AND THE POSITION OF THE UTILITIES SHALL BE MADE BY THE CONTRACTOR AND SHALL BE MADE BY THE CONTRACTOR.
4. THE LOCATION OF THIS RESTRICTION SHALL BE COMPLETED AT THE EXPENSE OF THE CONTRACTOR.

CONTRACTOR

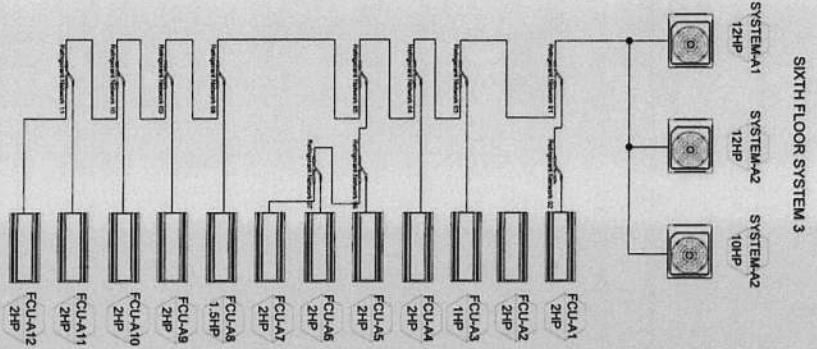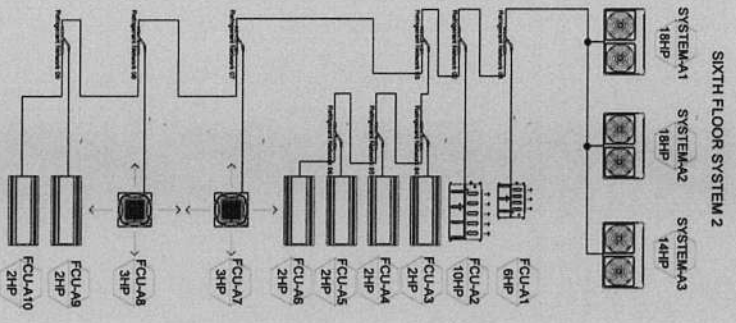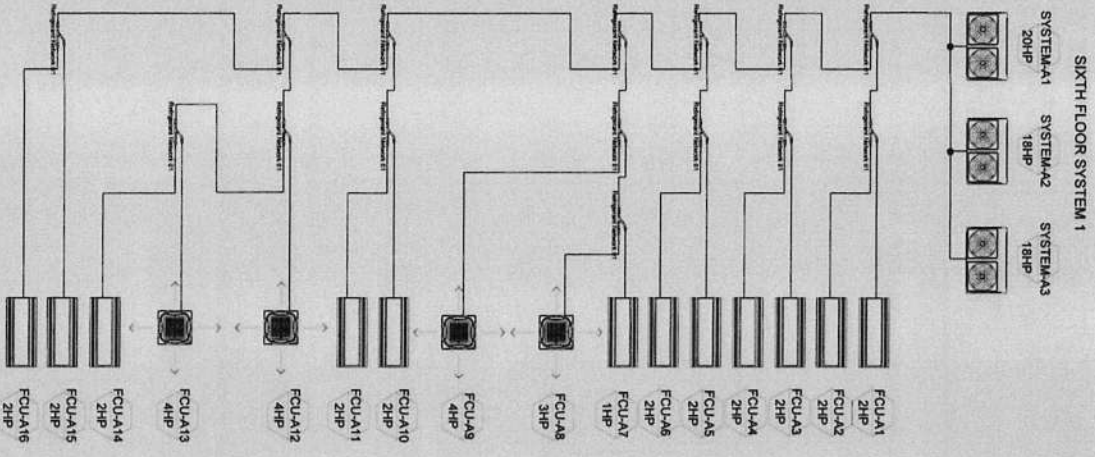

REPUBLIC OF THE PHILIPPINES
CITY OF PASIG
OFFICE OF THE MAYOR
CITY ENGINEERING OFFICE

PROJECT TITLE
**PROPOSED EXPANSION W/
IMPROVEMENT WORKS AT
PASIG CITY CHILDREN'S HOSPITAL**

LOCATION: **INGENIEROS DE ALCAZAR ROSE STS.
MAYORSDAL PASIG CITY**

PROJECT IN CHARGE
ENGR. CHRISTOPHER B. SOLACION
ENGR. EXPANZO G. BARRERA, JR.

PROGRAMMING AND CONSTRUCTION
ENGR. CECILIA BELLA
ENGR. JOSE L. TIZON

RECOMMENDING APPROVAL
ENGR. LARRY E. B. PRUDENCIO
ENGR. ARTAMEROS V. GERONIMO


APPROVED BY:
VICTOR MA. NEGIS N. SOTTO
CITY MAYOR

SHEET NO.:
4073

SHEET CONTENT:
AIR-CONDITIONING SYSTEM REVISED

IMPORTANT NOTES:
1. NO PART OF THIS PROJECT SHALL BE CONSIDERED AS A BASIS FOR ANY OTHER PROJECTS.
2. THE CONTRACTOR SHALL BE RESPONSIBLE FOR THE PROTECTION OF THE EXISTING UTILITIES AND STRUCTURES.
3. THE CONTRACTOR SHALL BE RESPONSIBLE FOR THE PROTECTION OF THE EXISTING UTILITIES AND STRUCTURES.
4. THE CONTRACTOR SHALL BE RESPONSIBLE FOR THE PROTECTION OF THE EXISTING UTILITIES AND STRUCTURES.
5. THE CONTRACTOR SHALL BE RESPONSIBLE FOR THE PROTECTION OF THE EXISTING UTILITIES AND STRUCTURES.
6. THE CONTRACTOR SHALL BE RESPONSIBLE FOR THE PROTECTION OF THE EXISTING UTILITIES AND STRUCTURES.
7. THE CONTRACTOR SHALL BE RESPONSIBLE FOR THE PROTECTION OF THE EXISTING UTILITIES AND STRUCTURES.
8. THE CONTRACTOR SHALL BE RESPONSIBLE FOR THE PROTECTION OF THE EXISTING UTILITIES AND STRUCTURES.
9. THE CONTRACTOR SHALL BE RESPONSIBLE FOR THE PROTECTION OF THE EXISTING UTILITIES AND STRUCTURES.

CONTRACTOR

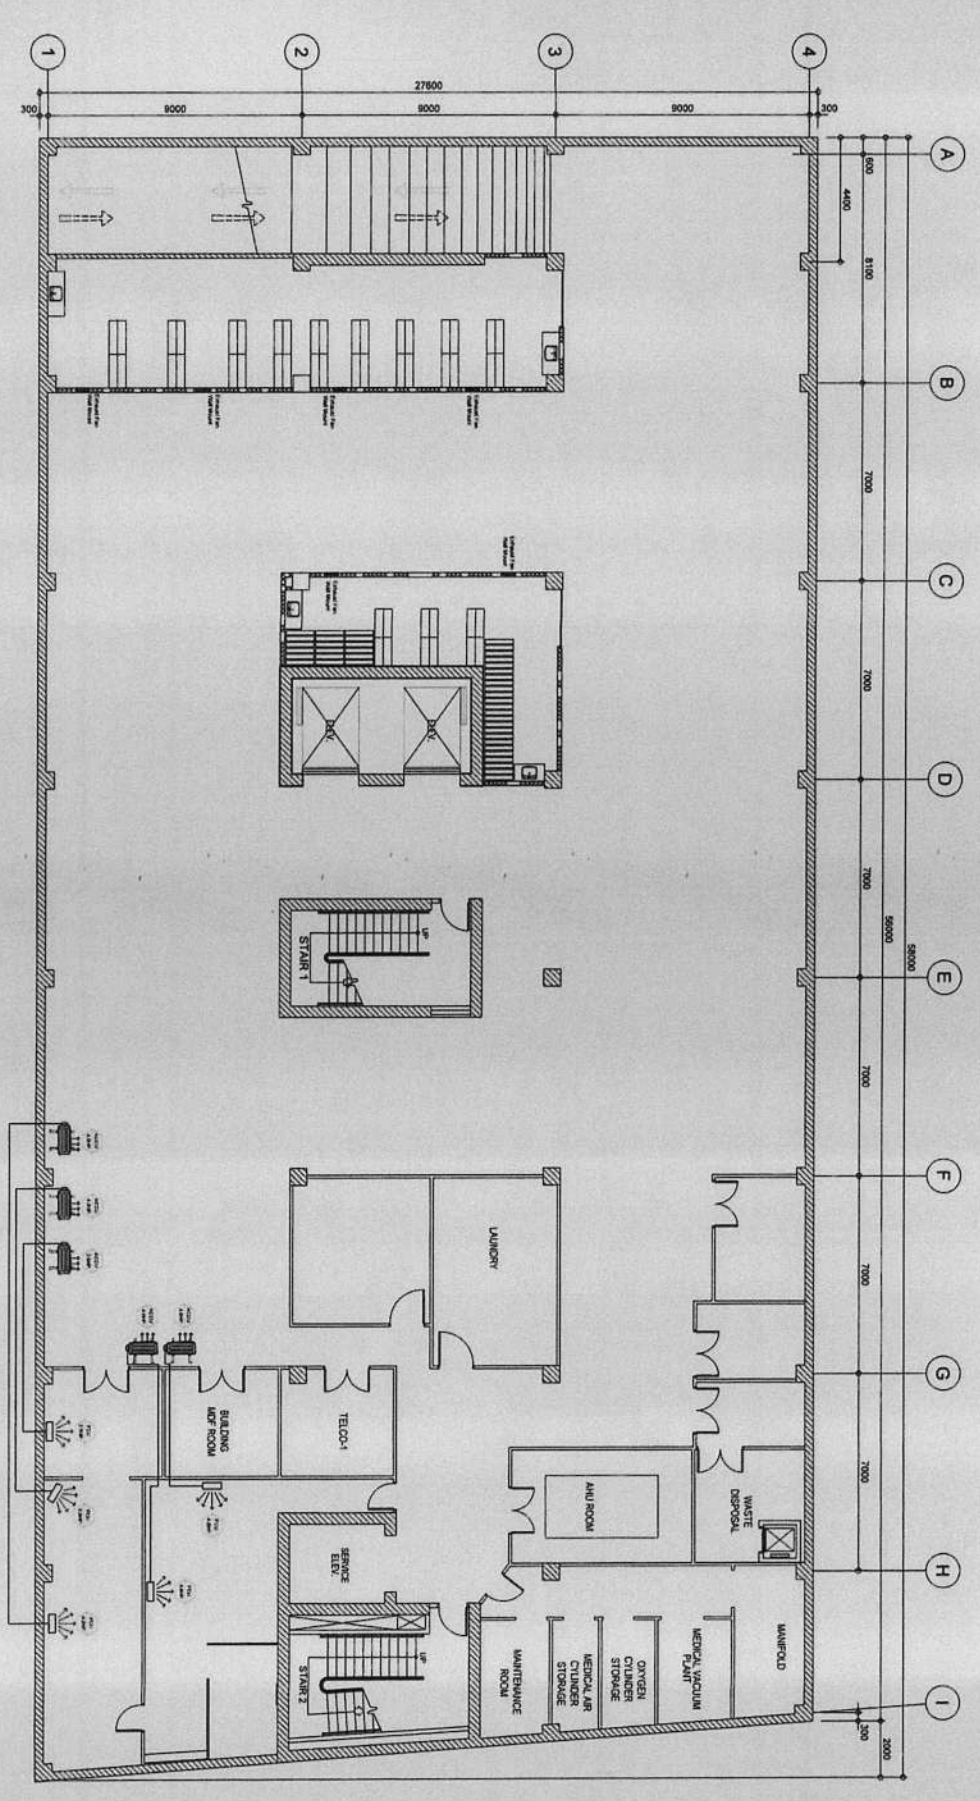


PROPOSED REPAIR WORKS
BASEMENT AIRCONDITION LAYOUT
 SCALE 1:1000

SCOPE OF WORKS:
 1. Installation of Split Type Aircondition Units, Inverter Type.

	REPUBLIC OF THE PHILIPPINES CITY OF PASIG OFFICE OF THE MAYOR CITY ENGINEERING OFFICE	PROJECT TITLE PROPOSED EXPANSION W/ IMPROVEMENT WORKS AT PASIG CITY CHILDREN'S HOSPITAL	PROJECT IN CHARGE ENGR. <i>Cheslyn Benedict C. Solomon</i> ENGR. EDUARDO GABARRUCIA, JR. ENGR. JOHN JESHA T. CORTES	PROGRAMMING AND CONSTRUCTION ENGR. <i>Cheslyn Benedict C. Solomon</i> ENGR. JOHN JESHA T. CORTES	RECOMMENDING APPROVAL ENGR. <i>Artayernes V. Geromino</i> ENGR. ARTAYERNES V. GEROMINO CITY ENGINEERING OFFICE	APPROVED BY: VICTOR MA. REGIS N. SOTTO CITY MAYOR	SHEET CONTENT: AIRCONDITION LAYOUT	SHEET NO. M 4173
	LOCATION: INDUSTRIAL CORP. ALCALDE JOSE STS., PASIG CITY	1. THE CONTRACTOR SHALL BE RESPONSIBLE FOR THE PROTECTION OF ALL EXISTING UTILITIES AND STRUCTURES TO REMAIN. 2. THE CONTRACTOR SHALL BE RESPONSIBLE FOR THE PROTECTION OF ALL EXISTING UTILITIES AND STRUCTURES TO REMAIN. 3. THE CONTRACTOR SHALL BE RESPONSIBLE FOR THE PROTECTION OF ALL EXISTING UTILITIES AND STRUCTURES TO REMAIN. 4. THE CONTRACTOR SHALL BE RESPONSIBLE FOR THE PROTECTION OF ALL EXISTING UTILITIES AND STRUCTURES TO REMAIN. 5. THE CONTRACTOR SHALL BE RESPONSIBLE FOR THE PROTECTION OF ALL EXISTING UTILITIES AND STRUCTURES TO REMAIN.	CONTRACTOR					

CONFORME & ACCEPTED BY:
 CONTRACTOR

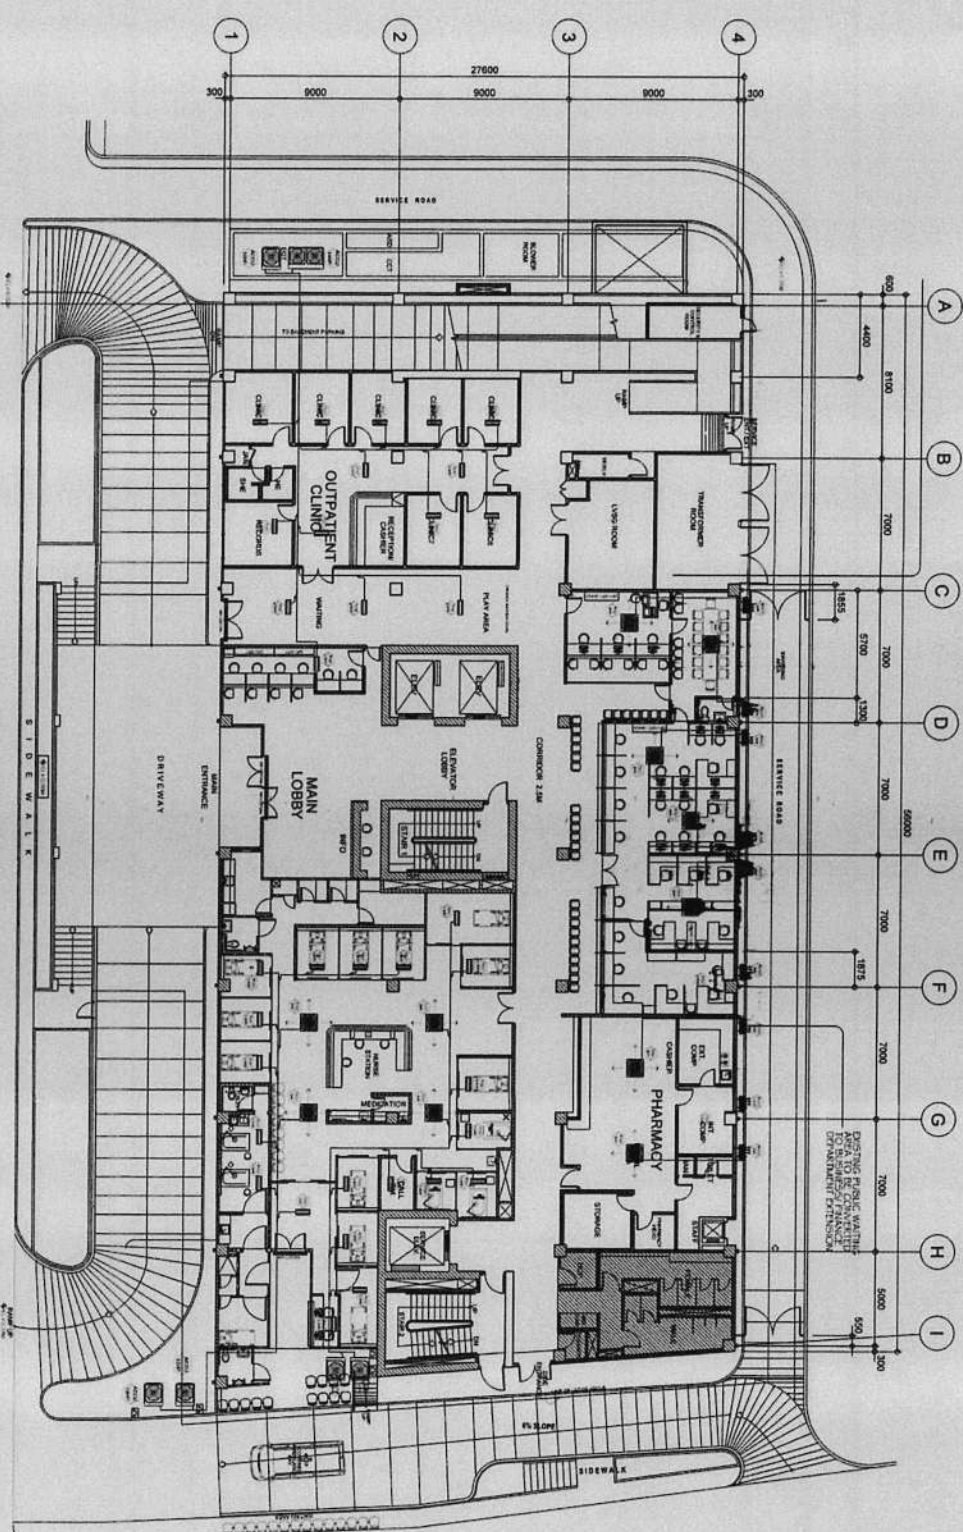


PROPOSED REPAIR WORKS
GROUND FLOOR AIRCONDITION LAYOUT
SCALE: 1/8" = 1'-0"

- SCOPE OF WORKS:
1. Installation of VRF / VRF Type of Aircondition System
 2. Installation of ceiling aircon ducting
 3. Installation of ECDBs for FCU units
 4. Use IMC pipe for required wiring installation
 5. All electrical wiring shall be installed in separate conduit
 6. All electrical wiring shall be installed in separate conduit

	REPUBLIC OF THE PHILIPPINES CITY OF PASIG OFFICE OF THE MAYOR CITY ENGINEERING OFFICE	PROJECT TITLE PROPOSED EXPANSION W/ IMPROVEMENT WORKS AT PASIG CITY CHILDREN'S HOSPITAL	PROJECT IN CHARGE ENGR. CHRISTOPHER C. SOLACION ENGR. CHRYSTAL BELLA ENGR. OFFICE L. TIRON	PROGRAMMING AND CONSTRUCTION ENGR. JUAN B. PRUDENCIO ENGR. ASTAVERES V. GERONIMO	RECOMMENDING APPROVAL ENGR. JUAN B. PRUDENCIO ENGR. ASTAVERES V. GERONIMO	APPROVED BY: VICTOR M. REGIS N. SOTTO CITY ENGINEER	SHEET CONTENT: AIRCONDITION LAYOUT	SHEET NO.: M 4273
	LOCATION: INDUSTRIAL COR. ALCALDE JOSE STS. PASIG CITY	PROJECTING ENGINEER: ENGR. JOYCE T. COCHES ENGR. JUAN B. PRUDENCIO ENGR. ASTAVERES V. GERONIMO	PROGRAMMING AND CONSTRUCTION ENGR. JUAN B. PRUDENCIO ENGR. ASTAVERES V. GERONIMO	RECOMMENDING APPROVAL ENGR. JUAN B. PRUDENCIO ENGR. ASTAVERES V. GERONIMO	APPROVED BY: VICTOR M. REGIS N. SOTTO CITY ENGINEER	SHEET CONTENT: AIRCONDITION LAYOUT	SHEET NO.: M 4273	

CONTRACTOR

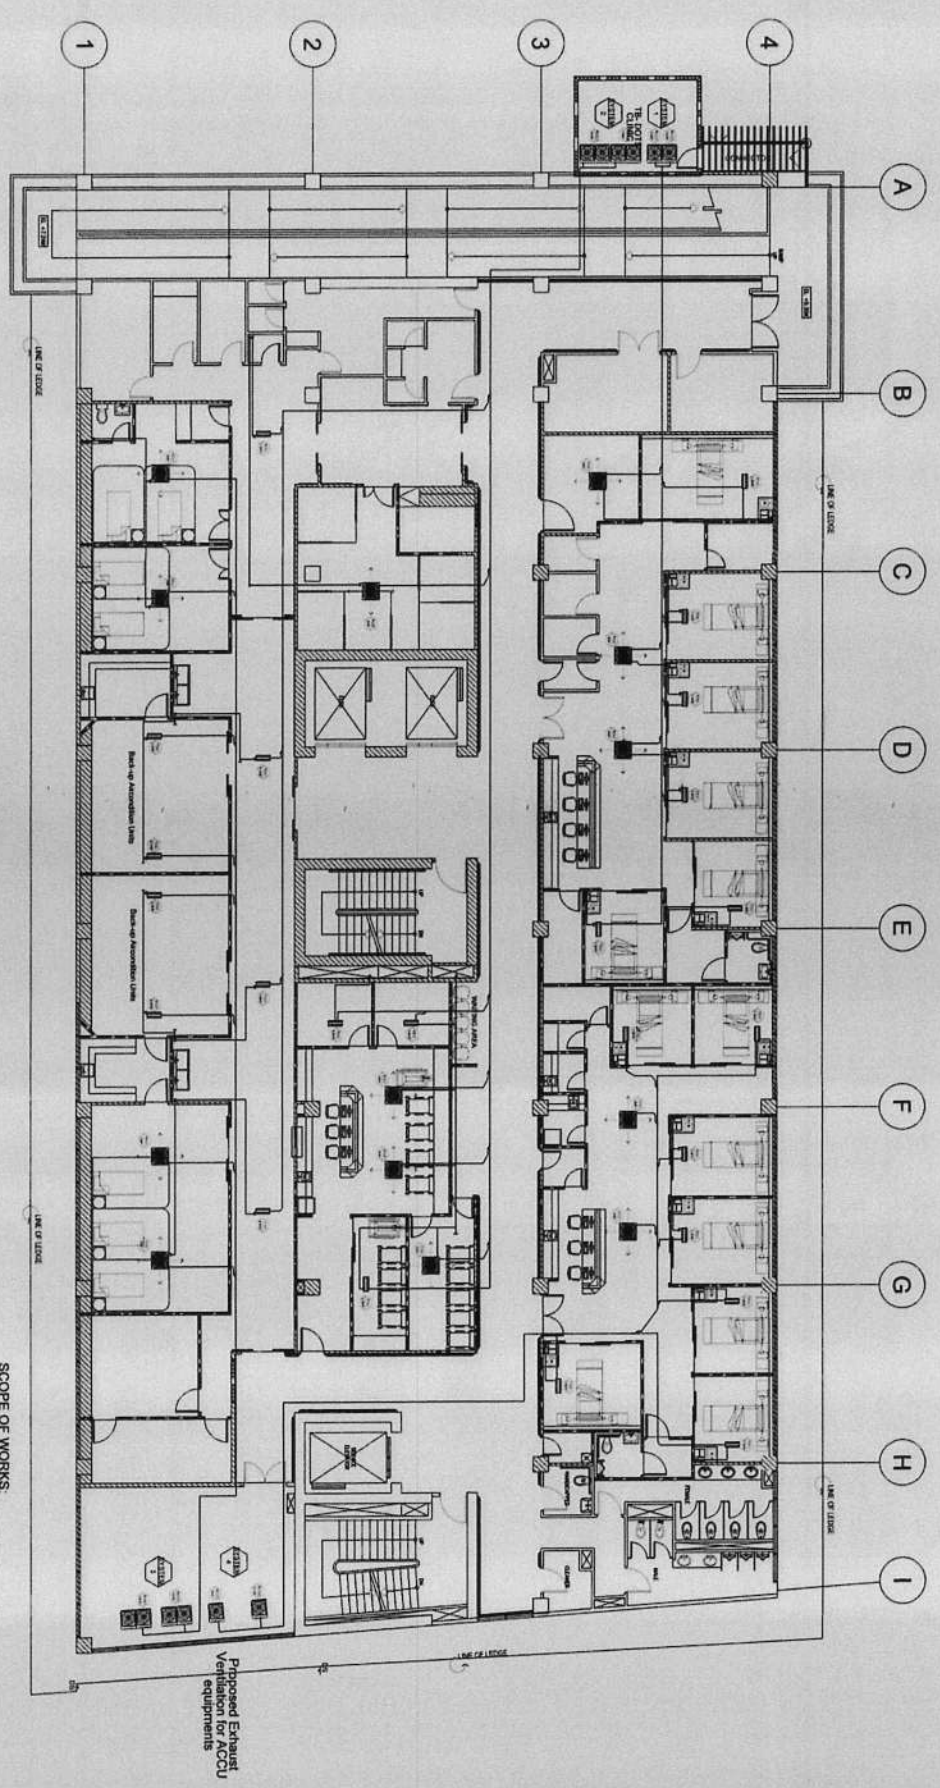

WITH PROPOSED REPAIR WORKS
SECOND FLOOR AIRCONDITION LAYOUT


- SCOPE OF WORKS:**
1. Installation of VRV / VRF Type of Aircondition System.
 2. Dismantling of existing aircon ducting.
 3. Installation of ECBS for FCU units.
 4. Use IMC pipe for exposed wiring installation.
 5. Installation of Condensate Drain System (CDS) shall be separated from other Sanitary Piping System.

	REPUBLIC OF THE PHILIPPINES CITY OF PASIG OFFICE OF THE MAYOR CITY ENGINEERING OFFICE	PROJECT TITLE: PROPOSED EXPANSION W/ IMPROVEMENT WORKS AT PASIG CITY CHILDREN'S HOSPITAL	PROJECT IN CHARGE: ENGR. CHRISTIAN BENEDECT C. SOLOMON ENGR. EDUARDO R. GARRIGA JR. ENGR. JOHN MARVIN T. CORTES	PROGRAMMING AND CONSTRUCTION: ENGR. DONALD BELAN ENGR. JONAS L. TITON ENGR. JONAS L. TITON OC. TECHNICAL SUPERVISION SECTION	RECOMMENDING APPROVAL: ENGR. JOSEPH B. RUIRUCIO ENGR. ARTABERKES V. GERONIMO	APPROVED BY: VICTOR MA. REGIS N. SOTTO CITY MAYOR	SHEET CONTENT: AIRCONDITION LAYOUT	SHEET NO.: M 4373
	PROJECT LOCATION: INDUSTRIAL CORP. AL CALDER JOSE STS. INDUSTRIAL PASIG CITY	PROJECT NO. 1 PROJECT NO. 2 PROJECT NO. 3 PROJECT NO. 4	PROJECT NO. 1 PROJECT NO. 2 PROJECT NO. 3 PROJECT NO. 4	PROJECT NO. 1 PROJECT NO. 2 PROJECT NO. 3 PROJECT NO. 4	PROJECT NO. 1 PROJECT NO. 2 PROJECT NO. 3 PROJECT NO. 4	PROJECT NO. 1 PROJECT NO. 2 PROJECT NO. 3 PROJECT NO. 4	PROJECT NO. 1 PROJECT NO. 2 PROJECT NO. 3 PROJECT NO. 4	PROJECT NO. 1 PROJECT NO. 2 PROJECT NO. 3 PROJECT NO. 4

IMPORTANT NOTES:

1. NO ALTERATION IN ANY SERVICE CONNECTIONS SHALL BE MADE WITHOUT THE PRIOR APPROVAL OF THE PROJECT NO. 1 AND PROJECT NO. 2.
2. PROJECT NO. 3 AND PROJECT NO. 4 SHALL BE CONSIDERED AS SEPARATE PROJECTS AND SHALL BE IDENTIFIED AS SUCH.
3. THE SCOPE OF WORKS SHOWN IN THIS DRAWING SHALL BE CONSIDERED AS THE BASIS FOR THE CONTRACTOR TO EXECUTE THE WORK.
4. THE SCOPE OF WORKS SHOWN IN THIS DRAWING SHALL BE CONSIDERED AS THE BASIS FOR THE CONTRACTOR TO EXECUTE THE WORK.
5. THE SCOPE OF WORKS SHOWN IN THIS DRAWING SHALL BE CONSIDERED AS THE BASIS FOR THE CONTRACTOR TO EXECUTE THE WORK.
6. THE SCOPE OF WORKS SHOWN IN THIS DRAWING SHALL BE CONSIDERED AS THE BASIS FOR THE CONTRACTOR TO EXECUTE THE WORK.


CONTRACTOR

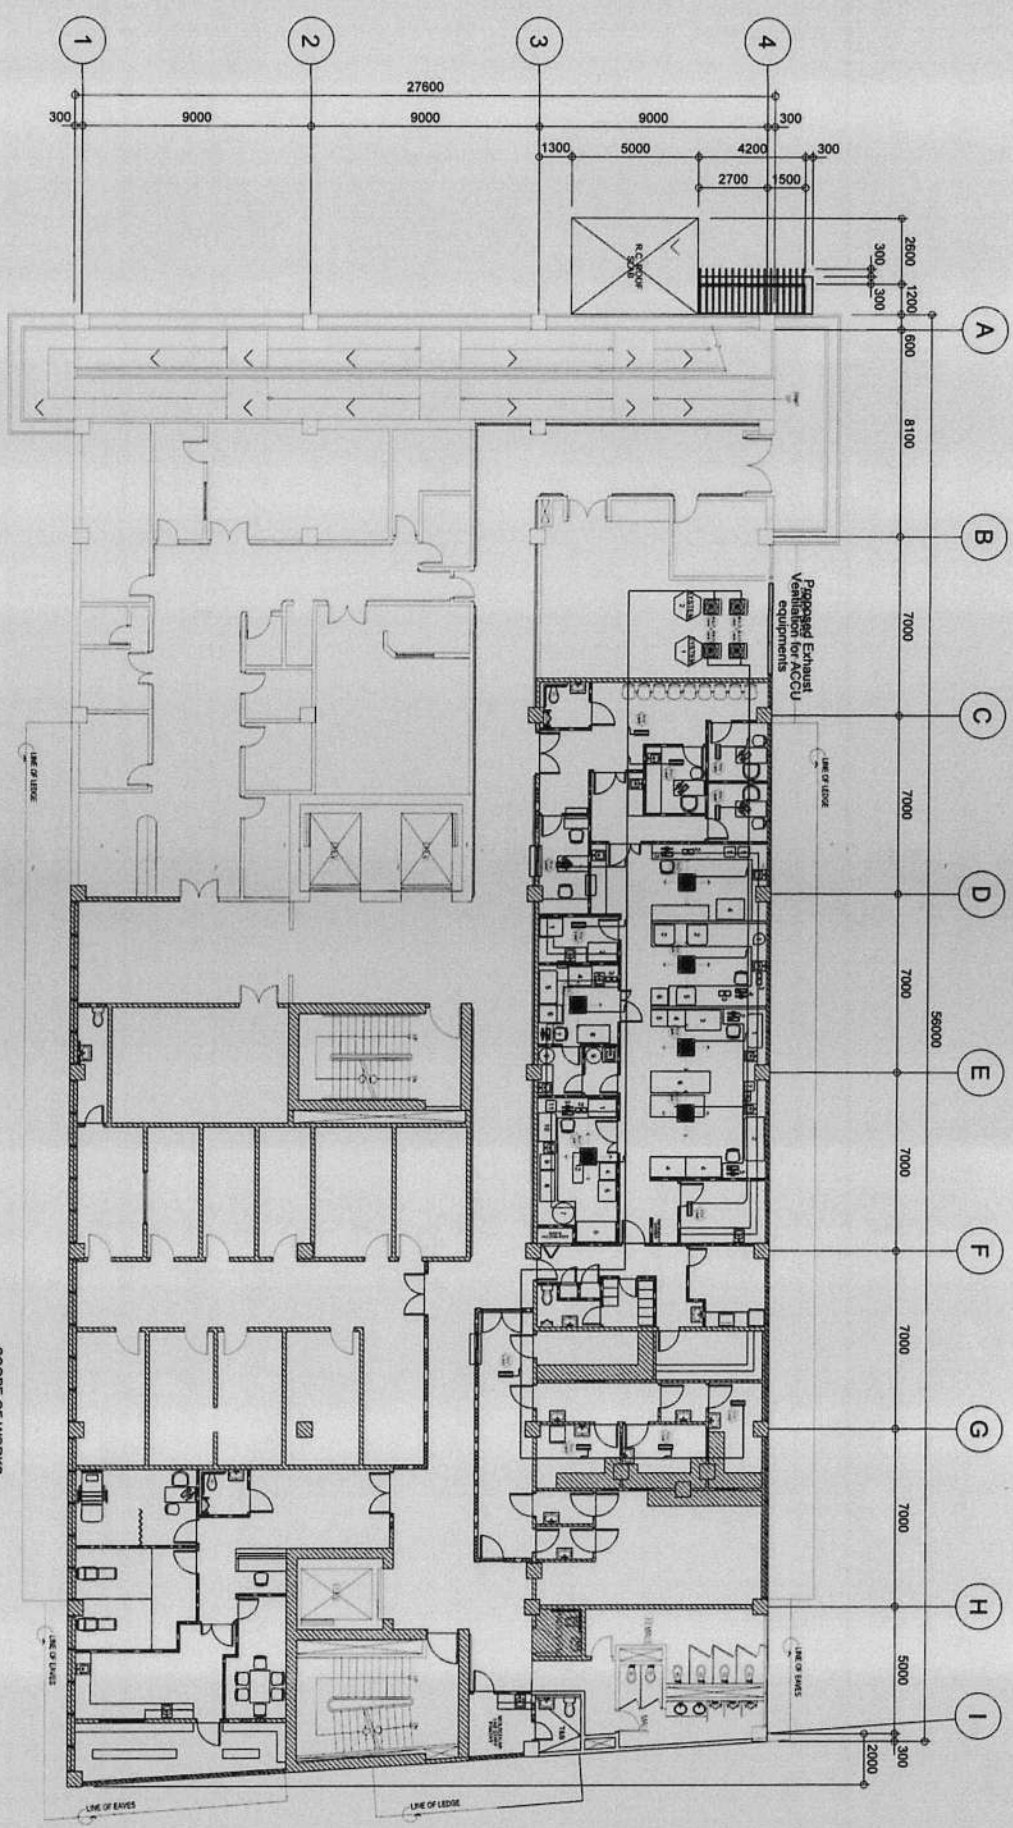

WITH PROPOSED REPAIR WORKS
 THIRD FLOOR AIRCONDITION LAYOUT


- SCOPE OF WORKS:
1. Installation of VRV / VRF Type of Aircondition System.
 2. Dismantling of existing aircon ducting.
 3. Installation of ECBS for FCU units.
 4. Use IMC pipe for exposed wiring installation.
 5. Installation of Condensate Drain System (CDS) shall be separated from other Sanitary Piping System.

	REPUBLIC OF THE PHILIPPINES CITY OF PASIG OFFICE OF THE MAYOR CITY ENGINEERING OFFICE	PROJECT TITLE: PROPOSED EXPANSION W/ IMPROVEMENT WORKS AT PASIG CITY CHILDREN'S HOSPITAL	PROJECT IN CHARGE: ENGR. CHEMUNDO, HEDICT C. SOLOMON ENGR. EDUARDO, DANIELA JR. ENGR. JOYAN, JUAN I. CORTEZ	PROGRAMMING AND CONSTRUCTION: ENGR. JORGE L. TIZON ENGR. JUANITA, MARICRISTINE SECTION	RECOMMENDING APPROVAL: ENGR. LAURENCE B. PRUDENCIO ENGR. ARTAXERDES V. GERONIMO	APPROVED BY: VICTOR M.A. REGIS, N. SOTTO CITY MAYOR	SHEET CONTENT: AIRCONDITION LAYOUT	SHEET NO.:
	IMPORTANT NOTES: 1. NO ALTERATION IN PLUMBING AND ELECTRICAL WORK SHALL BE MADE WITHOUT THE APPROVAL OF THE ARCHITECT'S OFFICE. 2. IF ANY CASE OF THE CONTRACTOR'S NEGLIGENCE OR MISFEASANCE IN THE PERFORMANCE OF HIS DUTY, HE SHALL BE HELD RESPONSIBLE THEREFOR. 3. THE CONTRACTOR SHALL BE RESPONSIBLE FOR THE PROTECTION OF THE EXISTING UTILITIES AND STRUCTURES. 4. THE CONTRACTOR SHALL BE RESPONSIBLE FOR THE PROTECTION OF THE EXISTING UTILITIES AND STRUCTURES. 5. THE CONTRACTOR SHALL BE RESPONSIBLE FOR THE PROTECTION OF THE EXISTING UTILITIES AND STRUCTURES. 6. THE CONTRACTOR SHALL BE RESPONSIBLE FOR THE PROTECTION OF THE EXISTING UTILITIES AND STRUCTURES.	CONTRACTOR & ACCEPTED BY: CONTRACTOR						

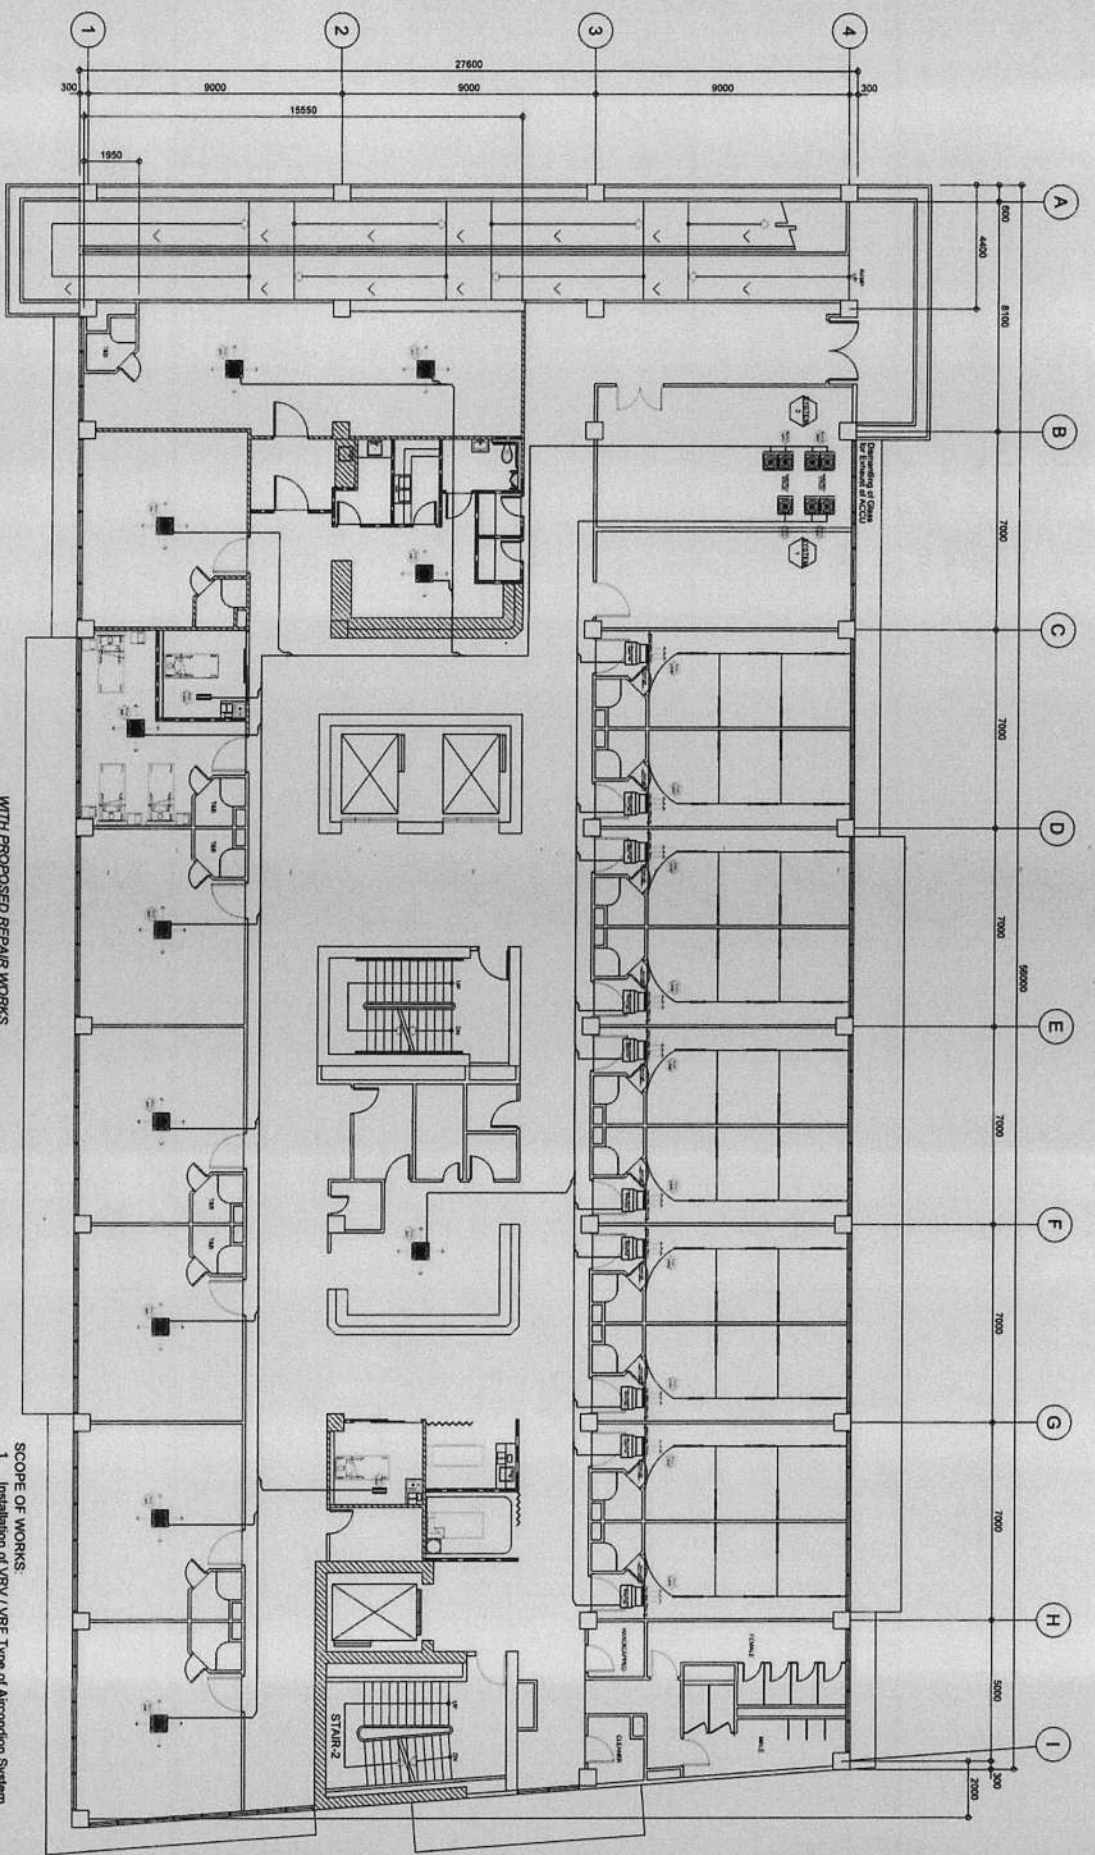

WITH PROPOSED REPAIR WORKS
FOURTH FLOOR AIRCONDITION LAYOUT
 01
 A 01
 SCALE
 1:100

- SCOPE OF WORKS:**
1. Installation of VRF / VRF Type of Aircondition System.
 2. Demantling of existing aircon ducting.
 3. Installation of ECBS for FOU units.
 4. Use IMC pipe for exposed wiring installation.
 5. Installation of Condensate Drain System (CDS) shall be separated from other Sanitary Piping System.

 REPUBLIC OF THE PHILIPPINES CITY OF PASIG OFFICE OF THE MAJOR CITY ENGINEERING OFFICE	PROJECT TITLE PROPOSED EXPANSION W/ IMPROVEMENT WORKS AT PASIG CITY CHILDRENS HOSPITAL LOCATION: INDUSTRIAL COR. ASAGUE JOSE ETS. NAVASINGA PASIG CITY	PROJECT IN CHARGE ENGR. CHANGING DEFLECT C SOLUJON ENGR. EDUARDO G. BARRERA JR. PASIG CITY	PROGRAMMING AND CONSTRUCTION ENGR. CASALTI BELLIN ENGR. JORGE L. TRON OC. ELECTRICAL INFRASTRUCTURE SECTION	RECOMMENDING APPROVAL ENGR. LARSENTE S. PRUDENCIO OC. CITY ENGINEERING OFFICE	APPROVED BY: VICTOR MA. REGIS N. SOTTO CITY MAJOR	SHEET NO. SHEET NO. 4573 M
COMPANIED & ACCEPTED BY: CONTRACTOR						

IMPORTANT NOTES:

1. THE CONTRACTOR SHALL BE RESPONSIBLE FOR THE PROTECTION OF ALL EXISTING UTILITIES AND STRUCTURES.
2. THE CONTRACTOR SHALL BE RESPONSIBLE FOR THE PROTECTION OF ALL EXISTING UTILITIES AND STRUCTURES.
3. TO BE A PART OF THE CONTRACT, THE CONTRACTOR SHALL BE RESPONSIBLE FOR THE PROTECTION OF ALL EXISTING UTILITIES AND STRUCTURES.
4. ANY VIOLATION OF THIS INSTRUCTION SHALL BE CONSIDERED AS A BREACH OF THE CONTRACT.
5. THE CONTRACTOR SHALL BE RESPONSIBLE FOR THE PROTECTION OF ALL EXISTING UTILITIES AND STRUCTURES.



REPUBLIC OF THE PHILIPPINES
CITY OF PASIG
OFFICE OF THE MAYOR
CITY ENGINEERING OFFICE

PROJECT TITLE
**PROPOSED EXPANSION W/
IMPROVEMENT WORKS AT
PASIG CITY CHILDREN'S HOSPITAL**

PROJECT IN CHARGE
ENGR. CHRISTOPHER J. SOLORSON
ENGR. EDUARDO G. BARRERA JR.
ENGR. JOSEPH T. CORTES

PROGRAMMING AND CONSTRUCTION
ENGR. JOSE L. TIZON
ENGR. JOSEPH T. CORTES


RECOMMENDING APPROVAL
ENGR. JAMES S. BARRERA
ENGR. ARTAVERTES V. GERONIMO

APPROVED BY
VICTOR M. REGIS N. SOTTO
CITY MAYOR

SHEET CONTENT
AIRCONDITION
LAYOUT

SHEET NO.
M
467/3


IMPORTANT NOTES:
1. NO ALTERATION IN LINE & AREA OF EXISTING STRUCTURE SHALL BE MADE WITHOUT THE PRIOR APPROVAL OF THE ARCHITECT'S BOARD.
2. CONTRACTOR SHALL BE RESPONSIBLE FOR THE PROTECTION OF EXISTING UTILITIES AND STRUCTURES.
3. TO OBTAIN THE NECESSARY PERMITS AND APPROVALS, THE CONTRACTOR SHALL SUBMIT THE COMPLETE SET OF DRAWINGS TO THE RESPECTIVE AGENCIES.
4. APPROVAL OF THE ARCHITECT SHALL BE CONSIDERED AS THE BASIS FOR THE CONSTRUCTION.
5. THE CONTRACTOR SHALL BE RESPONSIBLE FOR THE PROTECTION OF EXISTING UTILITIES AND STRUCTURES.
6. THE CONTRACTOR SHALL BE RESPONSIBLE FOR THE PROTECTION OF EXISTING UTILITIES AND STRUCTURES.

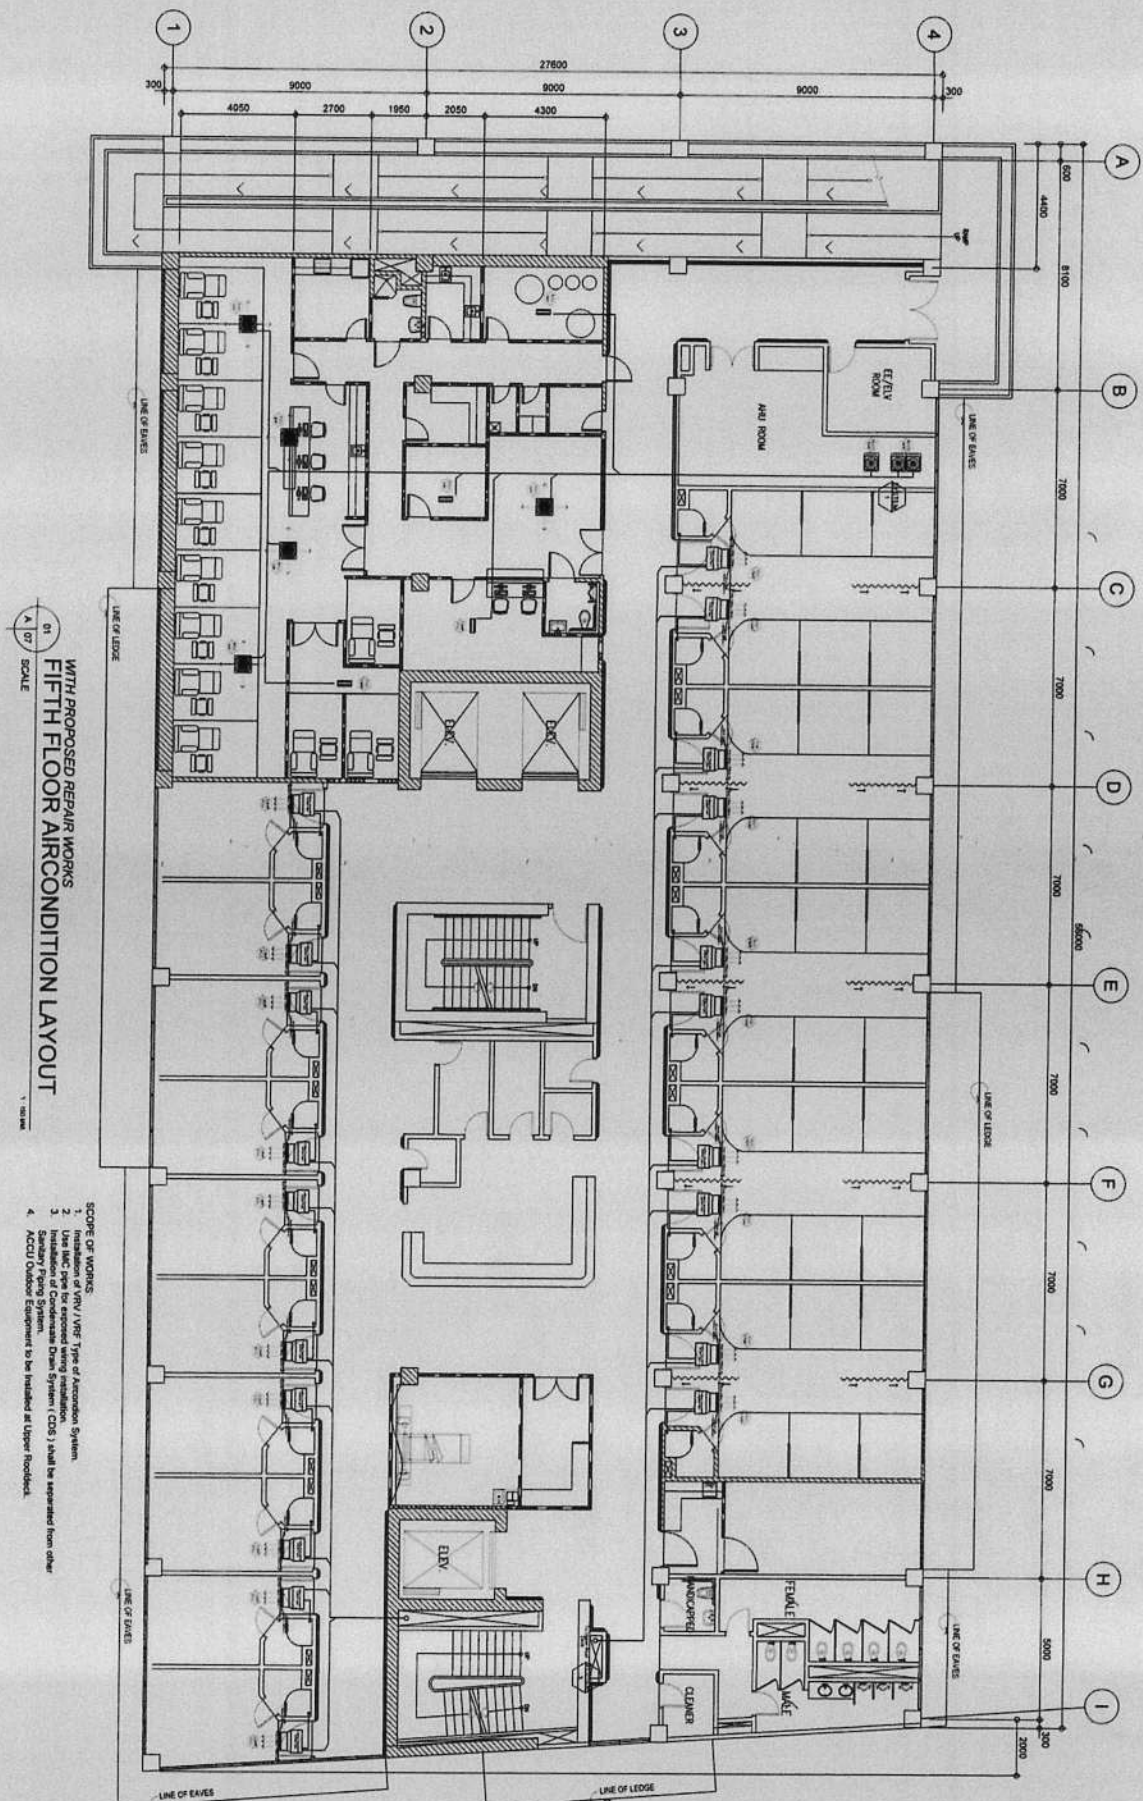

WITH PROPOSED REPAIR WORKS
FIFTH FLOOR AIRCONDITION LAYOUT
1:100 SCALE

- SCOPE OF WORKS:
1. Installation of RTV / VRF Type of Aircondition System.
 2. Use of MAC pipe for exterior wiring installation.
 3. Installation of Condensate Drain System (CDS) shall be separated from other piping system.
 4. ACQU Outdoor Equipment to be installed at Upper Rooftop.

CONTRACTOR

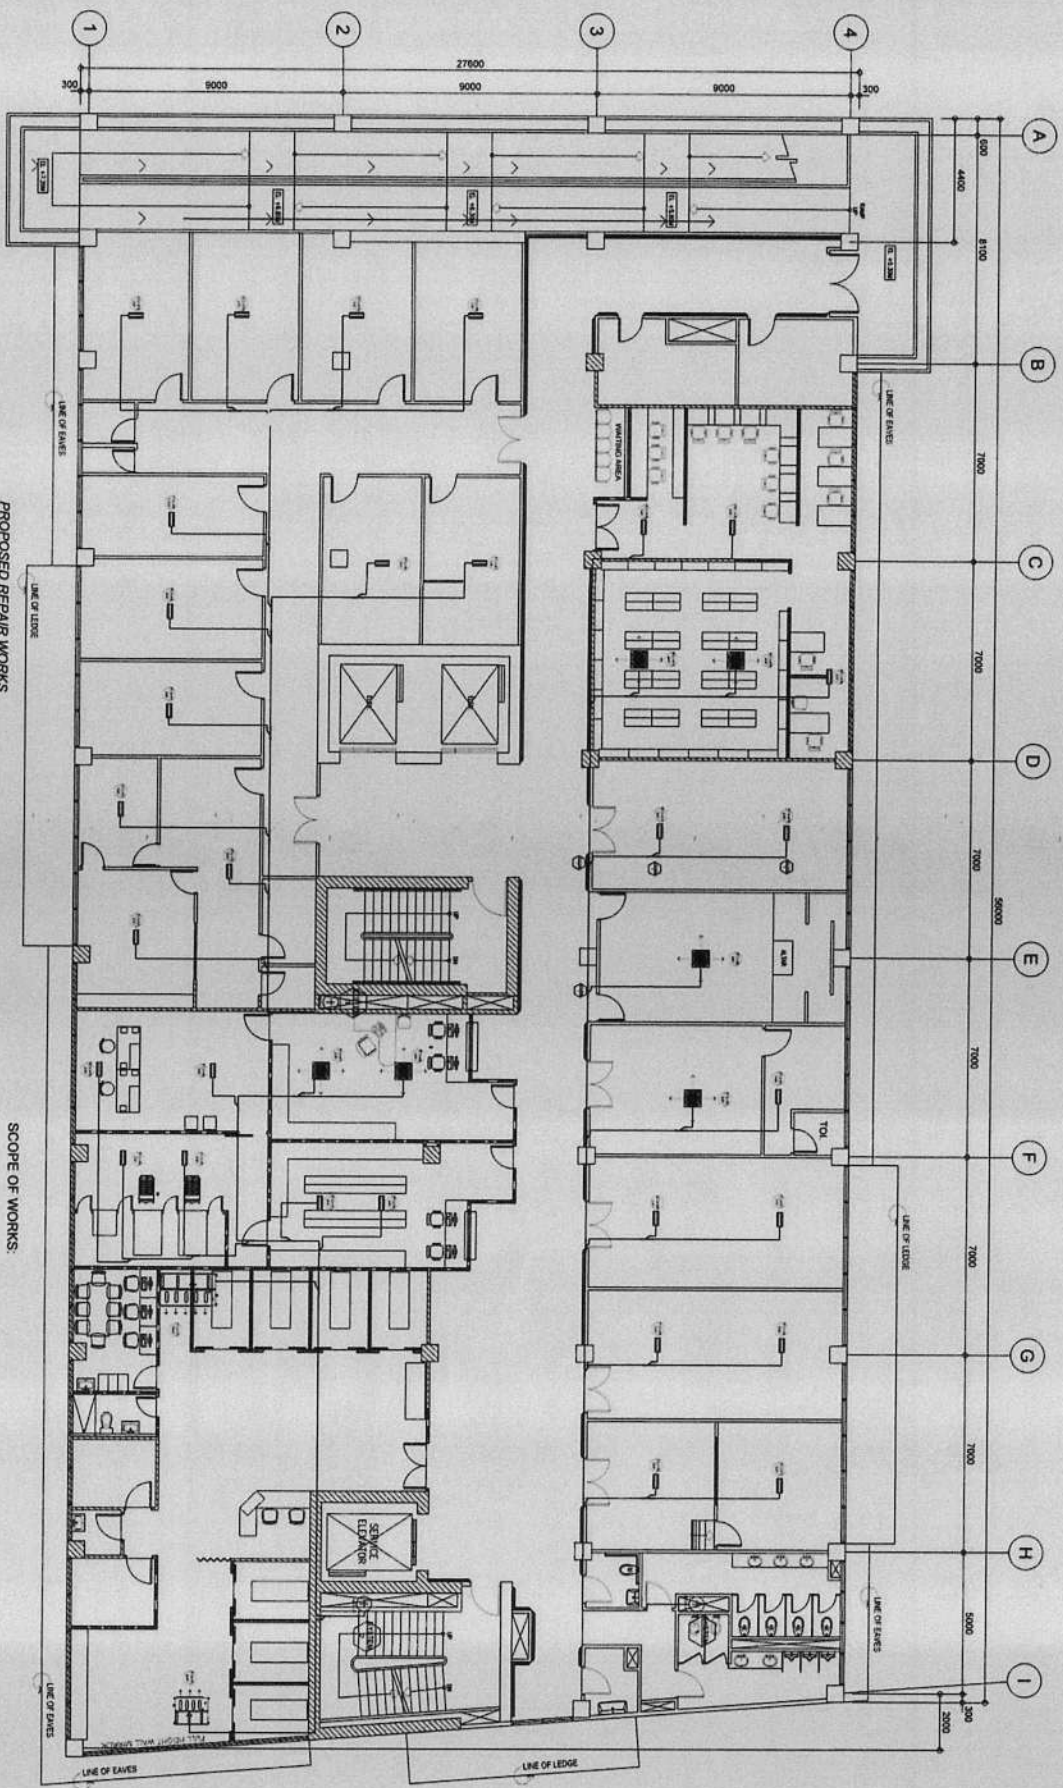

PROPOSED REPAIR WORKS
SIXTH FLOOR POWER LAYOUT

- SCOPE OF WORKS:
1. Installation of Convenience Outlets
 2. Tapped to existing Power Outlet to Existing Panelboards.

1/8" = 1'-0" SCALE
1:150 MAIL



REPUBLIC OF THE PHILIPPINES
CITY OF PASIG
OFFICE OF THE MAYOR
CITY ENGINEERING OFFICE

PROJECT TITLE:
PROPOSED EXPANSION W/
IMPROVEMENT WORKS AT
PASIG CITY CHILDREN'S HOSPITAL
LOCATION: INDUSTRIAL COR. ALBUYER JOSE STS.
INDUSTRIAL PARK CITY

PROJECT IN CHARGE:
ENGR. CHRISTOPHER BENEDICT C. SOLOMON
ENGR. ENRIQUE M. MARIQUA, JR.
ENGR. JOHN M. DELA CRUZ, I. COORDINATOR

PROGRAMMING AND CONSTRUCTION:
ENGR. GERALD BELLA
ENGR. JORGE L. TIZOU
OC. ELECTRICAL INFRASTRUCTURE SECTION

RECOMMENDING APPROVAL:
ENGR. EUGENIO B. BRIDENCIO
ENGR. ARTAVARDES V. GERONIMO
OC. CITY ENGINEERING OFFICE

APPROVED BY:
VICTOR M.A. REGIS N. SOTTO
CITY MAYOR

SHEET CONTENT:
RECONSTRUCTION
LAYOUT

SHEET NO.:
M
4773

CONTRACTOR:
COMPOUNDE & ACCEPTED BY:


1. NO PART OF THIS PLAN IS TO BE USED FOR ANY OTHER PROJECT WITHOUT THE WRITTEN PERMISSION OF THE CITY ENGINEERING OFFICE.

2. IN ANY CASE, THE CONTRACTOR SHALL BE RESPONSIBLE FOR THE PROTECTION OF ALL EXISTING UTILITIES AND STRUCTURES.

3. IN CASE OF DISCREPANCY IN THE DRAWINGS, THE LATTER SHALL BE SUPERIOR TO THE FORMER.

4. THE CONTRACTOR SHALL BE RESPONSIBLE FOR THE PROTECTION OF ALL EXISTING UTILITIES AND STRUCTURES.

5. THE CONTRACTOR SHALL BE RESPONSIBLE FOR THE PROTECTION OF ALL EXISTING UTILITIES AND STRUCTURES.

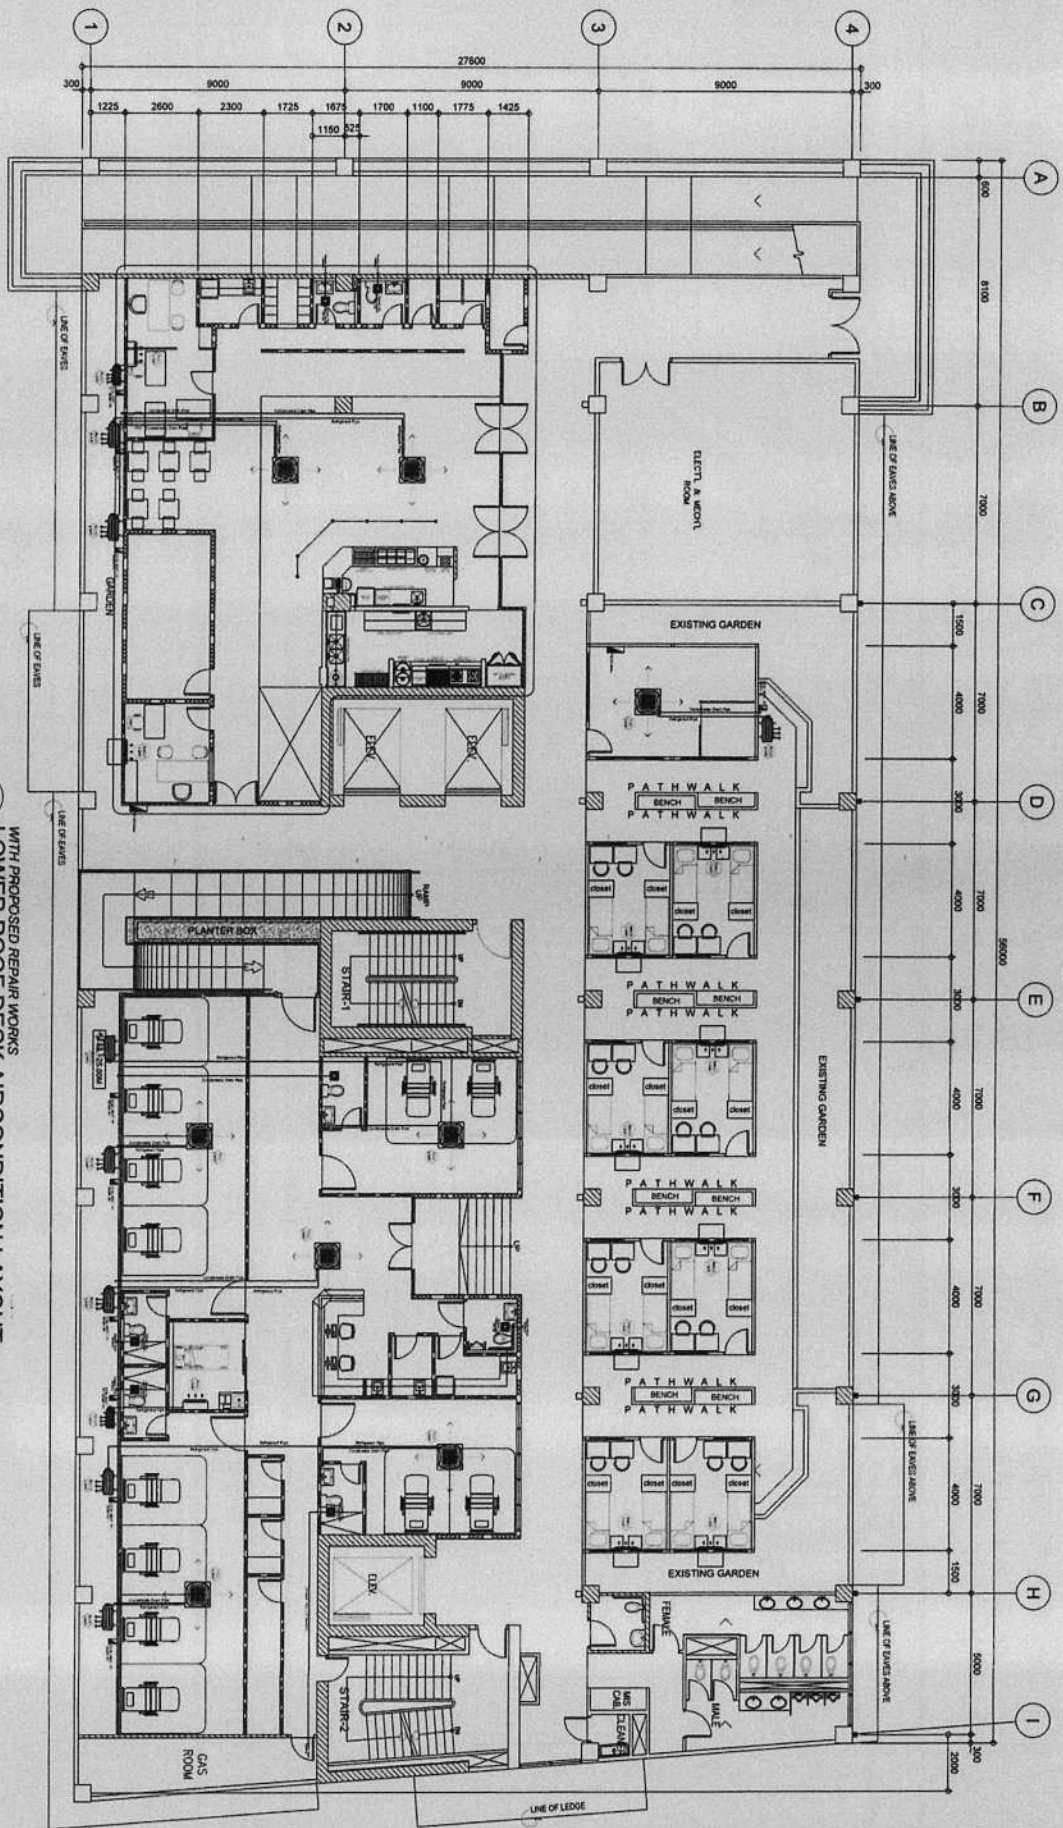

WITH PROPOSED REPAIR WORKS
LOWER ROOF DECK AIRCONDITION LAYOUT



REPUBLIC OF THE PHILIPPINES
CITY OF PASIG
OFFICE OF THE MAYOR
CITY ENGINEERING OFFICE

PROJECT TITLE
PROPOSED EXPANSION W/
IMPROVEMENT WORKS AT
PASIG CITY CHILDREN'S HOSPITAL

PROJECT IN CHARGE
ENGR. CHRISTOPHER B. SOLOMON
ENGR. EDUARDO G. BARBUCA JR.
ENGR. JOSE J. BERNAL
ENGR. JOSE L. TISON
ENGR. JOSE M. PRUDENCIO
ENGR. ARTAVARRES V. GERONIMO

PROGRAMMING AND CONSTRUCTION

RECOMMENDING APPROVAL

APPROVED BY:
VICTOR M. REGIS N. SOTTO
CITY MAYOR

SHEET CONTENT: AIRCONDITION LAYOUT

SHEET NO.: 4873

IMPORTANT NOTES:
1. NO ALTERATION IN AREA & PERCENTAGE SHALL BE MADE.
2. CONTRACTOR SHALL BE RESPONSIBLE FOR THE PROVISION OF ALL MATERIALS.
3. THE CONTRACTOR SHALL BE RESPONSIBLE FOR THE PROVISION OF ALL MATERIALS.
4. THE CONTRACTOR SHALL BE RESPONSIBLE FOR THE PROVISION OF ALL MATERIALS.
5. THE CONTRACTOR SHALL BE RESPONSIBLE FOR THE PROVISION OF ALL MATERIALS.
6. THE CONTRACTOR SHALL BE RESPONSIBLE FOR THE PROVISION OF ALL MATERIALS.

CONTRACTOR



REPUBLIC OF THE PHILIPPINES
CITY OF PASIG
OFFICE OF THE MAYOR
CITY ENGINEERING OFFICE

PROJECT TITLE
PROPOSED EXPANSION WITH IMPROVEMENT WORKS AT PASIG CITY CHILDREN'S HOSPITAL

PROJECT IN CHARGE
ENGR. **CHARLES W. SOLORSON**
ENGR. **EDUARDO BARRICK JR.**

PROGRAMMING AND CONSTRUCTION
ENGR. **JOHN L. TITON**
DR. **HYPERICAL EPISIMBAKING SIDAN**


RECOMMENDING APPROVAL
ENGR. **EDUARDO BARRICK JR.**

APPROVED BY
ENGR. **VICTOR M. REGIS N. SOTTO**
CITY MAYOR


SHEET CONTENT
FIRE DETECTION ALARM SYSTEM RISER DIAGRAM

SHEET NO.
AUX 4973

IMPORTANT NOTES
1. NO ALTERATION IN PANEL & PROPORTIONING SHALL BE MADE WITHOUT THE APPROVAL OF THE ARCHITECT AND ENGINEER.
2. IF ANY CHANGE IN THE CONSTRUCTION METHOD OF THE WORK IS TO BE MADE, THE ARCHITECT AND ENGINEER SHALL BE NOTIFIED.
3. IN CASE OF THE CONSTRUCTION METHOD OF THE WORK IS TO BE MADE, THE ARCHITECT AND ENGINEER SHALL BE NOTIFIED.
4. THE LOCATION OF THE INSTALLATION SHALL BE CONNECTED AT THE TOP OF THE CONSTRUCTION.

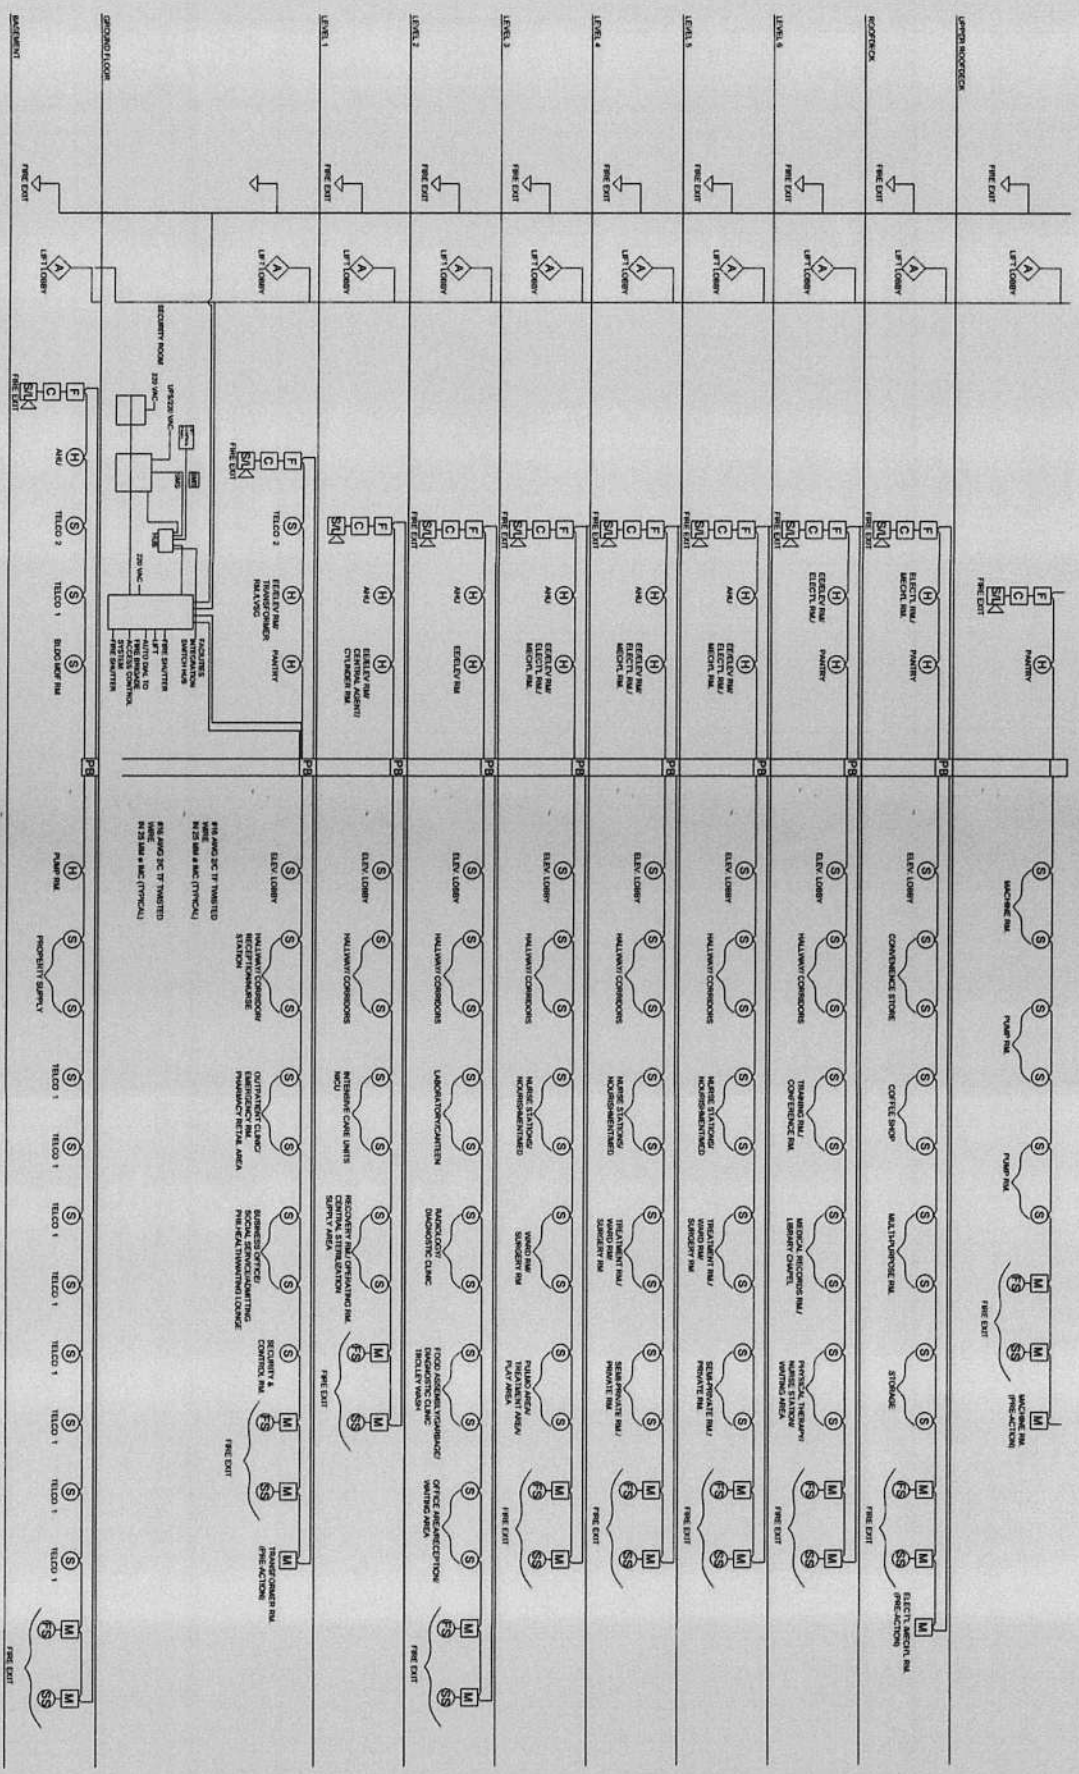


CONFORME & ACCEPTED BY
CONTRACTOR

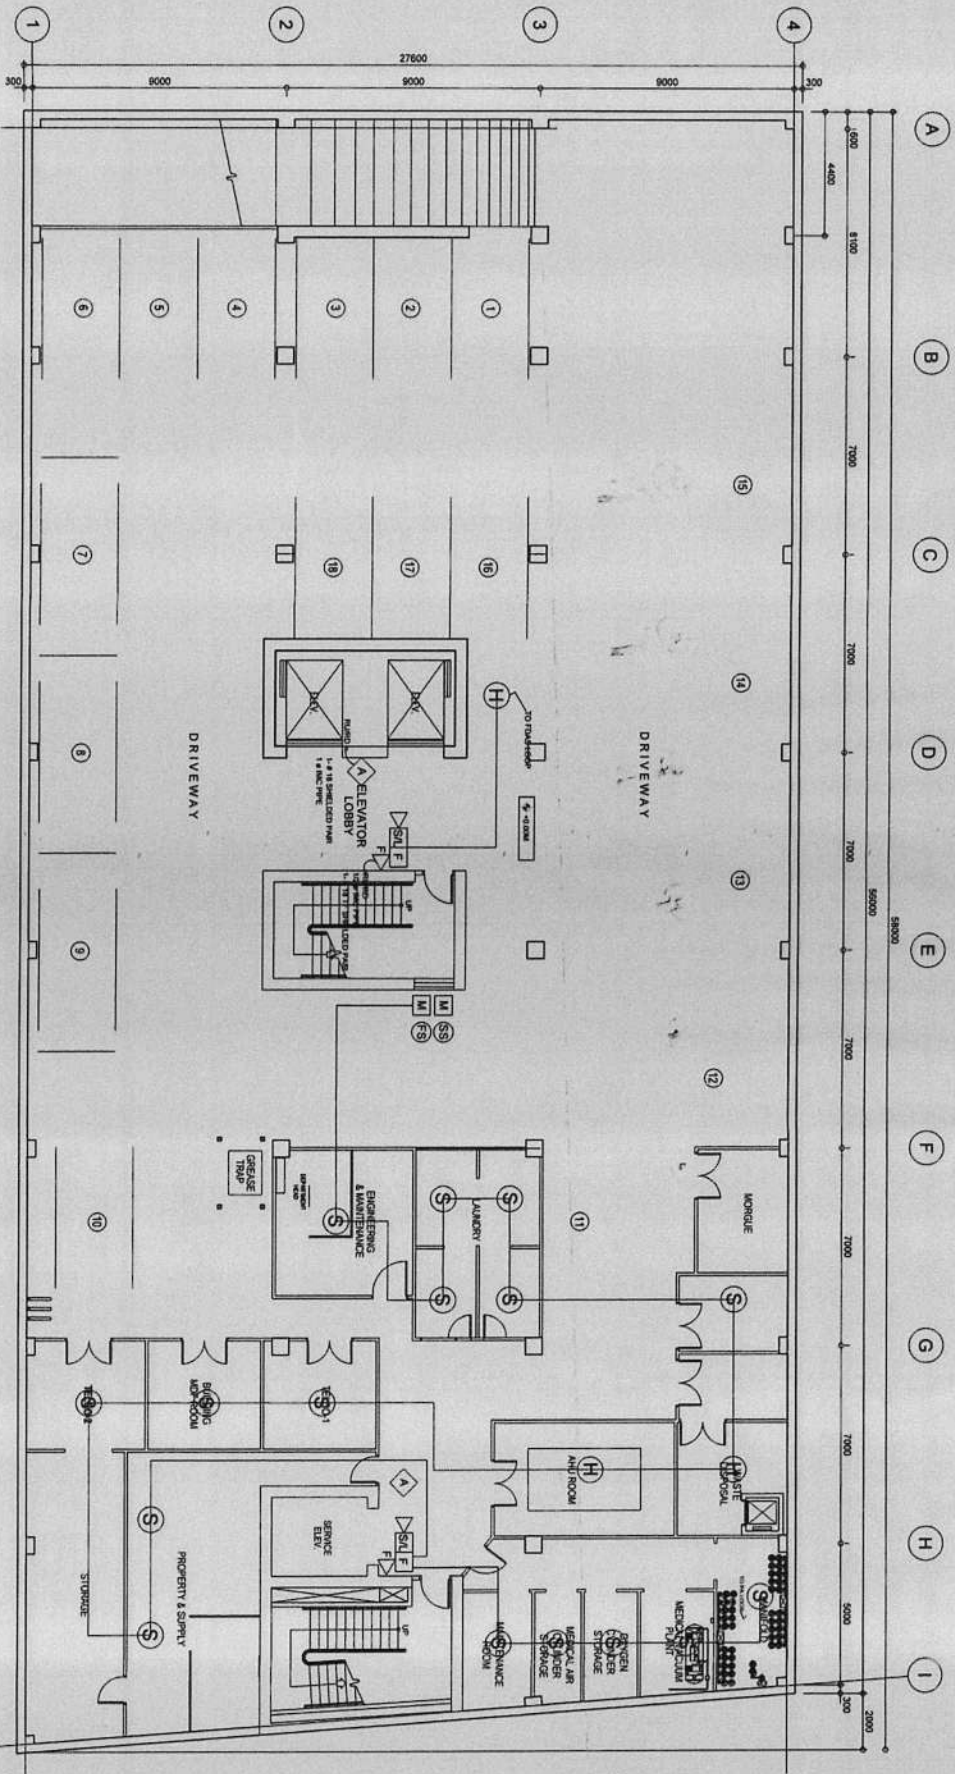

00
A 1/80 SCALE
BASEMENT FIRE DETECTION & ALARM SYSTEM LAYOUT
1:100 IML

	REPUBLIC OF THE PHILIPPINES CITY OF PASIG OFFICE OF THE MAYOR CITY ENGINEERING OFFICE	PROJECT TITLE PROPOSED EXPANSION W/ IMPROVEMENT WORKS AT PASIG CITY CHILDREN'S HOSPITAL	PROJECT IN CHARGE ENGR. CHRISTOPHER C. SOLOMON	PROGRAMMING AND CONSTRUCTION ENGR. JORGE L. TIZON OR. INTEGRAL INFRASTRUCTURE SYSTEM	RECOMMENDING APPROVAL ENGR. JAMES REFRINDENCIO OR. CIVIL ENGINEERING DIVISION	APPROVED BY VICTOR M. REGIS N. SOTTO CITY MAYOR	SHEET CONTENT FIRE DETECTION ALARM SYSTEM LAYOUT	SHEET NO.
	LOCATION INDUSTRIAL COR. ALONSO JOSE STL. PASIG CITY	ENGR. EDUARDO S. BARRERA, JR. ENGR. JOHN M. ALAVALA, V. CORTEZ ENGR. JOSE L. TIZON	1. NO. 1. VERIFY ALL DIMENSIONS AND SPECIFICATIONS WITH THE ORIGINAL CONTRACT DOCUMENTS AND THE AS-BUILT DRAWINGS. 2. NO. 2. VERIFY ALL DIMENSIONS AND SPECIFICATIONS WITH THE ORIGINAL CONTRACT DOCUMENTS AND THE AS-BUILT DRAWINGS. 3. NO. 3. VERIFY ALL DIMENSIONS AND SPECIFICATIONS WITH THE ORIGINAL CONTRACT DOCUMENTS AND THE AS-BUILT DRAWINGS. 4. NO. 4. VERIFY ALL DIMENSIONS AND SPECIFICATIONS WITH THE ORIGINAL CONTRACT DOCUMENTS AND THE AS-BUILT DRAWINGS.	ENGR. JOSE L. TIZON OR. INTEGRAL INFRASTRUCTURE SYSTEM	ENGR. JAMES REFRINDENCIO OR. CIVIL ENGINEERING DIVISION	1. NO. 1. VERIFY ALL DIMENSIONS AND SPECIFICATIONS WITH THE ORIGINAL CONTRACT DOCUMENTS AND THE AS-BUILT DRAWINGS. 2. NO. 2. VERIFY ALL DIMENSIONS AND SPECIFICATIONS WITH THE ORIGINAL CONTRACT DOCUMENTS AND THE AS-BUILT DRAWINGS. 3. NO. 3. VERIFY ALL DIMENSIONS AND SPECIFICATIONS WITH THE ORIGINAL CONTRACT DOCUMENTS AND THE AS-BUILT DRAWINGS. 4. NO. 4. VERIFY ALL DIMENSIONS AND SPECIFICATIONS WITH THE ORIGINAL CONTRACT DOCUMENTS AND THE AS-BUILT DRAWINGS.	SHEET NO. 5073	

CONTRACTOR AND ACCEPTED BY: _____
 CONTRACTOR

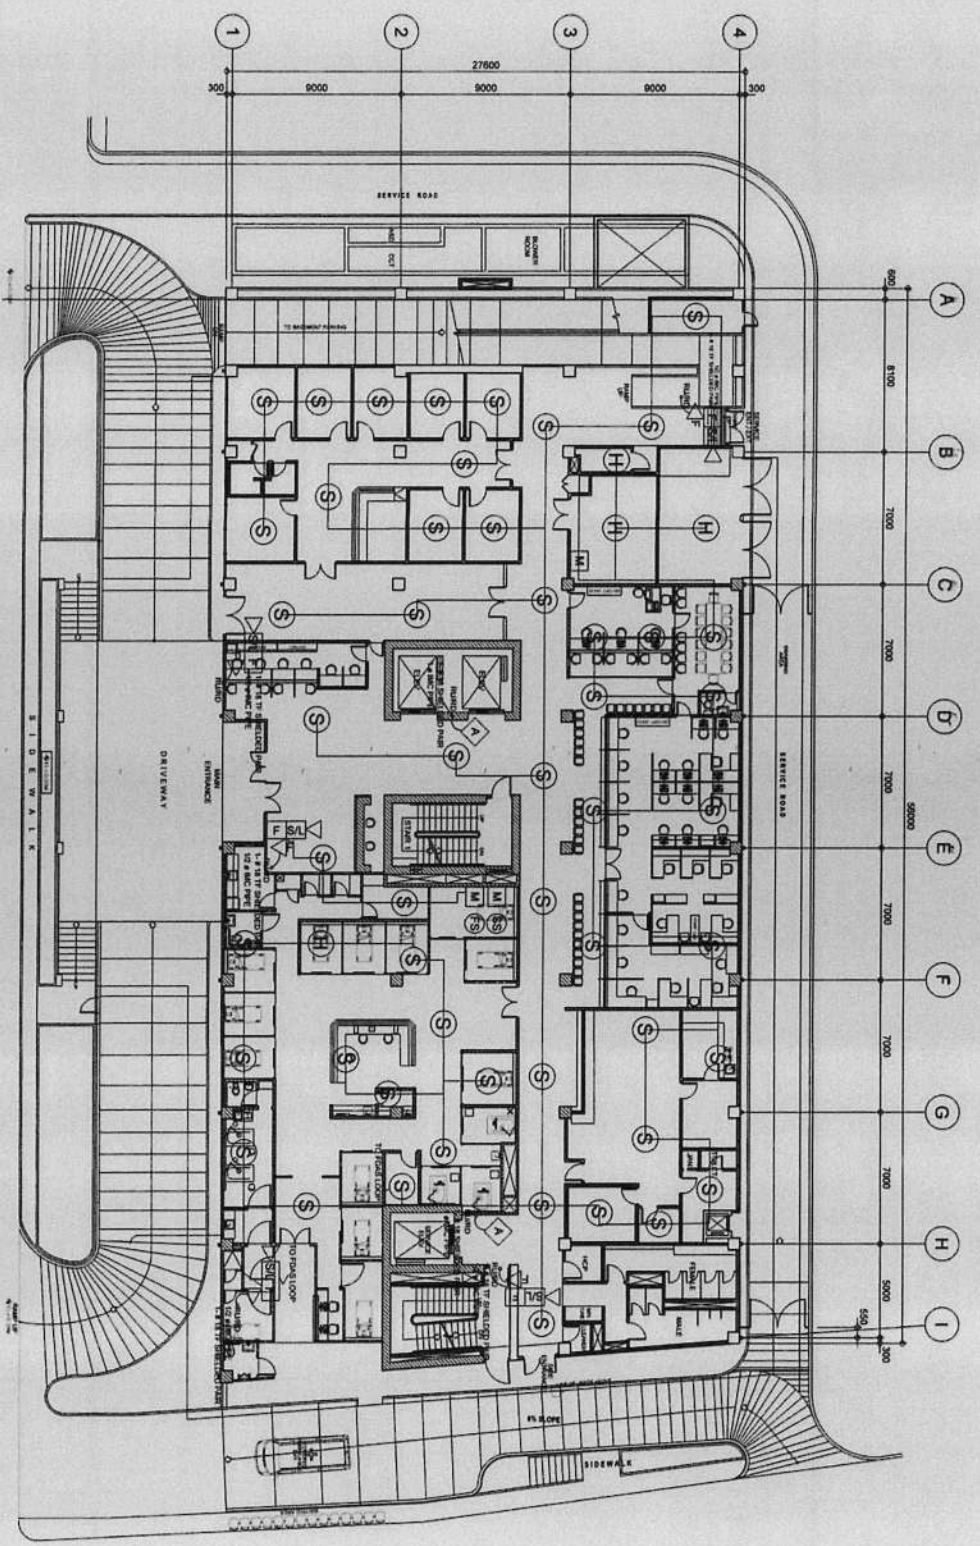


GROUND FIRE DETECTION & ALARM SYSTEM LAYOUT
 1:100 MM
 SCALE

	REPUBLIC OF THE PHILIPPINES CITY OF PASIG OFFICE OF THE MAYOR CITY ENGINEERING OFFICE	PROJECT TITLE: PROPOSED EXPANSION W/ IMPROVEMENT WORKS AT PASIG CITY CHILDREN'S HOSPITAL	PROJECT IN CHARGE: ENGR. CHRISTOPHER BENEDICT C. SOLOMON ENGR. EDUARDO M. BARRICA JR. ENGR. JOSE J. BELLA ENGR. JOSE L. TIZON	PROGRAMMING AND CONSTRUCTION: ENGR. JOSE L. TIZON ENR. ELECTRICAL MECHANICAL SYSTEMS	RECOMMENDING APPROVAL: ENGR. FRANCISCO BRUNO ENGR. ARTAVERDES V. GERONIMO	APPROVED BY: VICTOR MA. REGIS N. SOTTO CITY MAYOR	SHEET CONTENT: FIRE DETECTION ALARM SYSTEM (FDAS)	SHEET NO.:
--	--	--	---	--	---	---	--	----------------

IMPORTANT NOTES:

- NO ALTERATION IN PANEL SCHEDULE SHALL BE MADE WITHOUT THE APPROVAL OF THE ARCHITECT AND ENGINEER.
- IF ANY CASE OF THE CONSTRUCTION METHOD USED BY THE CONTRACTOR IS NOT SPECIFIED IN THE CONTRACT DOCUMENTS, THE CONTRACTOR SHALL BE RESPONSIBLE FOR THE SELECTION OF THE METHOD.
- IN CASE OF CONFLICT IN THE DRAWING, THE LATTER SHALL BE SUBMITTED TO THE ARCHITECT FOR HIS REVIEW AND APPROVAL.
- TO THE EXTENT REFERRED ANY ADDITIONAL SHALL BE MADE BY THE CONTRACTOR.
- THE CONTRACTOR SHALL BE RESPONSIBLE FOR THE SELECTION OF THE MATERIALS TO BE USED IN THE CONSTRUCTION OF THE SYSTEM.
- THE CONTRACTOR SHALL BE RESPONSIBLE FOR THE SELECTION OF THE MATERIALS TO BE USED IN THE CONSTRUCTION OF THE SYSTEM.

CONTRACTOR

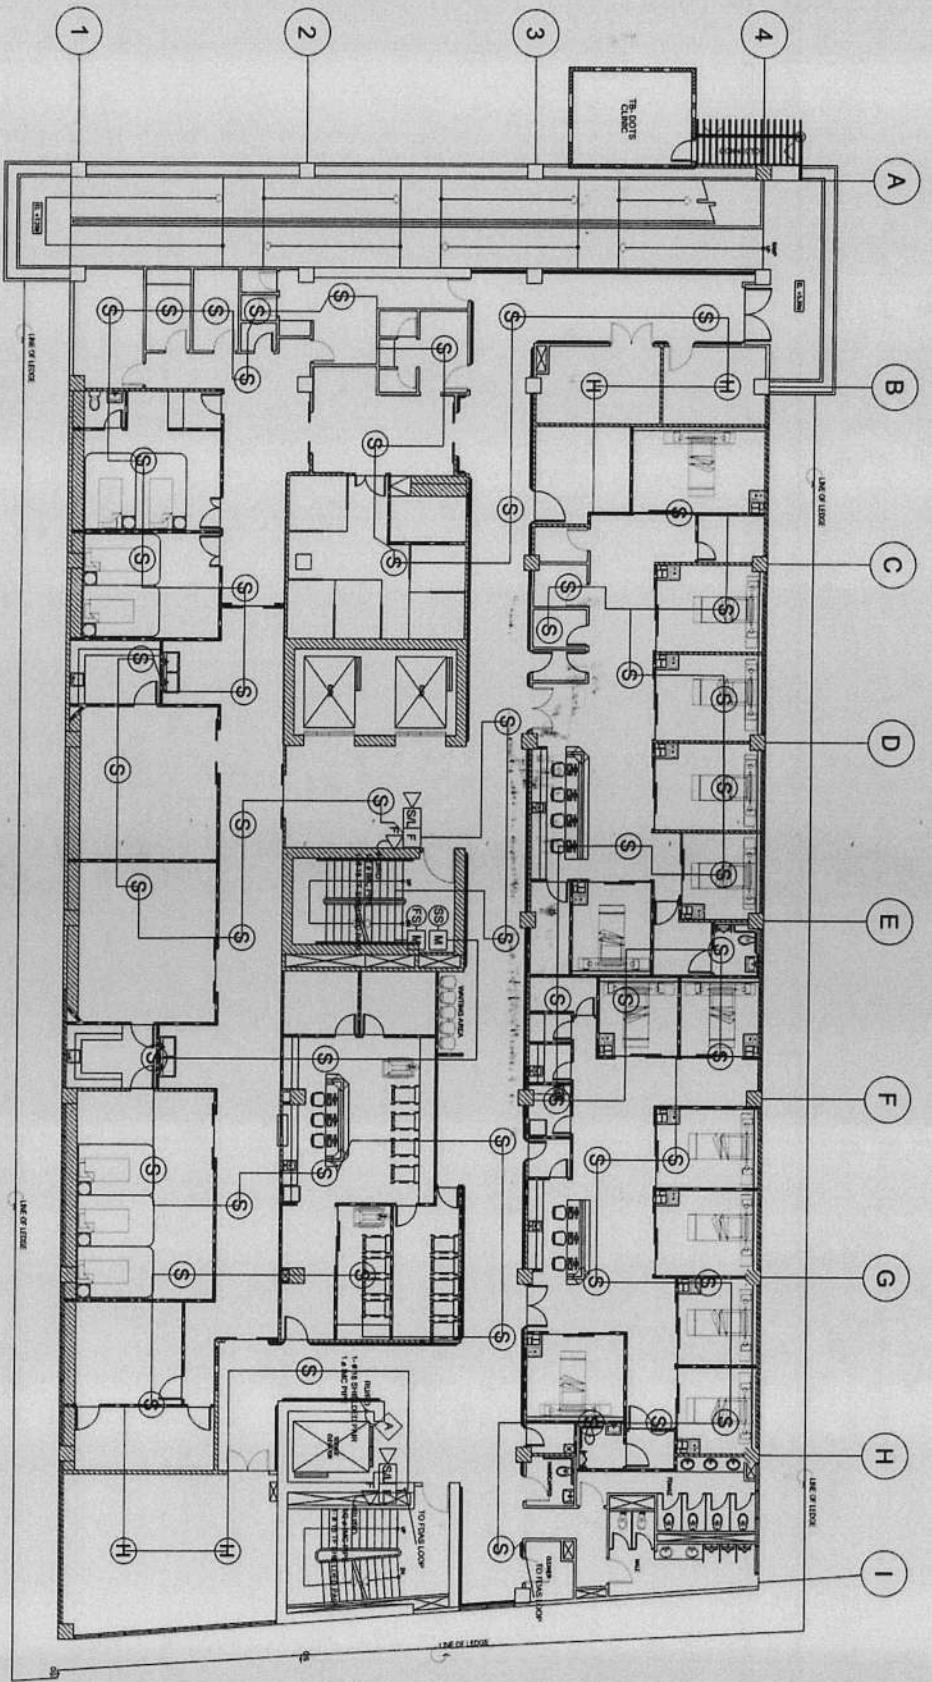


SECOND FLOOR FIRE DETECTION & ALARM SYSTEM LAYOUT
 SCALE 1:100 MAX.

	REPUBLIC OF THE PHILIPPINES OFFICE OF THE MAYOR CITY ENGINEERING OFFICE	PROJECT TITLE: PROPOSED EXPANSION W/ IMPROVEMENTS FOR PASIG CITY CHILDREN'S HOSPITAL	PROJECT IN CHARGE: ENGR. CHRISTOPHER S. SOLAMON ENGR. EDUARDO G. BARRERA, JR. ENGR. JOY M. CORTES	PROGRAMMING AND CONSTRUCTION: ENGR. PAUL BELIN ENGR. TIZON	RECOMMENDING APPROVAL: ENGR. ARTABERES V. GERONIMO	APPROVED BY: VICTOR MA. REGIS N. SOTTO CITY MAYOR	SHEET CONTENT: FIRE DETECTION ALARM SYSTEM (FDAS)	SHEET NO.:
--	---	---	--	--	---	---	--	----------------

1. THE CONTRACTOR SHALL BE RESPONSIBLE FOR THE PROTECTION OF THE EXISTING STRUCTURE AND UTILITIES.
 2. THE CONTRACTOR SHALL BE RESPONSIBLE FOR THE PROTECTION OF THE EXISTING UTILITIES.
 3. THE CONTRACTOR SHALL BE RESPONSIBLE FOR THE PROTECTION OF THE EXISTING UTILITIES.
 4. THE CONTRACTOR SHALL BE RESPONSIBLE FOR THE PROTECTION OF THE EXISTING UTILITIES.
 5. THE CONTRACTOR SHALL BE RESPONSIBLE FOR THE PROTECTION OF THE EXISTING UTILITIES.


CONTRACTOR

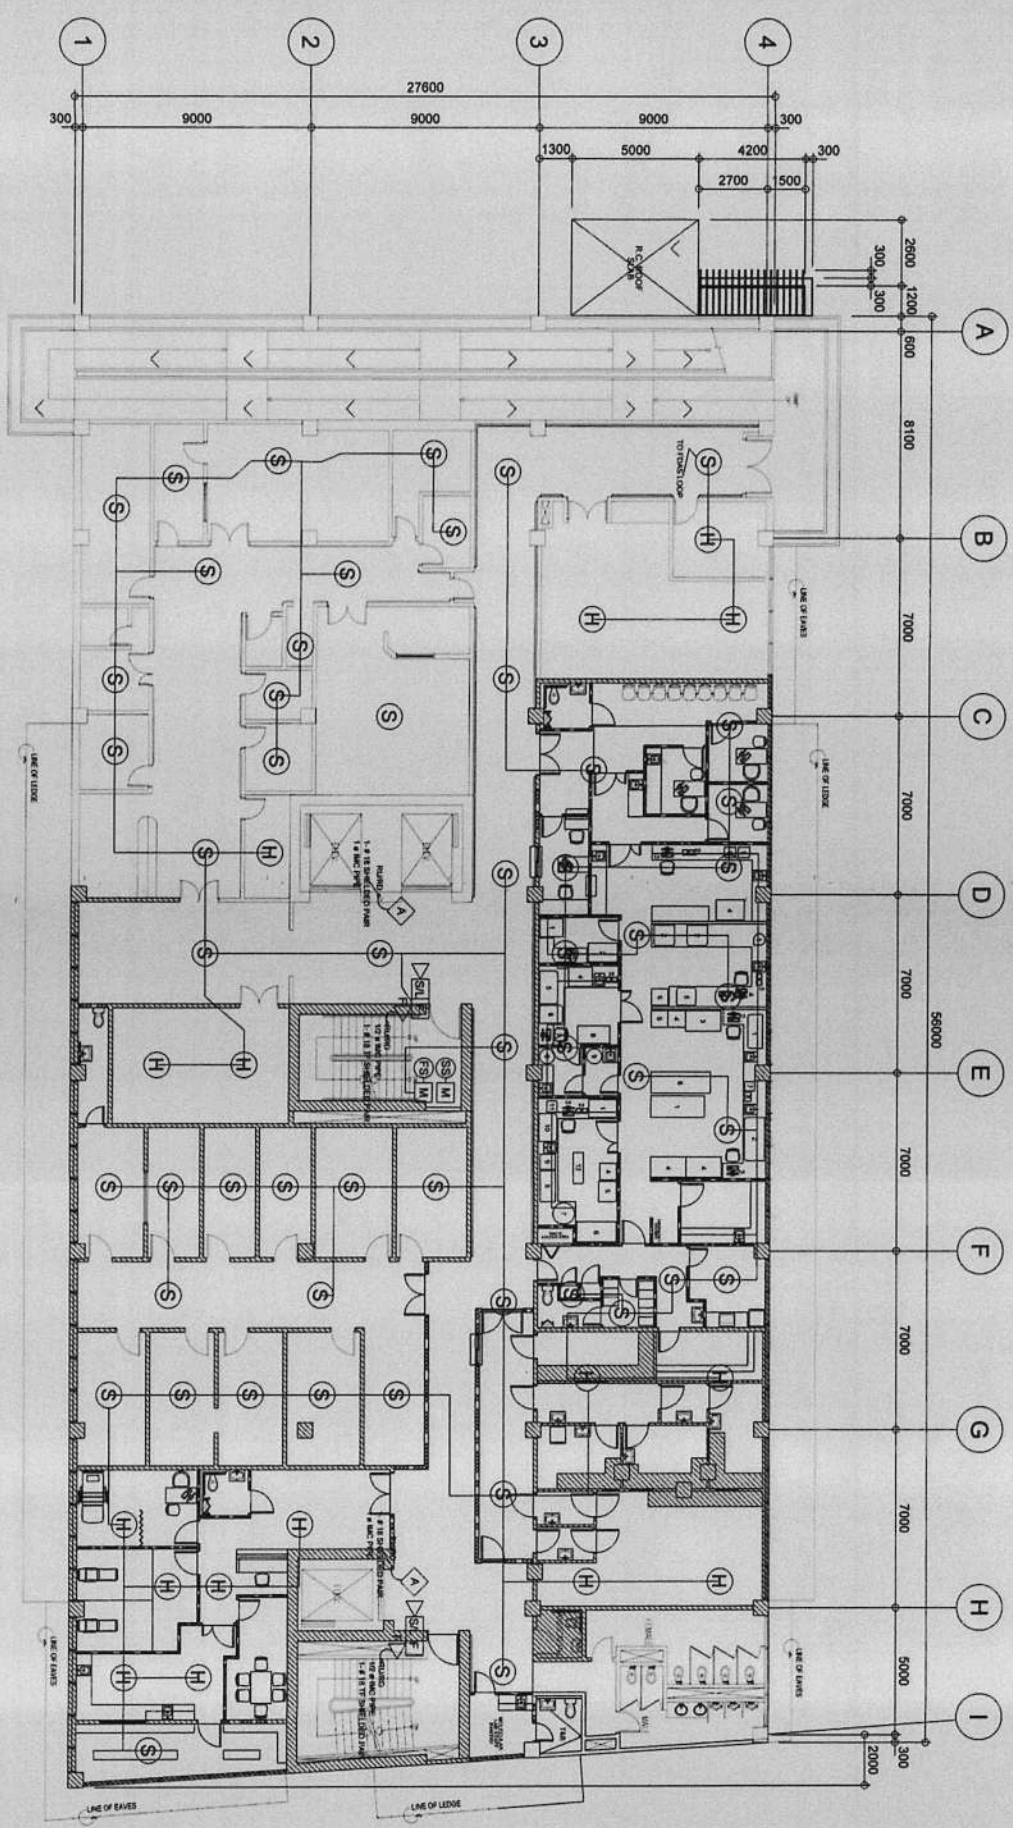

THIRD FLOOR FIRE DETECTION & ALARM SYSTEM LAYOUT
 SCALE 1:100

	PROJECT TITLE: PROPOSED EXPANSION W/ IMPROVEMENT WORKS AT PASIG CITY CHILDREN'S HOSPITAL	PROJECT IN CHARGE: ENGR. <i>[Signature]</i> EDUARDO C. SOLANOON	PROGRAMMING AND CONSTRUCTION: ENGR. <i>[Signature]</i> GENAL BELLA ENGR. <i>[Signature]</i> JONIE L. TIRON ENGR. <i>[Signature]</i> JOYAN T. CONTES	RECOMMENDING APPROVAL: ENGR. <i>[Signature]</i> FRUENDENCO ENGR. <i>[Signature]</i> ARTAVERNY GERONIMO	APPROVED BY: VICTOR <i>[Signature]</i> REGIS N. SOTTO CITY MAYOR	SHEET CONTENT: FIRE DETECTION ALARM SYSTEM LAYOUT (FDS)	SHEET NO.:
	LOCATION: INDUSTRIAL COR. ALCAZAR JOSE STS. PASIG CITY	ENGR. <i>[Signature]</i> EDUARDO C. SOLANOON ENGR. <i>[Signature]</i> JOYAN T. CONTES	ENGR. <i>[Signature]</i> FRUENDENCO ENGR. <i>[Signature]</i> ARTAVERNY GERONIMO	CONTRACTOR:			

IMPORTANT NOTES:
 1. THE CONTRACTOR SHALL BE RESPONSIBLE FOR THE PROVISION OF ALL NECESSARY PERMITS AND APPROVALS FROM THE LOCAL GOVERNMENT AND THE NATIONAL FIRE DEPARTMENT.
 2. THE CONTRACTOR SHALL BE RESPONSIBLE FOR THE PROVISION OF ALL NECESSARY MATERIALS AND LABOR FOR THE COMPLETION OF THE PROJECT.
 3. THE CONTRACTOR SHALL BE RESPONSIBLE FOR THE PROVISION OF ALL NECESSARY SAFETY MEASURES DURING THE CONSTRUCTION OF THE PROJECT.
 4. THE CONTRACTOR SHALL BE RESPONSIBLE FOR THE PROVISION OF ALL NECESSARY PROTECTION OF EXISTING STRUCTURES AND UTILITIES.
 5. THE CONTRACTOR SHALL BE RESPONSIBLE FOR THE PROVISION OF ALL NECESSARY PROTECTION OF THE ENVIRONMENT AND NEIGHBORHOOD.

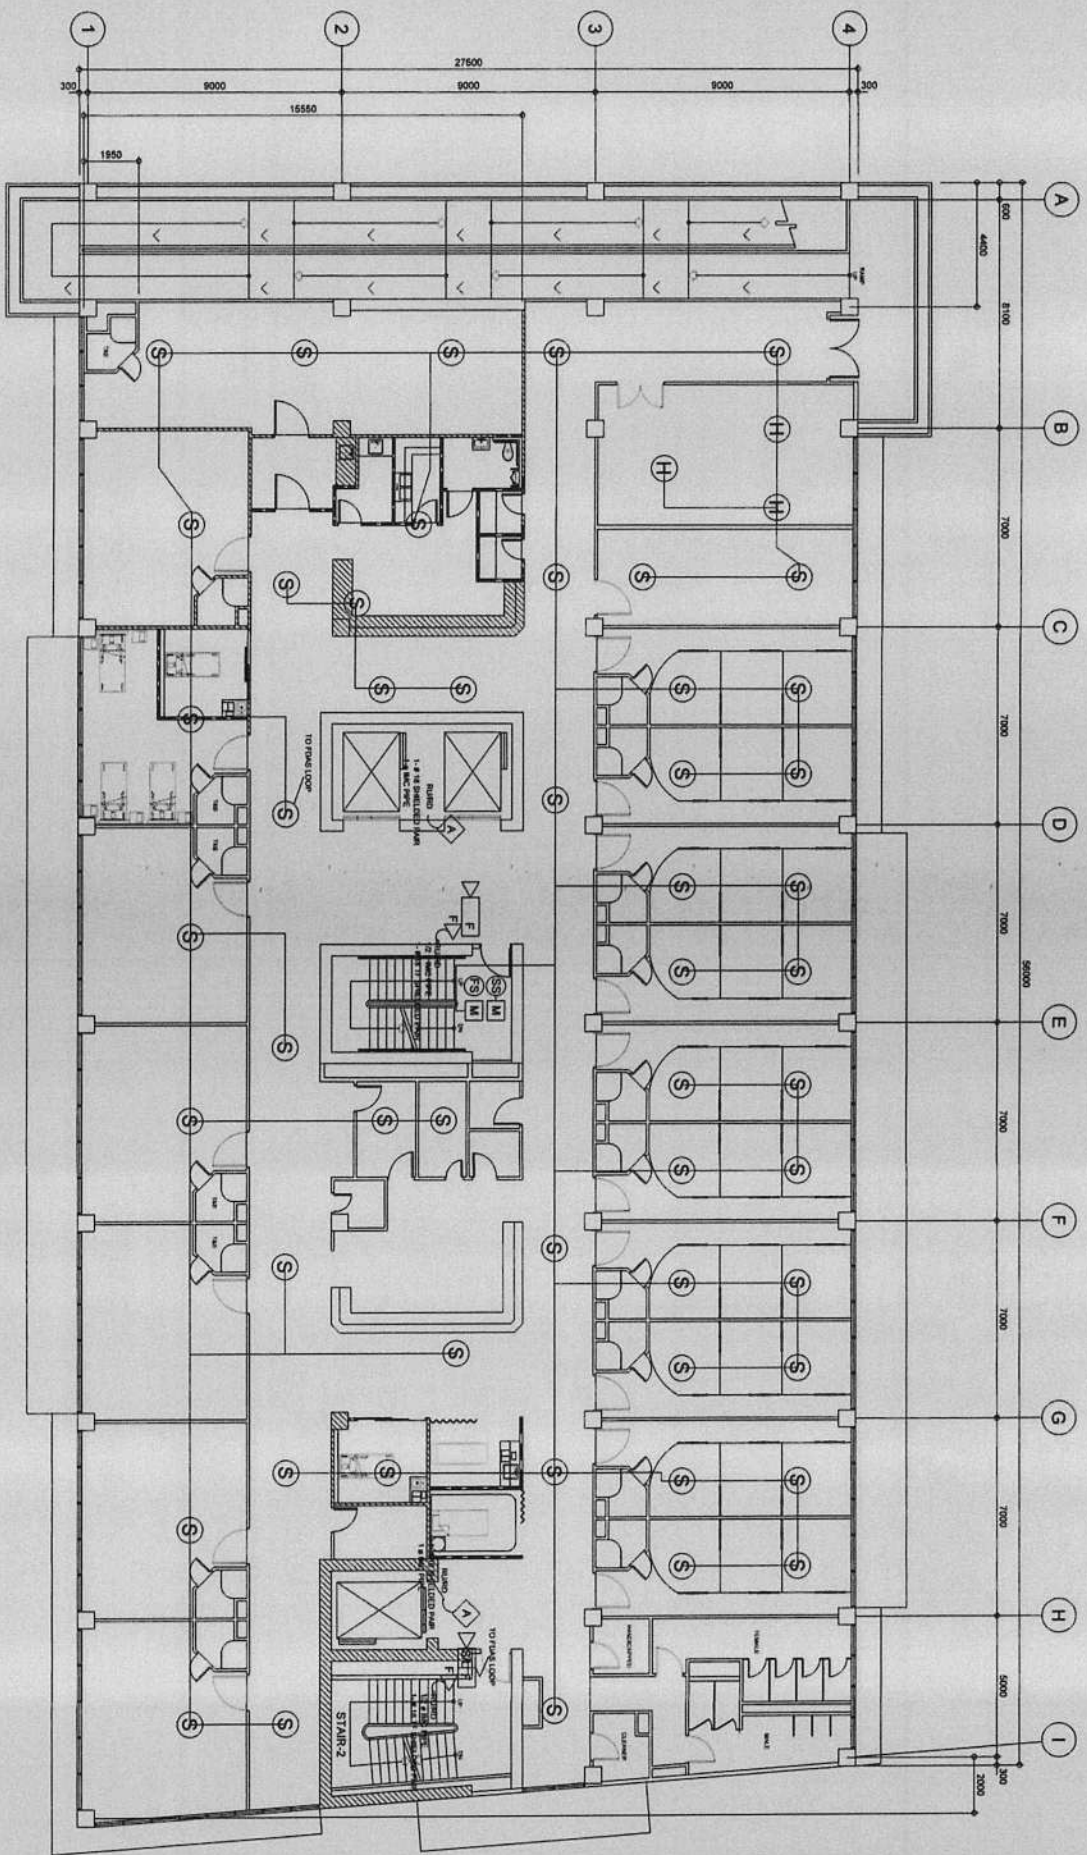

FOURTH FLOOR FIRE DETECTION & ALARM SYSTEM LAYOUT
 SCALE 1:100



REPUBLIC OF THE PHILIPPINES
 CITY OF PASIG
 OFFICE OF THE MAYOR
 CITY ENGINEERING OFFICE

PROJECT TITLE:
**PROPOSED EXPANSION W/
 IMPROVEMENT WORKS AT
 PASIG CITY CHILDREN'S HOSPITAL**

PROJECT IN CHARGE:
 ENGR. CHESTER B. BENEDECIO C. SOLOMON
 ENGR. EDUARDO G. BARRERA, JR.
 ENGR. JOYCE MARIE T. CORTES

PROGRAMMING AND CONSTRUCTION:
 ENGR. DONDEL TIZON
 DR. RICHARD M. MANSUETO

RECOMMENDING APPROVAL:
 ENGR. LUIS R. BRUNDEO
 ENGR. ARTAXERES V. GERONIMO


APPROVED BY:
 VICTOR M. REGIS N. SOTTO
 CITY MAYOR

SHEET CONTENT:
 FIRE DETECTION
 ALARM SYSTEM
 LAYOUT
 (FDAS)

SHEET NO.:
**AUX
 5473**

CONFORME & ACCEPTED BY:
 CONTRACTOR

1. THE CONTRACTOR SHALL BE RESPONSIBLE FOR THE PROVISION OF ALL NECESSARY PERMITS AND APPROVALS FROM THE APPROPRIATE AGENCIES.
 2. THE CONTRACTOR SHALL BE RESPONSIBLE FOR THE PROVISION OF ALL NECESSARY PERMITS AND APPROVALS FROM THE APPROPRIATE AGENCIES.
 3. THE CONTRACTOR SHALL BE RESPONSIBLE FOR THE PROVISION OF ALL NECESSARY PERMITS AND APPROVALS FROM THE APPROPRIATE AGENCIES.
 4. THE CONTRACTOR SHALL BE RESPONSIBLE FOR THE PROVISION OF ALL NECESSARY PERMITS AND APPROVALS FROM THE APPROPRIATE AGENCIES.
 5. THE CONTRACTOR SHALL BE RESPONSIBLE FOR THE PROVISION OF ALL NECESSARY PERMITS AND APPROVALS FROM THE APPROPRIATE AGENCIES.

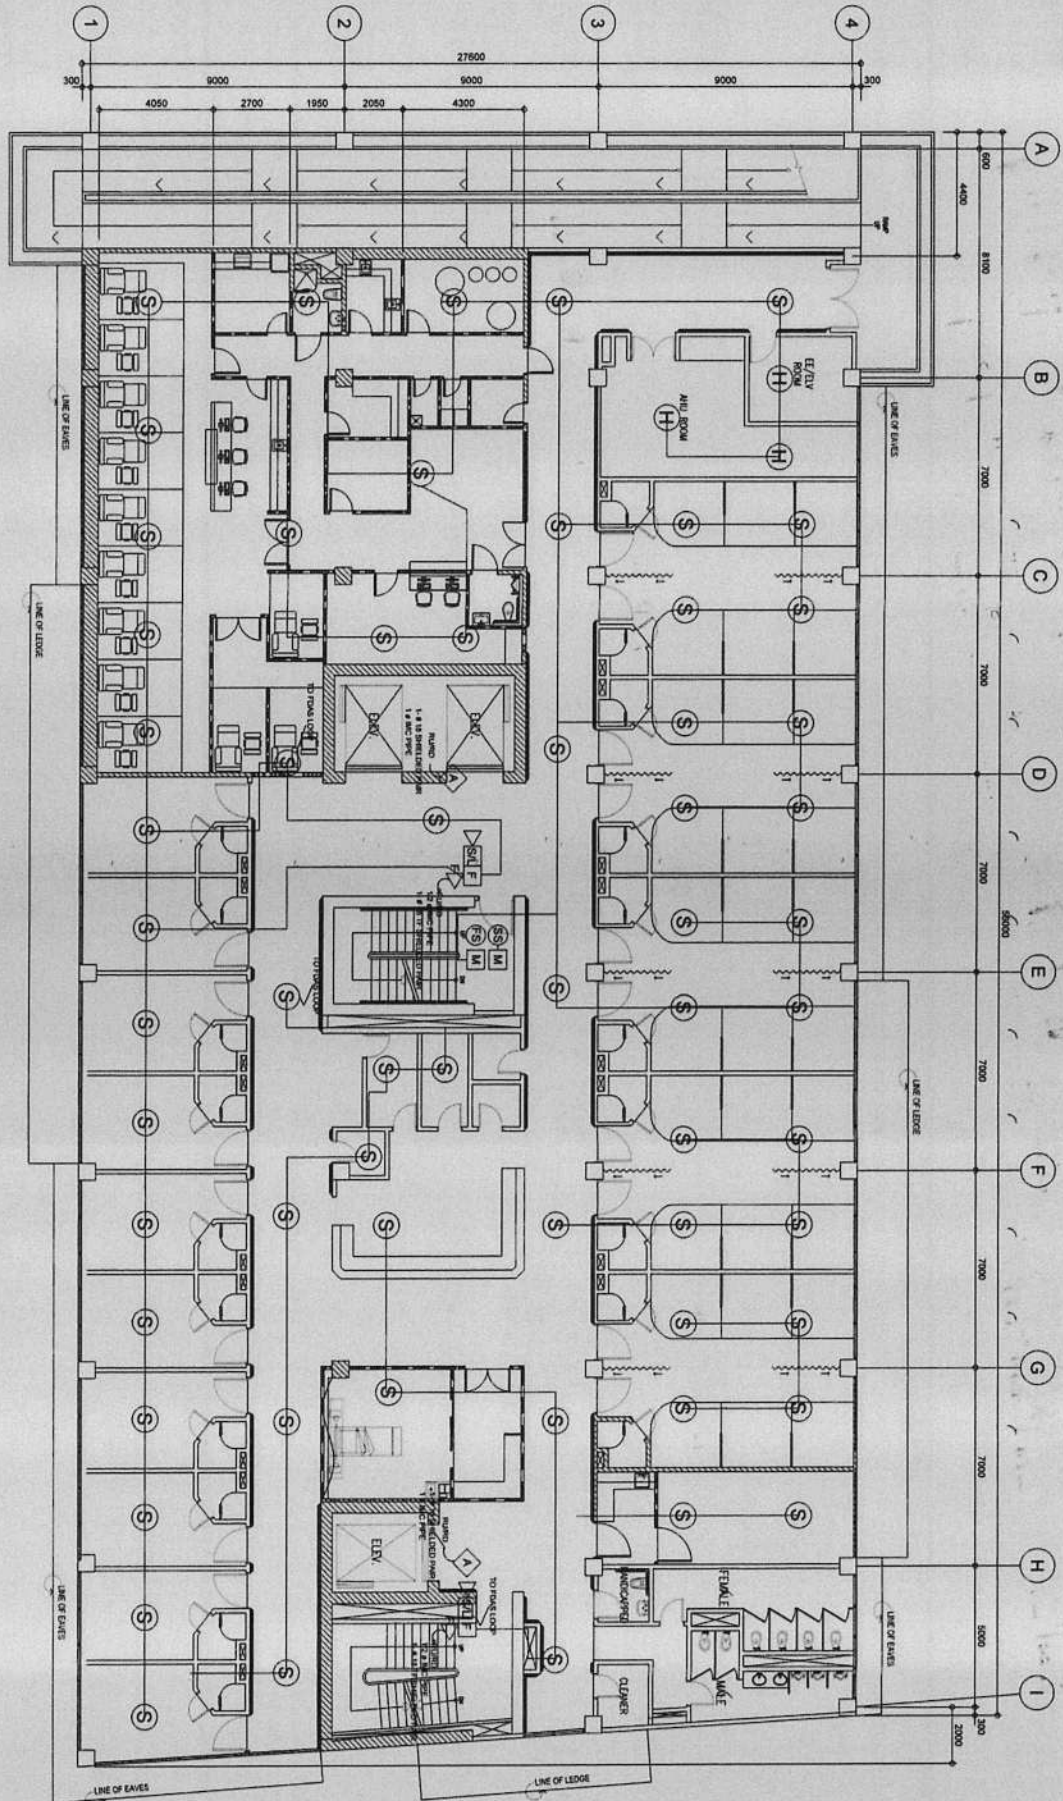

00
A/B
FIFTH FLOOR FIRE DETECTION & ALARM SYSTEM LAYOUT



REPUBLIC OF THE PHILIPPINES
CITY OF PASIG
OFFICE OF THE MAJOR
CITY ENGINEERING OFFICE

PROJECT TITLE:
PROPOSED EXPANSION W/
IMPROVEMENT WORKS AT
PASIG CITY CHILDREN'S HOSPITAL
LOCATION: INDUSTRIAL COR AVENUE, JOSE STS.

PROJECT IN CHARGE:
ENGR. CHRISTOPHER BENEDICT C. SOLAMON
ENGR. EDUARDO G. BARRERA JR.
ENGR. JOSEPH T. COMTES

PROGRAMMING AND CONSTRUCTION:
ENGR. CARLA L. BELLA
ENGR. JORGE L. TIZON
DR. ESTRELLA M. CRIVELLO

RECOMMENDING APPROVAL:
ENGR. EMERSON BRUNDEO
ENGR. ARTAXERXES V. GERONIMO

APPROVED BY:
VICTOR M. REGIS N. SOTTO
CITY MAJOR

SHEET CONTENT:
FIRE DETECTION
ALARM SYSTEM
(PDS)

SHEET NO.
AUX
5573

CONTRACTOR


1. CONTRACTOR SHALL BE RESPONSIBLE FOR THE PROVISION OF ALL MATERIALS AND LABOR REQUIRED FOR THE COMPLETION OF THE PROJECT.

2. CONTRACTOR SHALL BE RESPONSIBLE FOR THE PROVISION OF ALL MATERIALS AND LABOR REQUIRED FOR THE COMPLETION OF THE PROJECT.

3. CONTRACTOR SHALL BE RESPONSIBLE FOR THE PROVISION OF ALL MATERIALS AND LABOR REQUIRED FOR THE COMPLETION OF THE PROJECT.

4. CONTRACTOR SHALL BE RESPONSIBLE FOR THE PROVISION OF ALL MATERIALS AND LABOR REQUIRED FOR THE COMPLETION OF THE PROJECT.

5. CONTRACTOR SHALL BE RESPONSIBLE FOR THE PROVISION OF ALL MATERIALS AND LABOR REQUIRED FOR THE COMPLETION OF THE PROJECT.

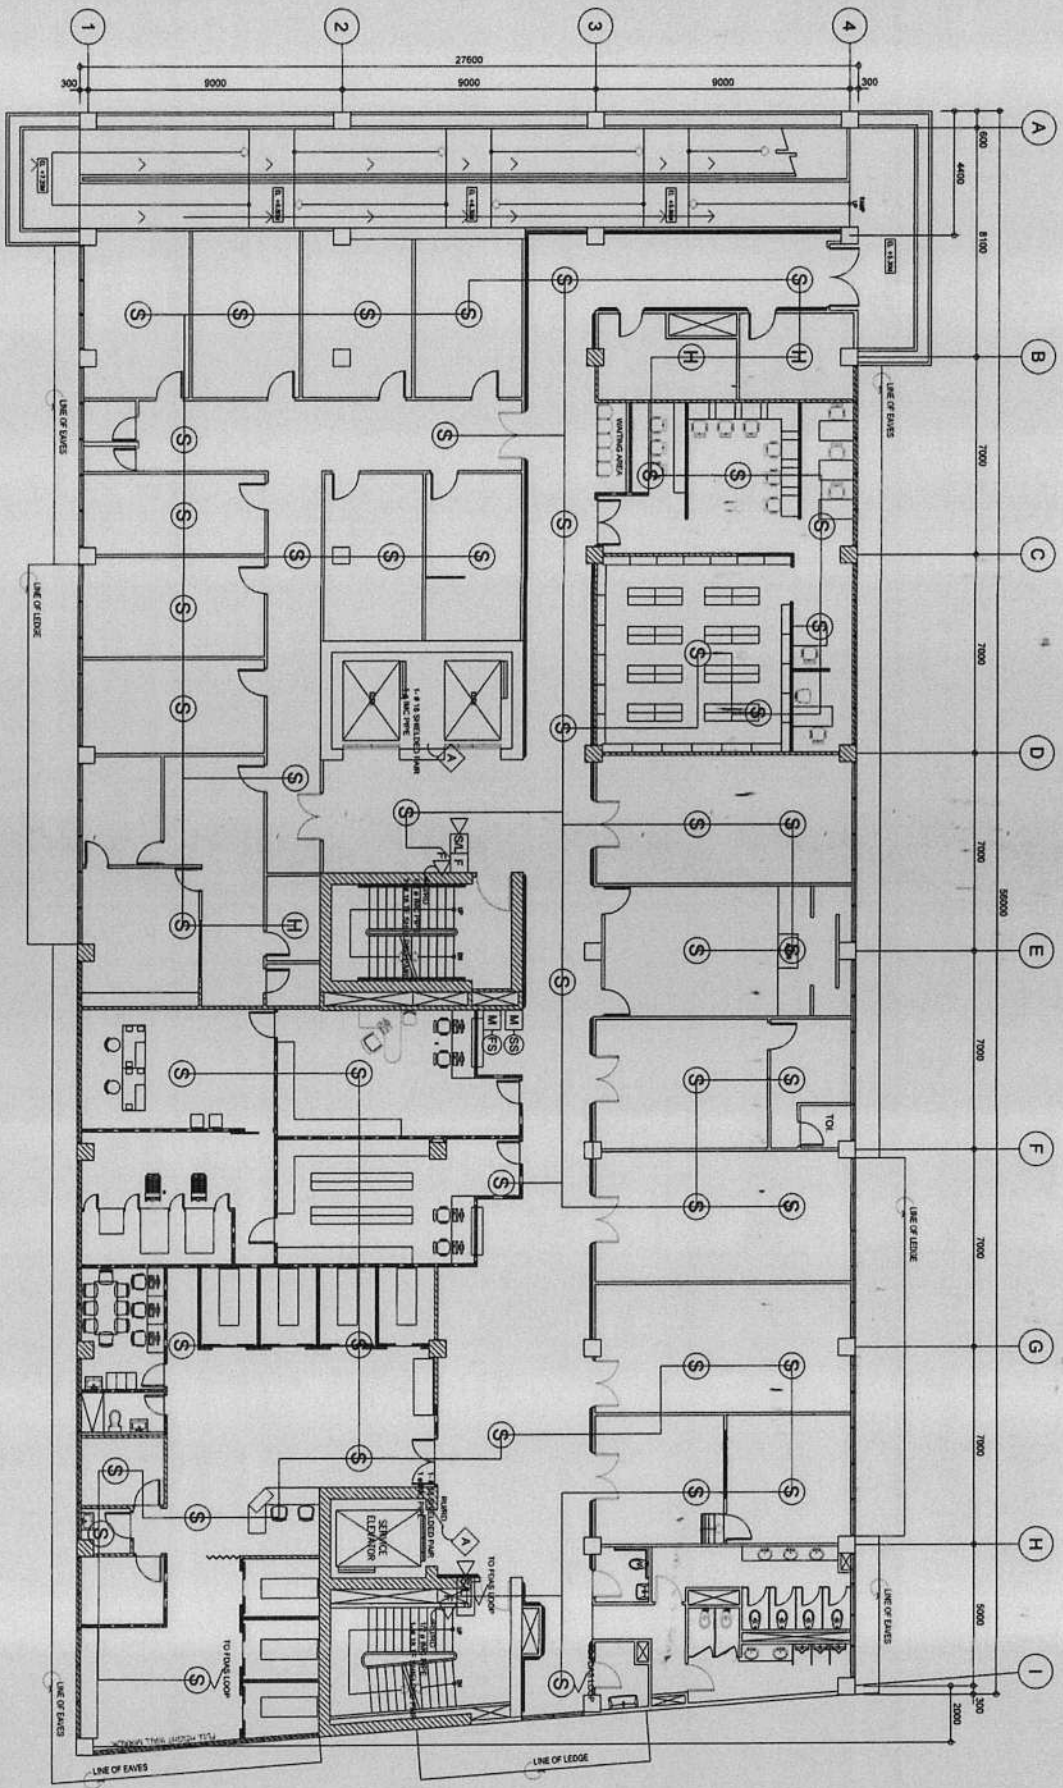

SIXTH FLOOR FIRE DETECTION & ALARM SYSTEM LAYOUT
 SCALE 1:100
 1:100 MM



REPUBLIC OF THE PHILIPPINES
 CITY OF PASIG
 OFFICE OF THE MAYOR
 CITY ENGINEERING OFFICE

PROJECT TITLE:
**PROPOSED EXPANSION W/
 IMPROVEMENT WORKS AT
 PASIG CITY CHILDREN'S HOSPITAL**

PROJECT IN CHARGE:
 ENGR. CHRISTIAN BENEDECIC C. SOLAJON
 ENGR. EDUARDO T. BARRERA JR.
 ENGR. JOHN T. CORTES

PROGRAMMING AND CONSTRUCTION:
 ENGR. CARLA L. BELIN
 ENGR. JORGE L. TILON
 ENGR. JUAN P. BARRERA JR.

RECOMMENDING APPROVAL:
 ENGR. ANDREW R. PRUDENCIO
 ENGR. ARTAVARDES V. GERONIMO


APPROVED BY:
 VICTOR M. REGIS N. SOTTO
 CITY MAYOR

SHEET CONTENT:
 FIRE DETECTION
 ALARM SYSTEM
 (FIDAS)


SHEET NO.
**AUX
 5673**

PROGRAM NOTES:
 1. SHALL BE SUBMITTED TO THE CITY ENGINEERING OFFICE FOR REVIEW AND APPROVAL.
 2. THE CONTRACTOR SHALL BE RESPONSIBLE FOR THE INSTALLATION AND MAINTENANCE OF THE SYSTEM.
 3. THE CONTRACTOR SHALL BE RESPONSIBLE FOR THE PROTECTION OF THE EXISTING STRUCTURE.
 4. THE CONTRACTOR SHALL BE RESPONSIBLE FOR THE PROTECTION OF THE EXISTING UTILITIES.
 5. THE CONTRACTOR SHALL BE RESPONSIBLE FOR THE PROTECTION OF THE EXISTING SERVICES.
 6. THE CONTRACTOR SHALL BE RESPONSIBLE FOR THE PROTECTION OF THE EXISTING EQUIPMENT.
 7. THE CONTRACTOR SHALL BE RESPONSIBLE FOR THE PROTECTION OF THE EXISTING MATERIALS.
 8. THE CONTRACTOR SHALL BE RESPONSIBLE FOR THE PROTECTION OF THE EXISTING WORKERS.
 9. THE CONTRACTOR SHALL BE RESPONSIBLE FOR THE PROTECTION OF THE EXISTING ENVIRONMENT.
 10. THE CONTRACTOR SHALL BE RESPONSIBLE FOR THE PROTECTION OF THE EXISTING COMMUNITY.

CONFORME & ACCEPTED BY:
 CONTRACTOR

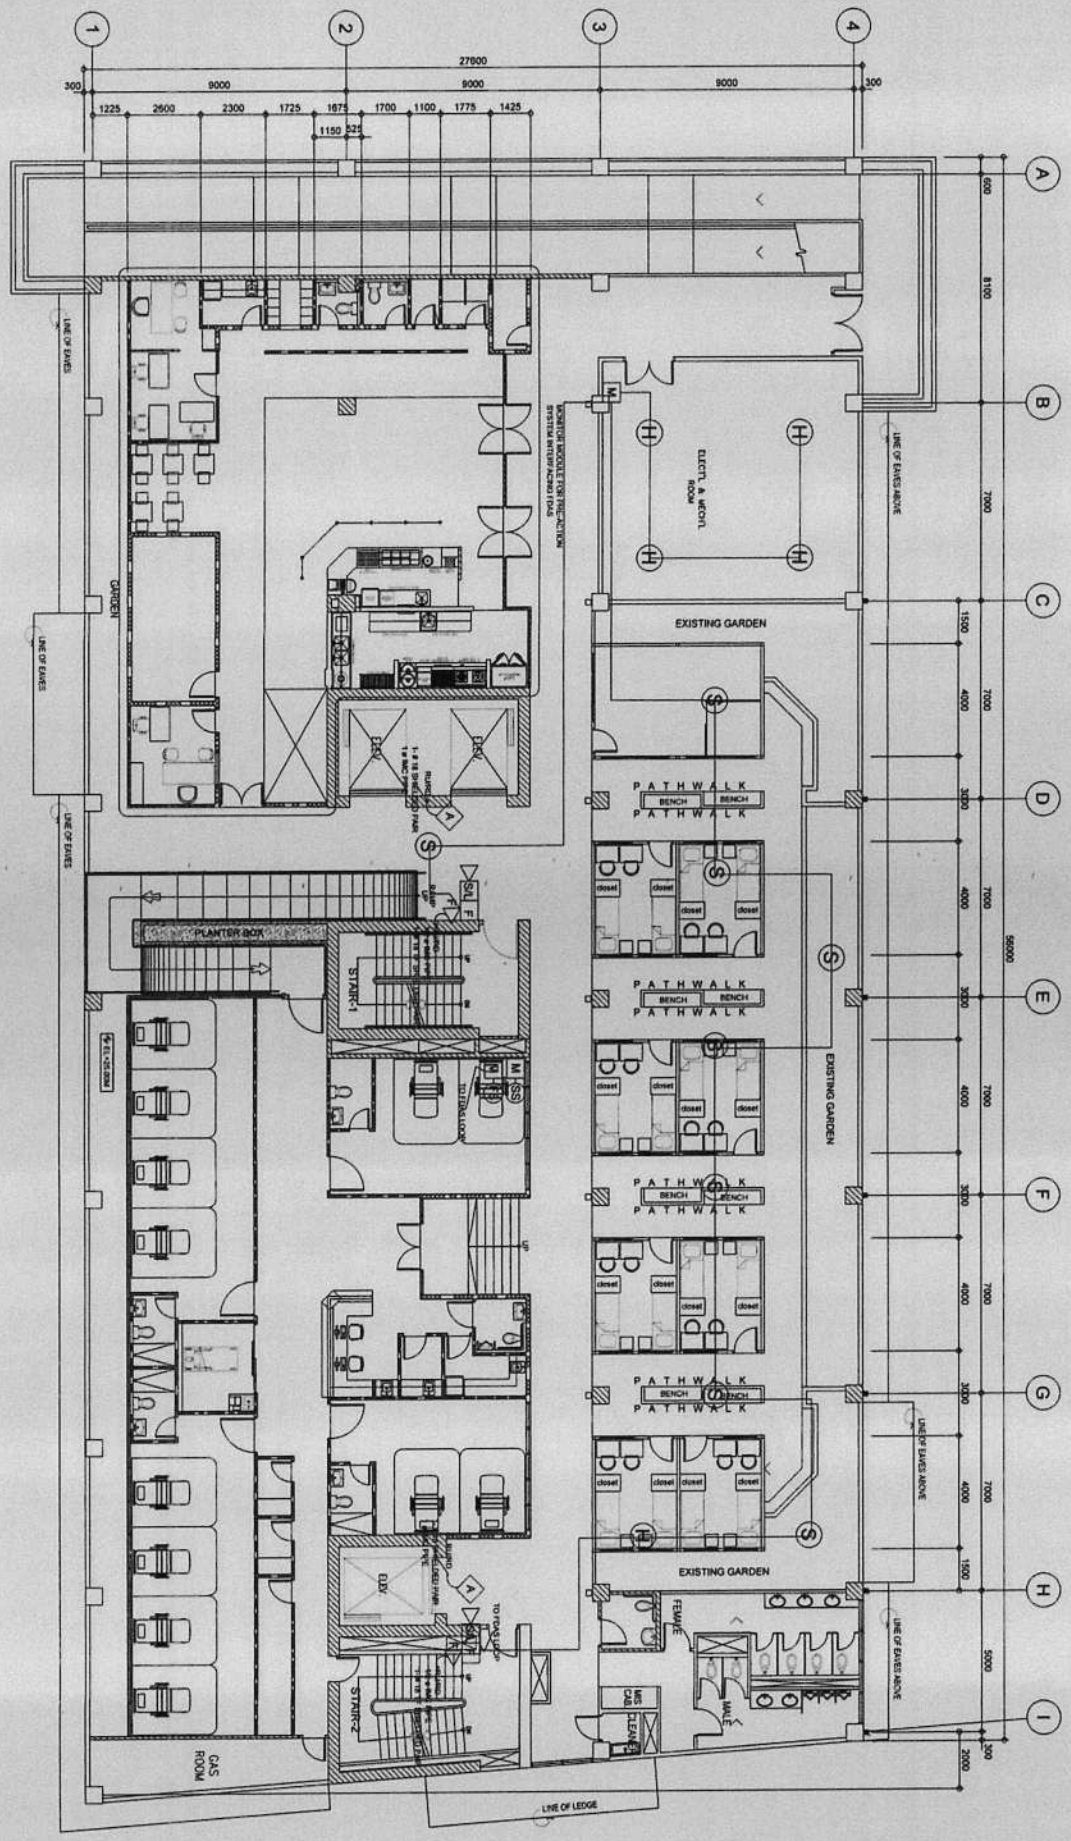


ROOF DECK FIRE DETECTION & ALARM SYSTEM LAYOUT
 1" = 1/8" SCALE

	REPUBLIC OF THE PHILIPPINES CITY OF PASIG OFFICE OF THE MAYOR CITY ENGINEERING OFFICE	PROJECT TITLE PROPOSED EXPANSION WITH IMPROVEMENT WORKS AT PASIG CITY CHILDREN'S HOSPITAL LOCATION: INDUSTRIAL COR. ALTAJOE JOSE STS. MARASIGAN, PASIG CITY	PROJECT IN CHARGE: ENGR. CHERYL ANN SANCHEZ PROJECT ARCHITECT: C. SOLONON ENGR. CHERYL ANN SANCHEZ ENGR. EDUARDO C. BARRANDA JR. ENGR. JOHN FRANCIS T. CORTES
PROGRAMMING AND CONSTRUCTION: ENGR. LORENZO L. TIZOU ENGR. LORENZO L. TIZOU		RECOMMENDING APPROVAL: ENGR. JUAN CARLOS B. PRUDENCIO ENGR. ARTAVERDE V. GERONIMO	
APPROVED BY: VICTOR MA. REGIS N. SOTTO CITY MAYOR		SHEET CONTENT: FIRE DETECTION ALARM SYSTEM LAYOUT (PDS)	
SHEET NO.: AUX 5773		CONFORMER & ACCEPTED BY: CONTRACTOR	

IMPORTANT NOTES:

1. ALL UTILITIES ARE TO BE MAINTAINED AND PROTECTED AT ALL TIMES. ANY DAMAGE TO UTILITIES SHALL BE REPAIRED BY THE CONTRACTOR.
2. ALL WORK SHALL BE DONE IN ACCORDANCE WITH THE LATEST EDITIONS OF THE NATIONAL ELECTRICAL CODE (NEC) AND THE NATIONAL FIRE ALARM CODE (NFAC).
3. IN CASE OF CONFLICT BETWEEN THE CONTRACT DOCUMENTS, THE CONTRACT DOCUMENTS SHALL PREVAIL OVER THE GENERAL CONDITIONS OF CONTRACT.
4. CONSTRUCTION OF THIS WORK SHALL BE COMPLETED AT THE DISCRETION OF THE CONTRACTOR.
5. CONTRACTOR SHALL BE RESPONSIBLE FOR THE PROTECTION AND MAINTENANCE OF ALL EXISTING UTILITIES AND STRUCTURES.

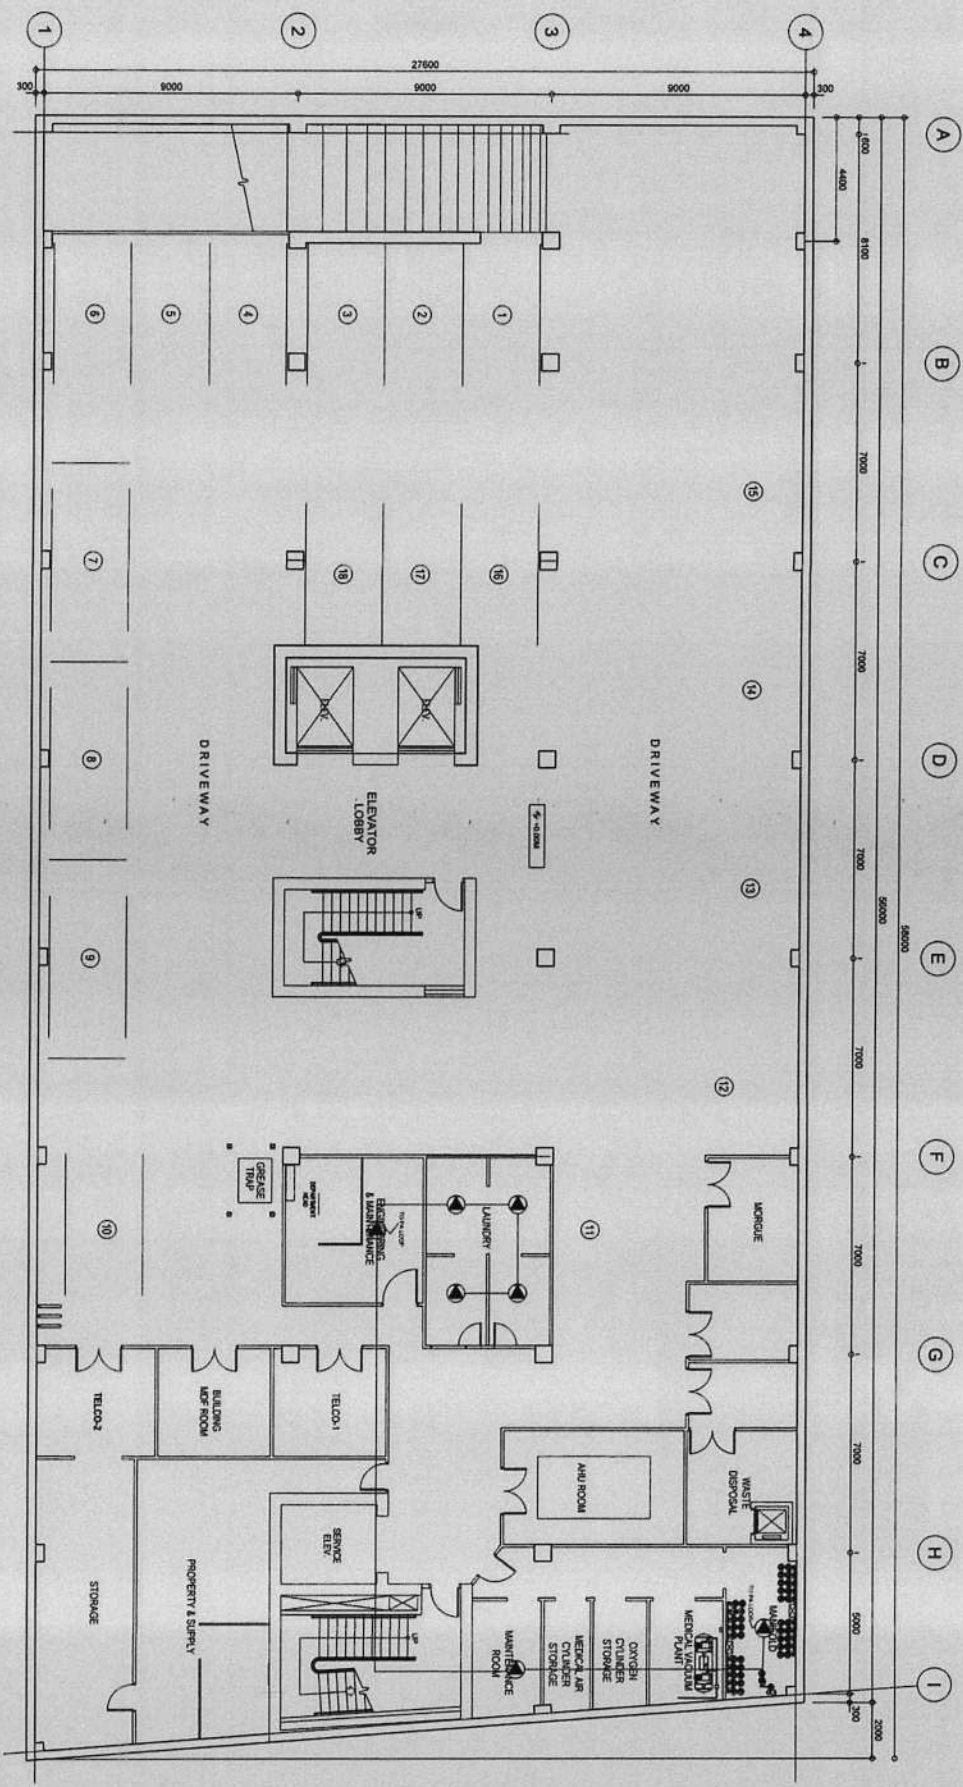

BASEMENT BGMPA SYSTEM LAYOUT
 1:100 M.A.S.
 A 100 SCALE

	REPUBLIC OF THE PHILIPPINES OFFICE OF THE MAYOR CITY ENGINEERING OFFICE	PROJECT TITLE: PROPOSED EXPANSION W/ IMPROVEMENT WORKS AT PASIG CITY CHILDREN'S HOSPITAL	PROJECT IN CHARGE: ENGR. CHRISTOPHER S. SOLONON	PROGRAMMING AND CONSTRUCTION: ENGR. C. S. BELIN	RECOMMENDING APPROVAL: ENGR. DAVID E. TRUENDENO	APPROVED BY: VICTOR M. REGIS N. SOTTO CITY MAYOR	SHEET CONTENT: PLUMBING AND ELECTRICAL SYSTEMS LAYOUT	SHEET NO. AUX 5873
	LOCATION: PASIG CITY, ALCALDE JOSE STS.	ENGR. EDUARDO G. BARRERA JR. ENGR. JOHN T. COATES	ENGR. C. S. BELIN ENGR. JORGE L. TIZON	ENGR. DAVID E. TRUENDENO ENGR. ARTAXERES V. GERONIMO	ENGR. DAVID E. TRUENDENO ENGR. ARTAXERES V. GERONIMO	APPROVED BY: VICTOR M. REGIS N. SOTTO CITY MAYOR	SHEET CONTENT: PLUMBING AND ELECTRICAL SYSTEMS LAYOUT	SHEET NO. AUX 5873

1. THE CONTRACTOR SHALL BE RESPONSIBLE FOR THE PROTECTION OF ALL EXISTING UTILITIES AND STRUCTURES TO REMAIN. ANY DAMAGE TO EXISTING UTILITIES OR STRUCTURES SHALL BE REPAIRED AT THE CONTRACTOR'S EXPENSE.


2. THE CONTRACTOR SHALL BE RESPONSIBLE FOR THE PROTECTION OF ALL EXISTING UTILITIES AND STRUCTURES TO REMAIN. ANY DAMAGE TO EXISTING UTILITIES OR STRUCTURES SHALL BE REPAIRED AT THE CONTRACTOR'S EXPENSE.

3. THE CONTRACTOR SHALL BE RESPONSIBLE FOR THE PROTECTION OF ALL EXISTING UTILITIES AND STRUCTURES TO REMAIN. ANY DAMAGE TO EXISTING UTILITIES OR STRUCTURES SHALL BE REPAIRED AT THE CONTRACTOR'S EXPENSE.


4. THE CONTRACTOR SHALL BE RESPONSIBLE FOR THE PROTECTION OF ALL EXISTING UTILITIES AND STRUCTURES TO REMAIN. ANY DAMAGE TO EXISTING UTILITIES OR STRUCTURES SHALL BE REPAIRED AT THE CONTRACTOR'S EXPENSE.

5. THE CONTRACTOR SHALL BE RESPONSIBLE FOR THE PROTECTION OF ALL EXISTING UTILITIES AND STRUCTURES TO REMAIN. ANY DAMAGE TO EXISTING UTILITIES OR STRUCTURES SHALL BE REPAIRED AT THE CONTRACTOR'S EXPENSE.

CONTRACTOR

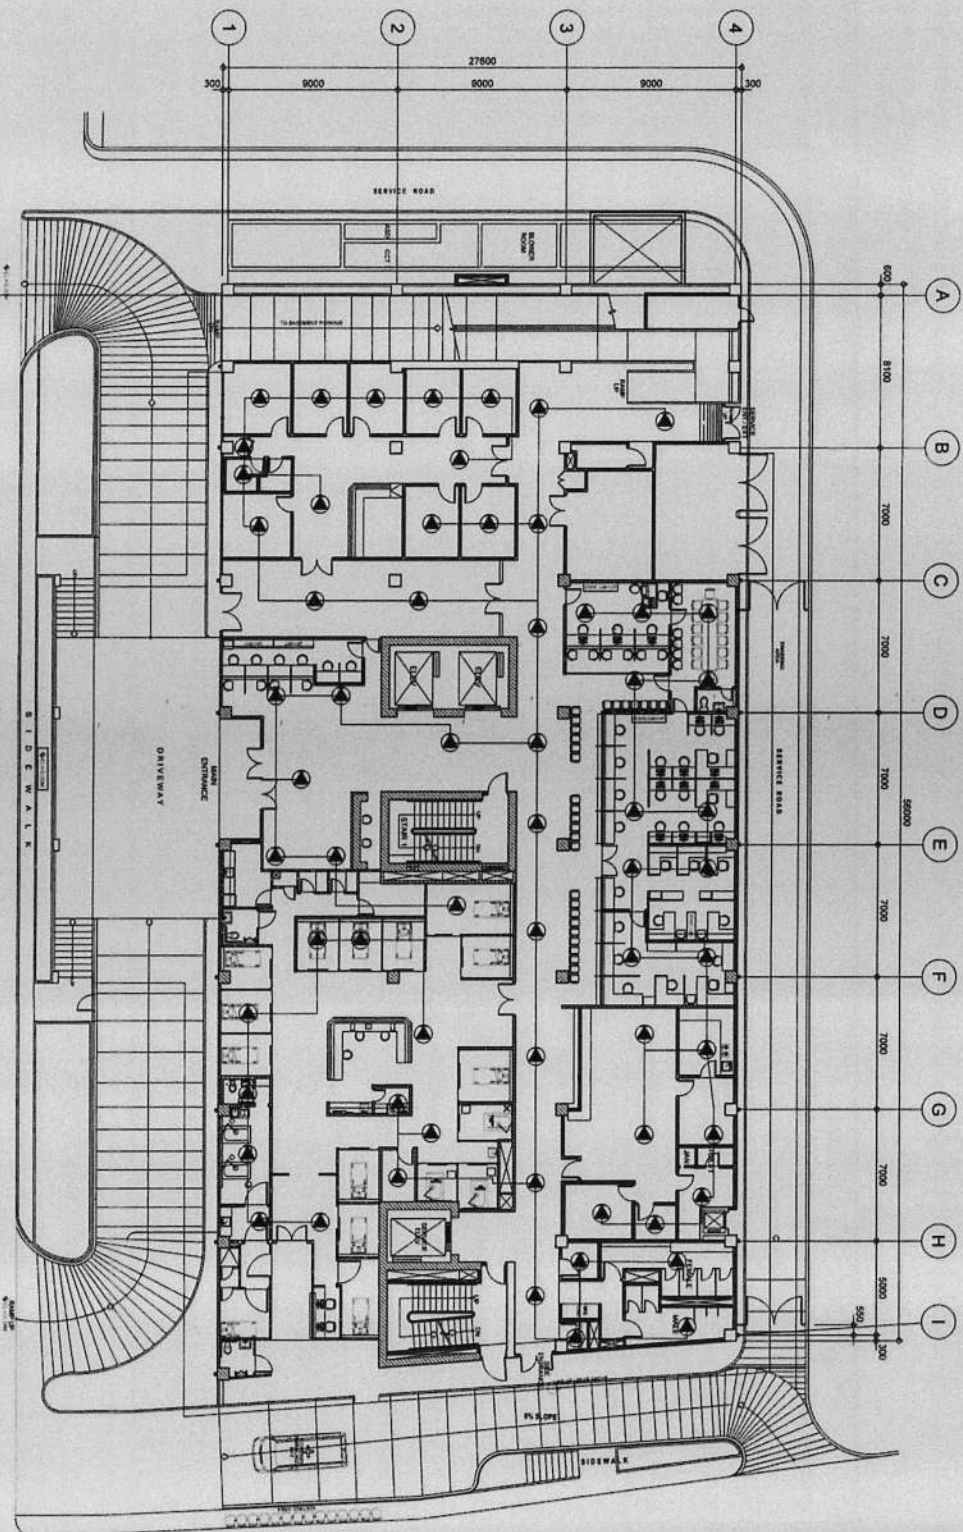


GROUND BGMPA SYSTEM LAYOUT
 1:100 MM
 SCALE

 REPUBLIC OF THE PHILIPPINES CITY OF PASIG OFFICE OF THE MAYOR CITY ENGINEERING OFFICE	PROJECT TITLE	PROJECT IN CHARGE	PROGRAMMING AND CONSTRUCTION	RECOMMENDING APPROVAL	APPROVED BY:	SHEET CONTENT	SHEET NO.
	PROPOSED EXPANSION W/ IMPROVEMENT WORKS AT PASIG CITY CHILDREN'S HOSPITAL LOCATION: NAKASIPAN, PASIG CITY NAKASIPAN COR. AL CALPE JOSE STS.	ENGR. CHESTER S. SOLORSON ENGR. GILBERTO D. BARBUJA, JR. ENGR. JOSE ANTONIO T. CORTES	ENGR. CARLOS L. BELLA ENGR. JORGE L. TIZON ENGR. JUAN CARLOS S. PRUDENCIO ENGR. ARTAVARDES V. GERONIMO	ENGR. VICTOR M. REGIS N. SOTTO CITY MAYOR	PUBLIC ADDRESS SYSTEM WITH BACKGROUND MUSIC LAYOUT	59173	COMPONENTS & ACCEPTED BY: CONTRACTOR

IMPORTANT NOTES:

1. THIS SYSTEM IS TO BE INSTALLED IN ACCORDANCE WITH THE PROVISIONS OF THE NATIONAL ELECTRICAL CODE (NEC) AND THE NATIONAL FIRE ALARM AND SIGNALING CODE (NFAS).
2. CONTRACTOR SHALL BE RESPONSIBLE FOR OBTAINING ALL NECESSARY PERMITS AND APPROVALS FROM THE CITY ENGINEERING OFFICE AND THE PASIG CITY ENGINEERING OFFICE.
3. TO BE AFFECTED WORK SHALL BE IDENTIFIED BY THE CONTRACTOR AND THE CITY ENGINEERING OFFICE. CONTRACTOR SHALL BE RESPONSIBLE FOR THE PROTECTION OF THE EXISTING UTILITIES.
4. CONTRACTOR SHALL BE RESPONSIBLE FOR THE PROTECTION OF THE EXISTING UTILITIES.
5. CONTRACTOR SHALL BE RESPONSIBLE FOR THE PROTECTION OF THE EXISTING UTILITIES.

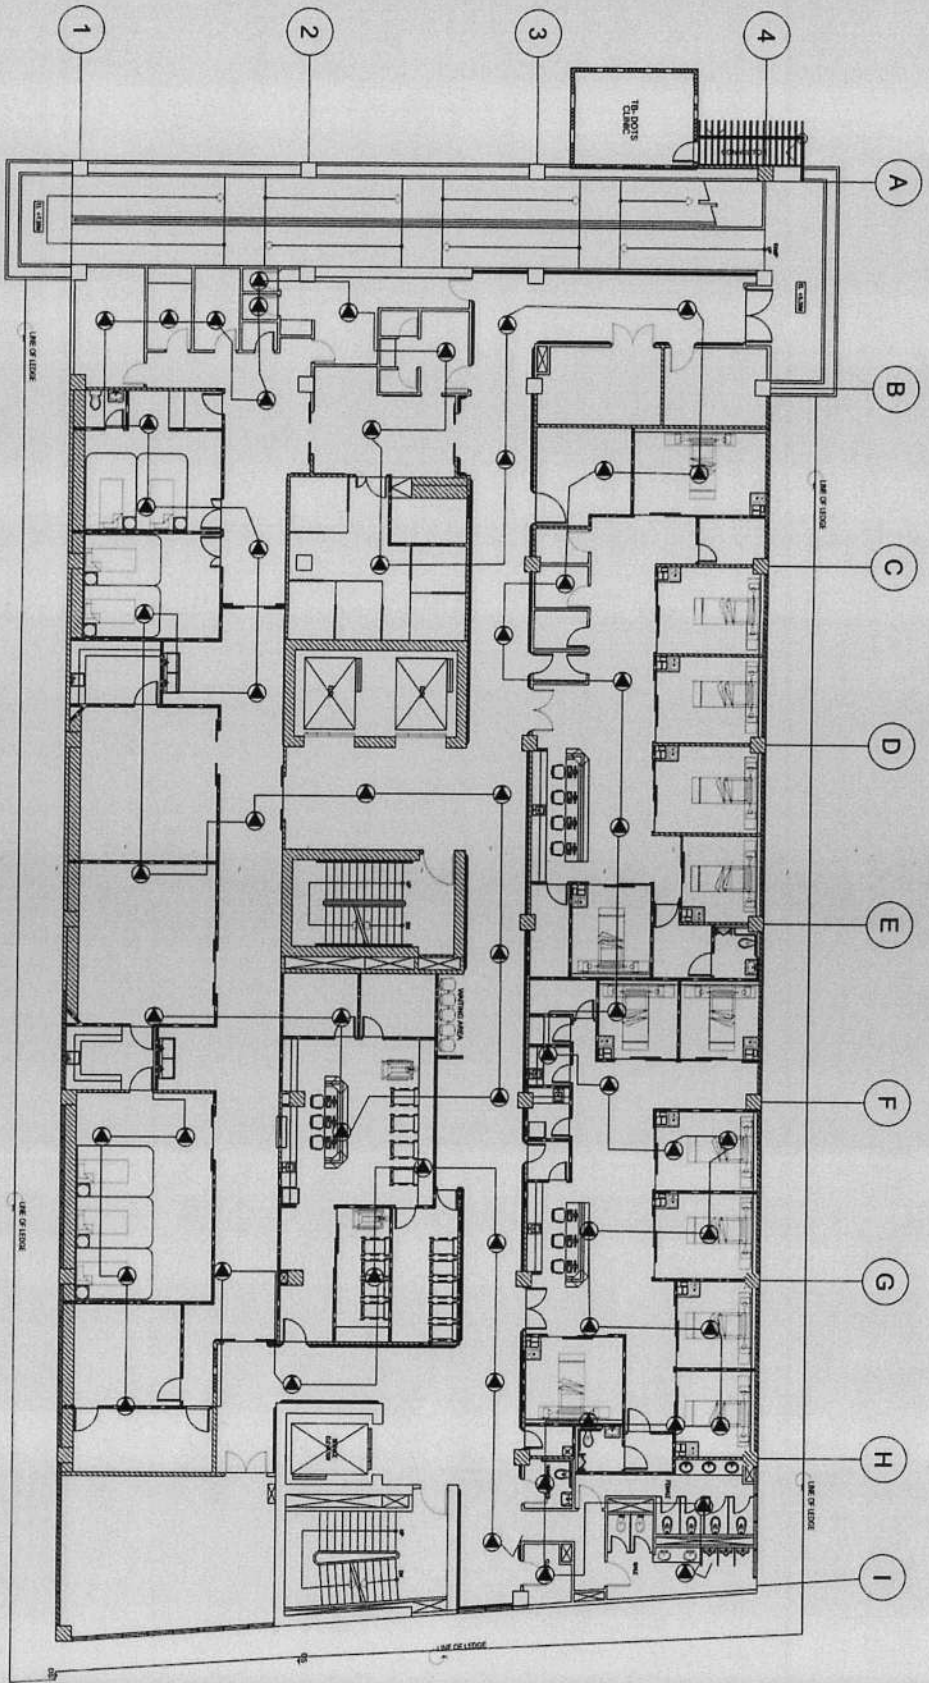

SECOND BGM/PA SYSTEM LAYOUT
 00 SCALE
 1:100 IMA



REPUBLIC OF THE PHILIPPINES
 CITY OF PASIG
 OFFICE OF THE MAYOR
 CITY ENGINEERING OFFICE

PROJECT TITLE
**PROPOSED EXPANSION W/
 IMPROVEMENT WORKS AT
 PASIG CITY CHILDREN'S HOSPITAL**

PROJECT IN CHARGE
 ENGR. **CHRISTOPHER C. SOLONON**
 ENGR. **EDUARDO & BANERUA JR.**
 ENGR. **JOHN J. BELLA I. COMTES**

PROGRAMMING AND CONSTRUCTION
 ENGR. **GEORGE L. TIZON**
 ENGR. **FRANCISCA BRUDERICO**
 ENGR. **ARTALBERO V. GERONIMO**

RECOMMENDING APPROVAL
 ENGR. **VICTOR MA. REGIS N. SOTTO**
 CITY ENGINEER

APPROVED BY
 VICTOR MA. REGIS N. SOTTO
 CITY ENGINEER

SHEET CONTENT:
 PUBLIC ADDRESS
 SYSTEM AND WOOD
 STRUCTURE

SHEET NO.
**AUX
 6073**

IMPORTANT NOTES:
 1. NO. 1. IN ALL WORKS, THE CONTRACTOR SHALL BE RESPONSIBLE FOR THE PROTECTION AND MAINTENANCE OF ALL UTILITIES AND STRUCTURES UNDERGROUND AND ABOVEGROUND.
 2. THE CONTRACTOR SHALL BE RESPONSIBLE FOR THE PROTECTION AND MAINTENANCE OF ALL UTILITIES AND STRUCTURES UNDERGROUND AND ABOVEGROUND.
 3. IN CASE OF CONFLICT BETWEEN THE CONTRACTOR'S INTERPRETATION OF THE DRAWINGS AND THE CONTRACTOR'S INTERPRETATION OF THE CONTRACT DOCUMENTS, THE CONTRACTOR SHALL BE RESPONSIBLE FOR THE PROTECTION AND MAINTENANCE OF ALL UTILITIES AND STRUCTURES UNDERGROUND AND ABOVEGROUND.
 4. ANY MODIFICATION OF THIS DRAWING SHALL BE CONNECTED AT THE END OF THE SHEET.
 5. THIS IS A PART OF THE PROJECT'S ARCHITECTURAL DRAWINGS. THE PROJECT IS A PART OF THE PROJECT'S ARCHITECTURAL DRAWINGS.
 6. SHEET NO. 6073 IS THE PROJECT'S ARCHITECTURAL DRAWINGS.

CONTRACTOR



REPUBLIC OF THE PHILIPPINES
CITY OF PASIG
OFFICE OF THE MAYOR
CITY ENGINEERING OFFICE

PROJECT TITLE
**PROPOSED EXPANSION W/
IMPROVEMENT WORKS AT
PASIG CITY CHILDREN'S HOSPITAL**

PROJECT IN CHARGE
ENGR. CHRISTOPHER M. SOLONON

PROGRAMMING AND CONSTRUCTION
ENGR. CARL BELIN

RECOMMENDING APPROVAL
ENGR. JOSE L. TON

APPROVED BY
VICTOR MA. REGIS N. SOTTO
CITY MAYOR


SHEET NO.:
AUX
6173


CONFORME & ACCEPTED BY
PUBLIC ADDRESS
SYSTEM WITH
BACKGROUND MUSIC
LAYOUT

CONTRACTOR

IMPORTANT NOTES
1. NO ALTERATION IN DIMENSIONS OR MATERIALS SHALL BE MADE WITHOUT THE WRITTEN APPROVAL OF THE ARCHITECT.
2. THE CONTRACTOR SHALL BE RESPONSIBLE FOR OBTAINING ALL NECESSARY PERMITS AND APPROVALS FROM THE APPROPRIATE AGENCIES.
3. THE CONTRACTOR SHALL BE RESPONSIBLE FOR THE PROTECTION OF ALL EXISTING UTILITIES AND STRUCTURES.
4. APPROVAL OF THE ARCHITECT SHALL BE OBTAINED AT THE ONSET OF THE CONSTRUCTION.
5. THE CONTRACTOR SHALL BE RESPONSIBLE FOR THE PROTECTION OF ALL EXISTING UTILITIES AND STRUCTURES.
6. THE CONTRACTOR SHALL BE RESPONSIBLE FOR THE PROTECTION OF ALL EXISTING UTILITIES AND STRUCTURES.

THIRD BGM/PA SYSTEM LAYOUT
SCALE 1:100

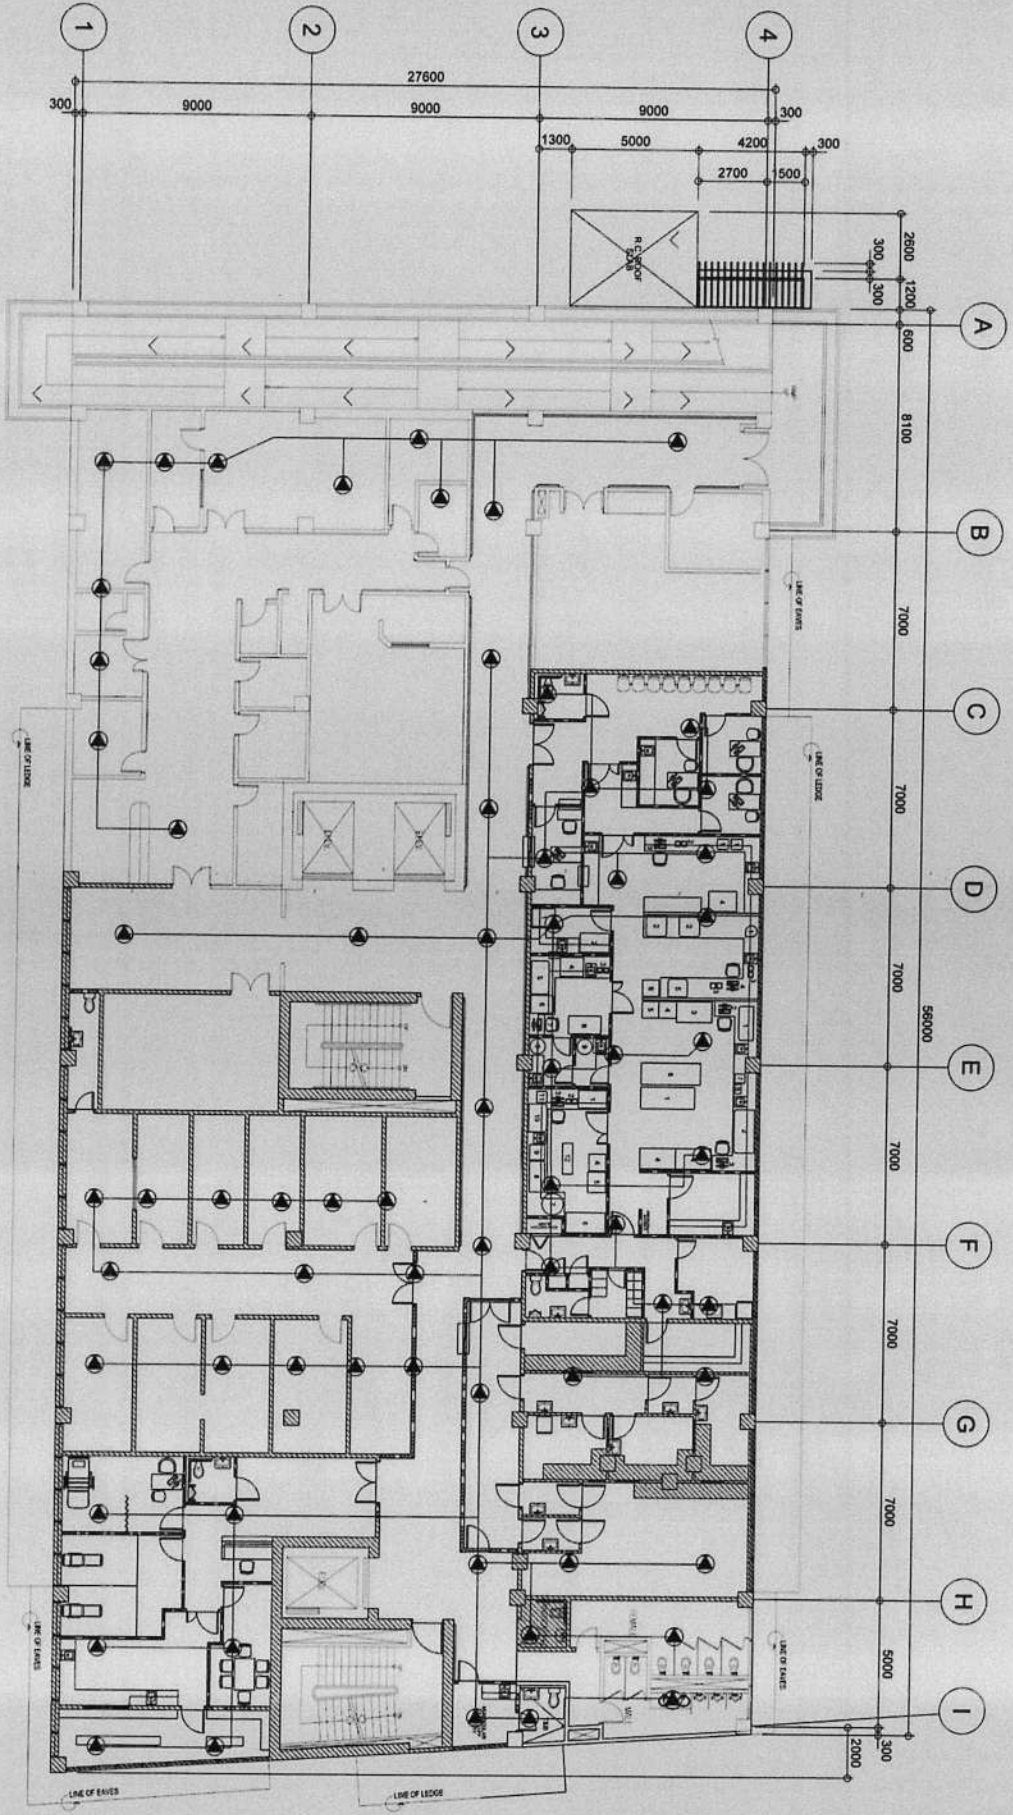


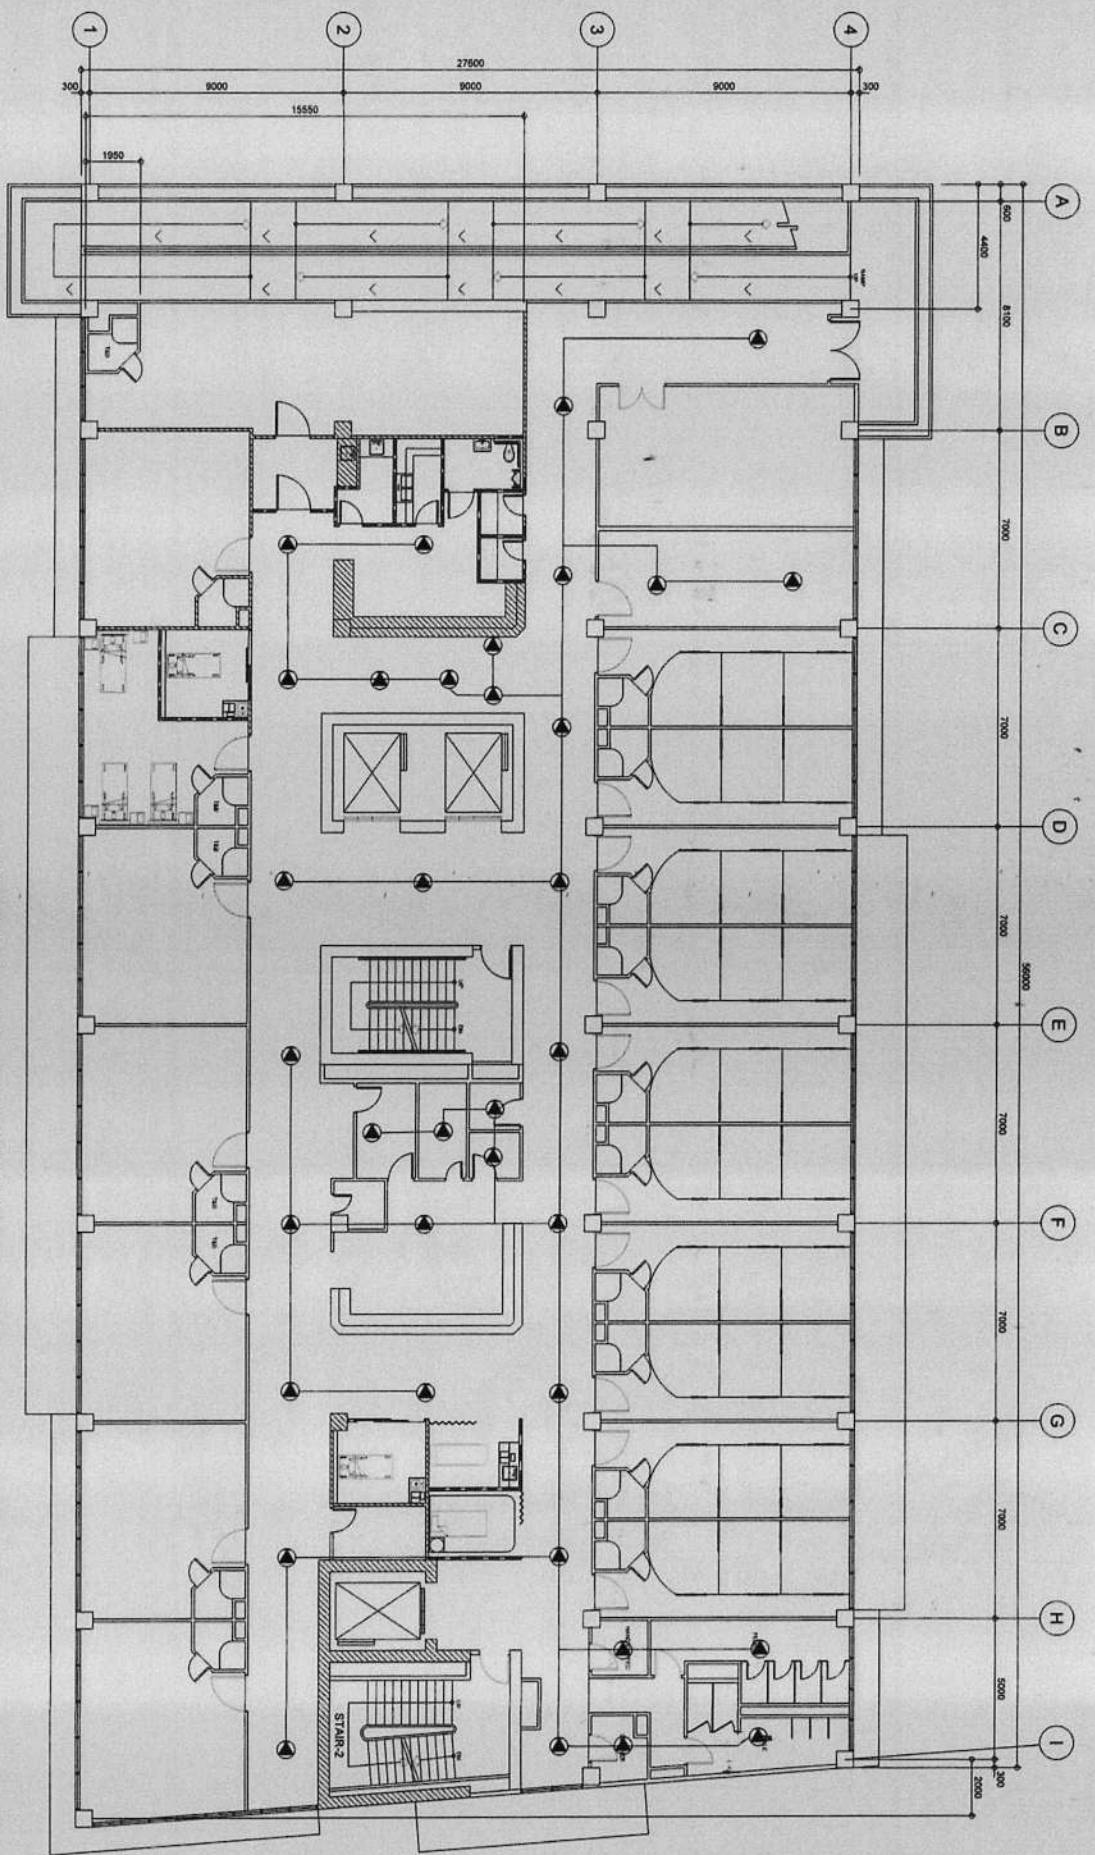

FOURTH BGM/PA SYSTEM LAYOUT
 00 SCALE
 1:100 AXL

	REPUBLIC OF THE PHILIPPINES CITY OF PASIG OFFICE OF THE MAYOR CITY ENGINEERING OFFICE	PROJECT TITLE PROPOSED EXPANSION W/ IMPROVEMENT WORKS AT PASIG CITY CHILDREN'S HOSPITAL	PROJECT IN CHARGE ENGR. CHRISTOPHER P. SOLACION ENGR. EDUARDO G. BARBERICA, JR. ENGR. JOHN H. DEVALA, T. CORTES	PROGRAMMING AND CONSTRUCTION ENGR. CHERRYL BELLI ENGR. JOSE L. TIZON ENGR. JAMES B. PRUDENCIO	RECOMMENDING APPROVAL ENGR. ARTAVARDES V. GERONIMO	APPROVED BY: VICTOR M. TEGIS N. SOTTO CITY MAYOR	SHEET CONTENT PUBLIC ADDRESS SYSTEM WITH BACKGROUND MUSIC LAYOUT	SHEET NO.
	IMPORTANT NOTES 1. USE OF CONTRACTOR TO BE DETERMINED BY THE ARCHITECT. 2. CONTRACTOR TO BE DETERMINED BY THE ARCHITECT. 3. TO BE DETERMINED BY THE ARCHITECT. 4. CONTRACTOR TO BE DETERMINED BY THE ARCHITECT. 5. CONTRACTOR TO BE DETERMINED BY THE ARCHITECT. 6. CONTRACTOR TO BE DETERMINED BY THE ARCHITECT. 7. CONTRACTOR TO BE DETERMINED BY THE ARCHITECT. 8. CONTRACTOR TO BE DETERMINED BY THE ARCHITECT. 9. CONTRACTOR TO BE DETERMINED BY THE ARCHITECT.	LOCATION INDUSTRIAL CORP. ACADRE JOSE STS. PASIG CITY	PROJECT IN CHARGE ENGR. CHERRYL BELLI ENGR. JOSE L. TIZON ENGR. JAMES B. PRUDENCIO	RECOMMENDING APPROVAL ENGR. ARTAVARDES V. GERONIMO	APPROVED BY: VICTOR M. TEGIS N. SOTTO CITY MAYOR	SHEET CONTENT PUBLIC ADDRESS SYSTEM WITH BACKGROUND MUSIC LAYOUT	SHEET NO. 	

CONTRACTOR

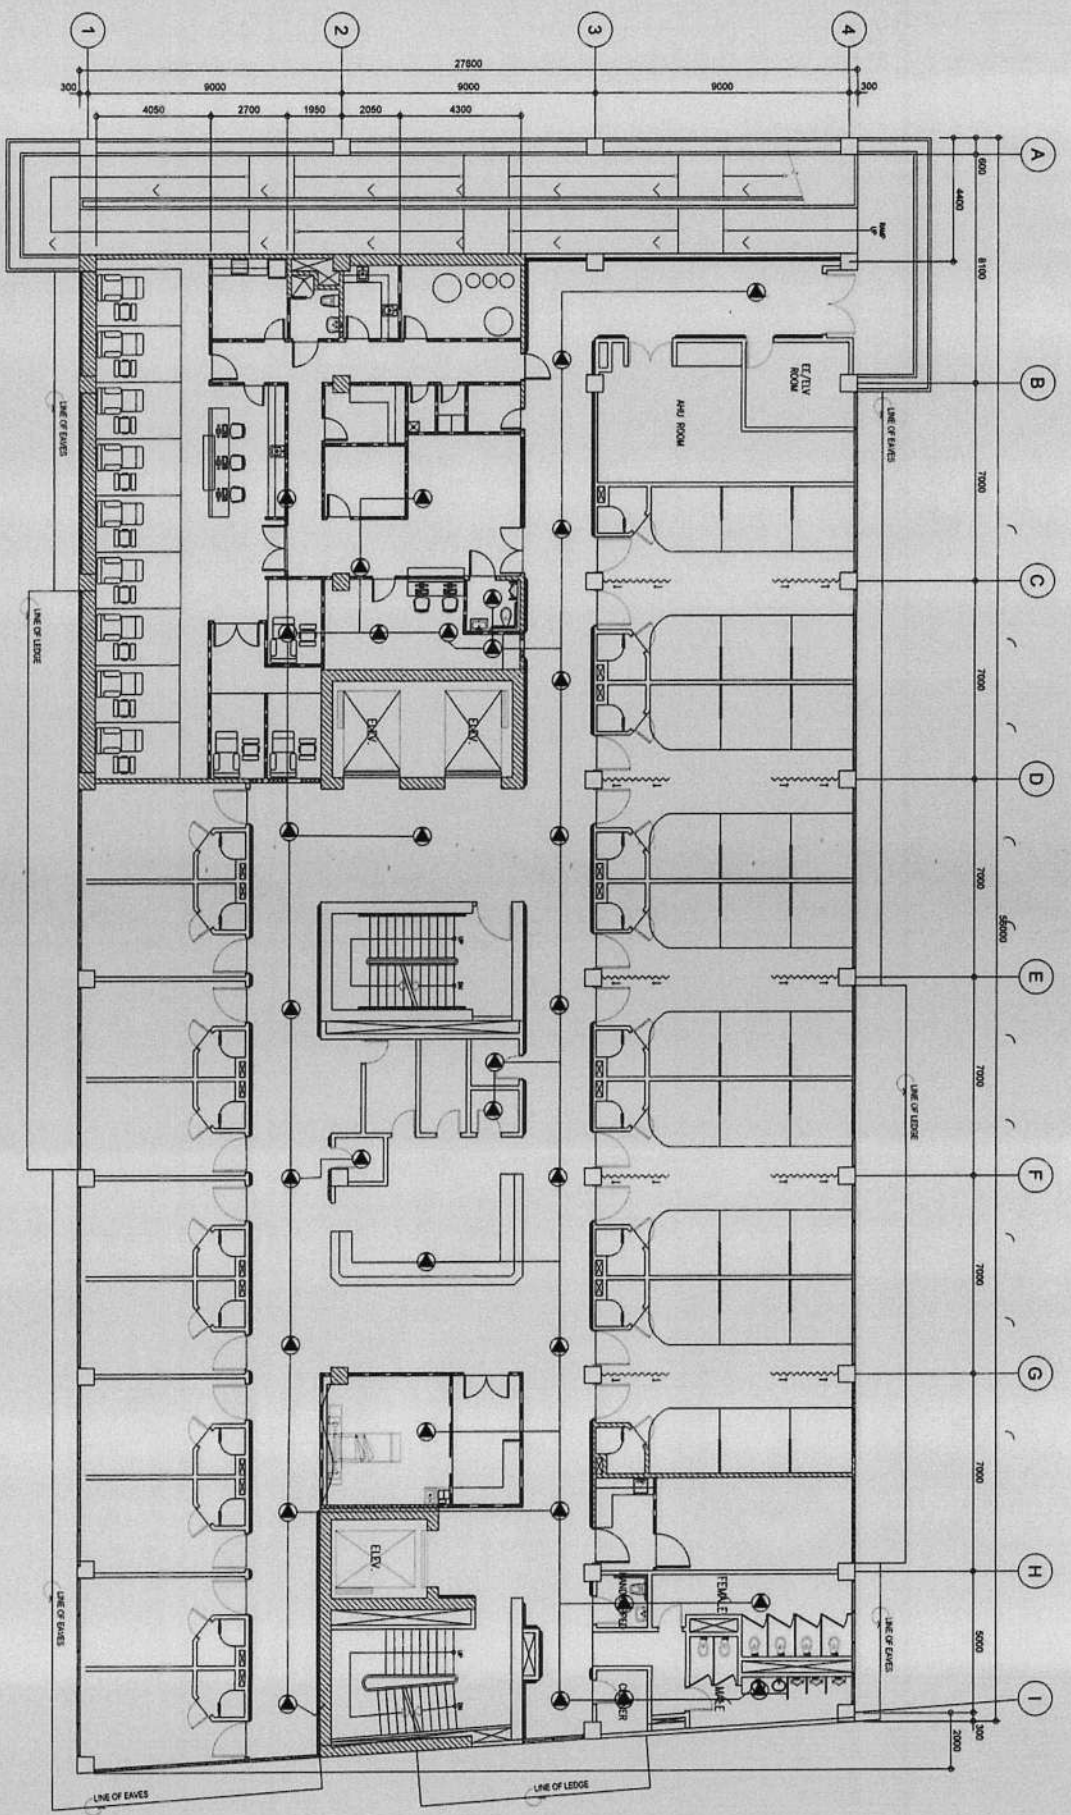

FIFTH FLOOR BGMPA SYSTEM LAYOUT
 00 SCALE 1:100 ILL.



REPUBLIC OF THE PHILIPPINES
 CITY OF PASIG
 OFFICE OF THE MAYOR
 CITY ENGINEERING OFFICE

PROJECT TITLE
**PROPOSED EXPANSION W/
 IMPROVEMENT WORKS AND
 PASIG CITY CHILDREN'S HOSPITAL**

PROJECT IN CHARGE
 ENGR. *[Signature]* DIRECTOR C. SOLACION
 ENGR. EDUARDO BARRERA, JR. ENGR. JOHN DEBENA T. CORTES

PROGRAMMING AND CONSTRUCTION
 ENGR. *[Signature]* JORGE L. TIZON
 ENGR. *[Signature]* CARLOS B. BENDUENCO

RECOMMENDING APPROVAL
 ENGR. *[Signature]* ARTAVENDES V. GERONIMO


APPROVED BY:
 VICTOR MA. REGIS N. SOTTO
 CITY MAYOR

SHEET CONTENT
 PUBLIC ADDRESS
 SYSTEM WITH
 BACKGROUND MUSIC
 LAYOUT

SHEET NO.
AUX 6373


IMPORTANT NOTES
 1. NO ALTERATION IN THE DESIGN AND CONSTRUCTION SHALL BE MADE WITHOUT THE WRITTEN APPROVAL OF THE ENGINEER.
 2. THE CONTRACTOR SHALL BE RESPONSIBLE FOR THE PROTECTION OF THE EXISTING UTILITIES AND STRUCTURES.
 3. THE CONTRACTOR SHALL BE RESPONSIBLE FOR THE PROTECTION OF THE EXISTING UTILITIES AND STRUCTURES.
 4. THE CONTRACTOR SHALL BE RESPONSIBLE FOR THE PROTECTION OF THE EXISTING UTILITIES AND STRUCTURES.
 5. THE CONTRACTOR SHALL BE RESPONSIBLE FOR THE PROTECTION OF THE EXISTING UTILITIES AND STRUCTURES.
 6. THE CONTRACTOR SHALL BE RESPONSIBLE FOR THE PROTECTION OF THE EXISTING UTILITIES AND STRUCTURES.

CONTRACTOR

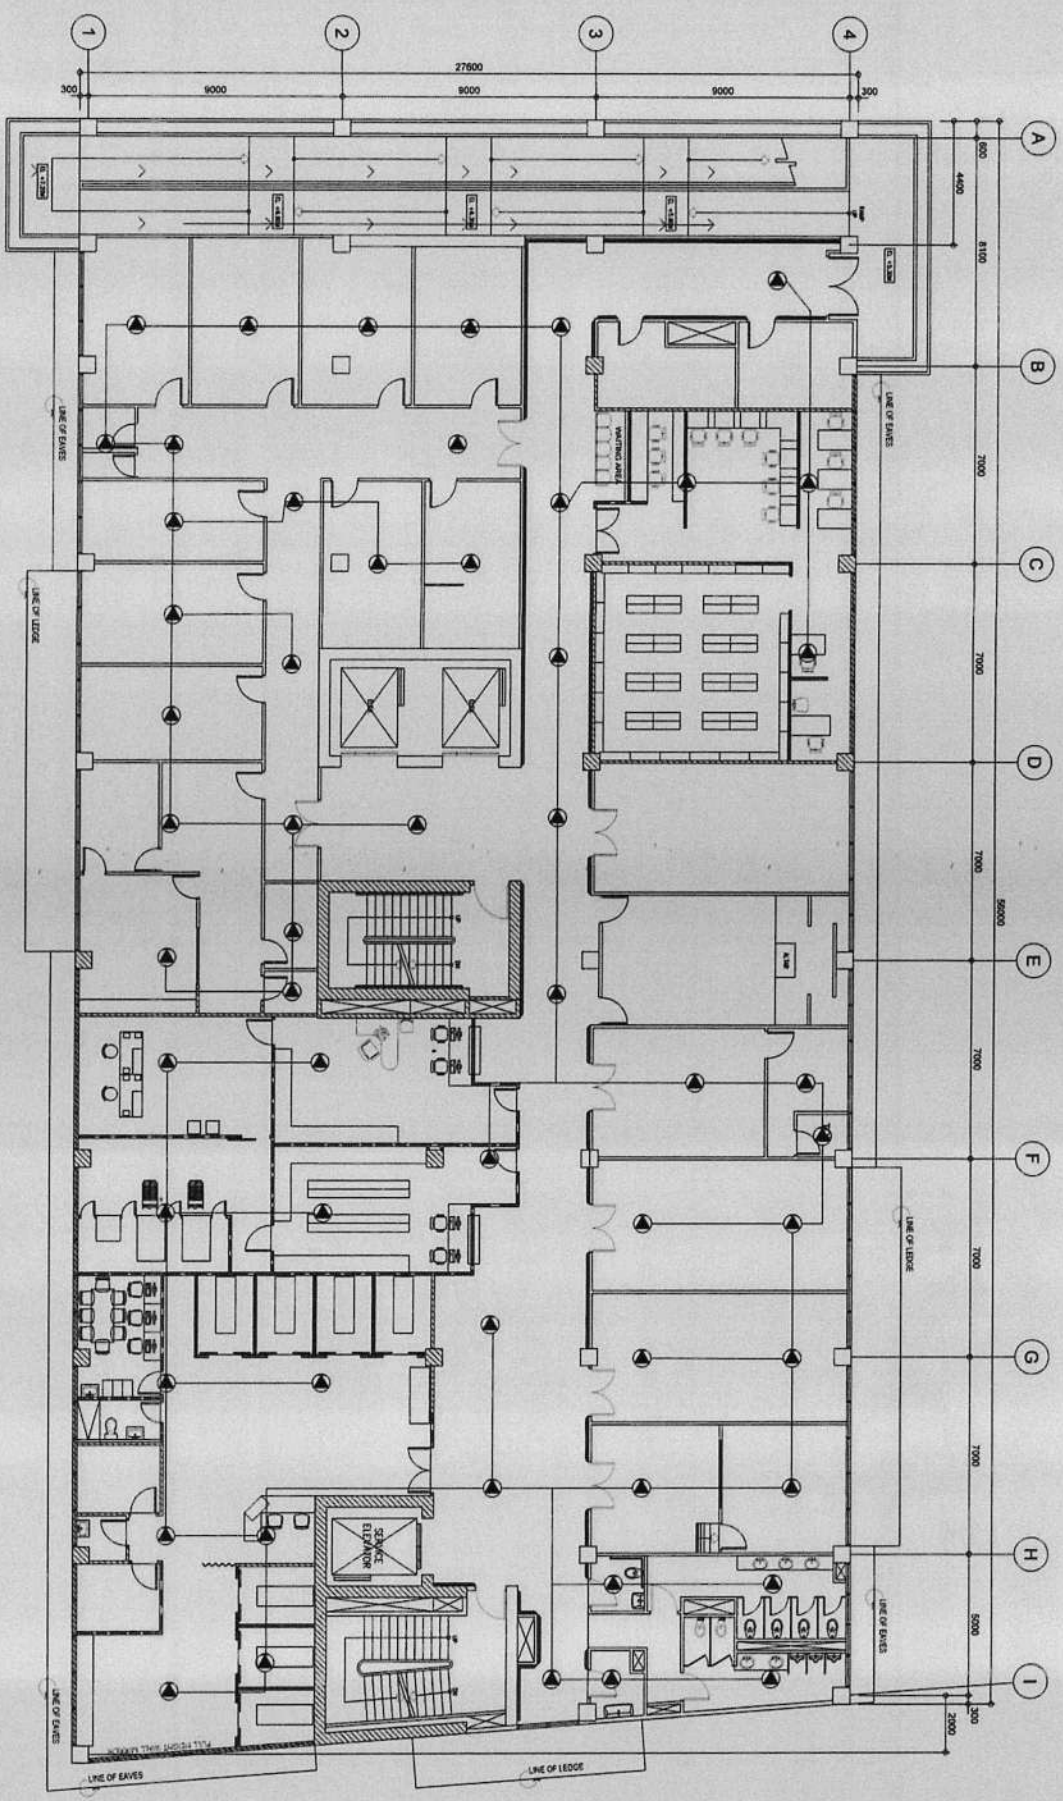

PROPOSED LAYOUT FOR REPAIR WORKS
SIXTH FLOOR BGMPA SYSTEM LAYOUT

	REPUBLIC OF THE PHILIPPINES CITY OF PASIG OFFICE OF THE MAYOR CITY ENGINEERING OFFICE	PROJECT TITLE PROPOSED EXPANSION W/ IMPROVEMENT WORKS AT PASIG CITY CHILDREN'S HOSPITAL	PROJECT IN CHARGE ENGR. CHRISTOPHER B. SOLOMON ENGR. EDUARDO G. BARBUENA, JR. ENGR. JOYCE S. SERRA, T. CORTES	PROGRAMMING AND CONSTRUCTION ENGR. CARVAL BELLA ENGR. JORGE L. TIZON OIC ELECTRICAL INFRASTRUCTURE SECTION	RECOMMENDING APPROVAL ENGR. JAMES B. PRUDENCIO OIC ELECTRICAL INFRASTRUCTURE SECTION	APPROVED BY: VICTOR MA. REGIS N. SOTTO CITY MAYOR	SHEET CONTENT: PUBLIC ADDRESS SYSTEM WITH BACKGROUND MUSIC LAYOUT	SHEET NO.:
	LOCATION: MONTEBONA CORP. ALA CALUPA JOSE STS. PASIG CITY, METROPOLITAN PASIG CITY	1. THE CONTRACTOR SHALL BE RESPONSIBLE FOR THE PROTECTION OF THE EXISTING UTILITIES AND STRUCTURES TO REMAIN. THE CONTRACTOR SHALL BE RESPONSIBLE FOR THE PROTECTION OF THE EXISTING UTILITIES AND STRUCTURES TO REMAIN. 2. THE CONTRACTOR SHALL BE RESPONSIBLE FOR THE PROTECTION OF THE EXISTING UTILITIES AND STRUCTURES TO REMAIN. THE CONTRACTOR SHALL BE RESPONSIBLE FOR THE PROTECTION OF THE EXISTING UTILITIES AND STRUCTURES TO REMAIN. 3. THE CONTRACTOR SHALL BE RESPONSIBLE FOR THE PROTECTION OF THE EXISTING UTILITIES AND STRUCTURES TO REMAIN. THE CONTRACTOR SHALL BE RESPONSIBLE FOR THE PROTECTION OF THE EXISTING UTILITIES AND STRUCTURES TO REMAIN. 4. THE CONTRACTOR SHALL BE RESPONSIBLE FOR THE PROTECTION OF THE EXISTING UTILITIES AND STRUCTURES TO REMAIN. THE CONTRACTOR SHALL BE RESPONSIBLE FOR THE PROTECTION OF THE EXISTING UTILITIES AND STRUCTURES TO REMAIN. 5. THE CONTRACTOR SHALL BE RESPONSIBLE FOR THE PROTECTION OF THE EXISTING UTILITIES AND STRUCTURES TO REMAIN. THE CONTRACTOR SHALL BE RESPONSIBLE FOR THE PROTECTION OF THE EXISTING UTILITIES AND STRUCTURES TO REMAIN. 6. THE CONTRACTOR SHALL BE RESPONSIBLE FOR THE PROTECTION OF THE EXISTING UTILITIES AND STRUCTURES TO REMAIN. THE CONTRACTOR SHALL BE RESPONSIBLE FOR THE PROTECTION OF THE EXISTING UTILITIES AND STRUCTURES TO REMAIN.	1. THE CONTRACTOR SHALL BE RESPONSIBLE FOR THE PROTECTION OF THE EXISTING UTILITIES AND STRUCTURES TO REMAIN. THE CONTRACTOR SHALL BE RESPONSIBLE FOR THE PROTECTION OF THE EXISTING UTILITIES AND STRUCTURES TO REMAIN. 2. THE CONTRACTOR SHALL BE RESPONSIBLE FOR THE PROTECTION OF THE EXISTING UTILITIES AND STRUCTURES TO REMAIN. THE CONTRACTOR SHALL BE RESPONSIBLE FOR THE PROTECTION OF THE EXISTING UTILITIES AND STRUCTURES TO REMAIN. 3. THE CONTRACTOR SHALL BE RESPONSIBLE FOR THE PROTECTION OF THE EXISTING UTILITIES AND STRUCTURES TO REMAIN. THE CONTRACTOR SHALL BE RESPONSIBLE FOR THE PROTECTION OF THE EXISTING UTILITIES AND STRUCTURES TO REMAIN. 4. THE CONTRACTOR SHALL BE RESPONSIBLE FOR THE PROTECTION OF THE EXISTING UTILITIES AND STRUCTURES TO REMAIN. THE CONTRACTOR SHALL BE RESPONSIBLE FOR THE PROTECTION OF THE EXISTING UTILITIES AND STRUCTURES TO REMAIN. 5. THE CONTRACTOR SHALL BE RESPONSIBLE FOR THE PROTECTION OF THE EXISTING UTILITIES AND STRUCTURES TO REMAIN. THE CONTRACTOR SHALL BE RESPONSIBLE FOR THE PROTECTION OF THE EXISTING UTILITIES AND STRUCTURES TO REMAIN. 6. THE CONTRACTOR SHALL BE RESPONSIBLE FOR THE PROTECTION OF THE EXISTING UTILITIES AND STRUCTURES TO REMAIN. THE CONTRACTOR SHALL BE RESPONSIBLE FOR THE PROTECTION OF THE EXISTING UTILITIES AND STRUCTURES TO REMAIN.	CONTRACTOR & ACCEPTED BY: CONTRACTOR				

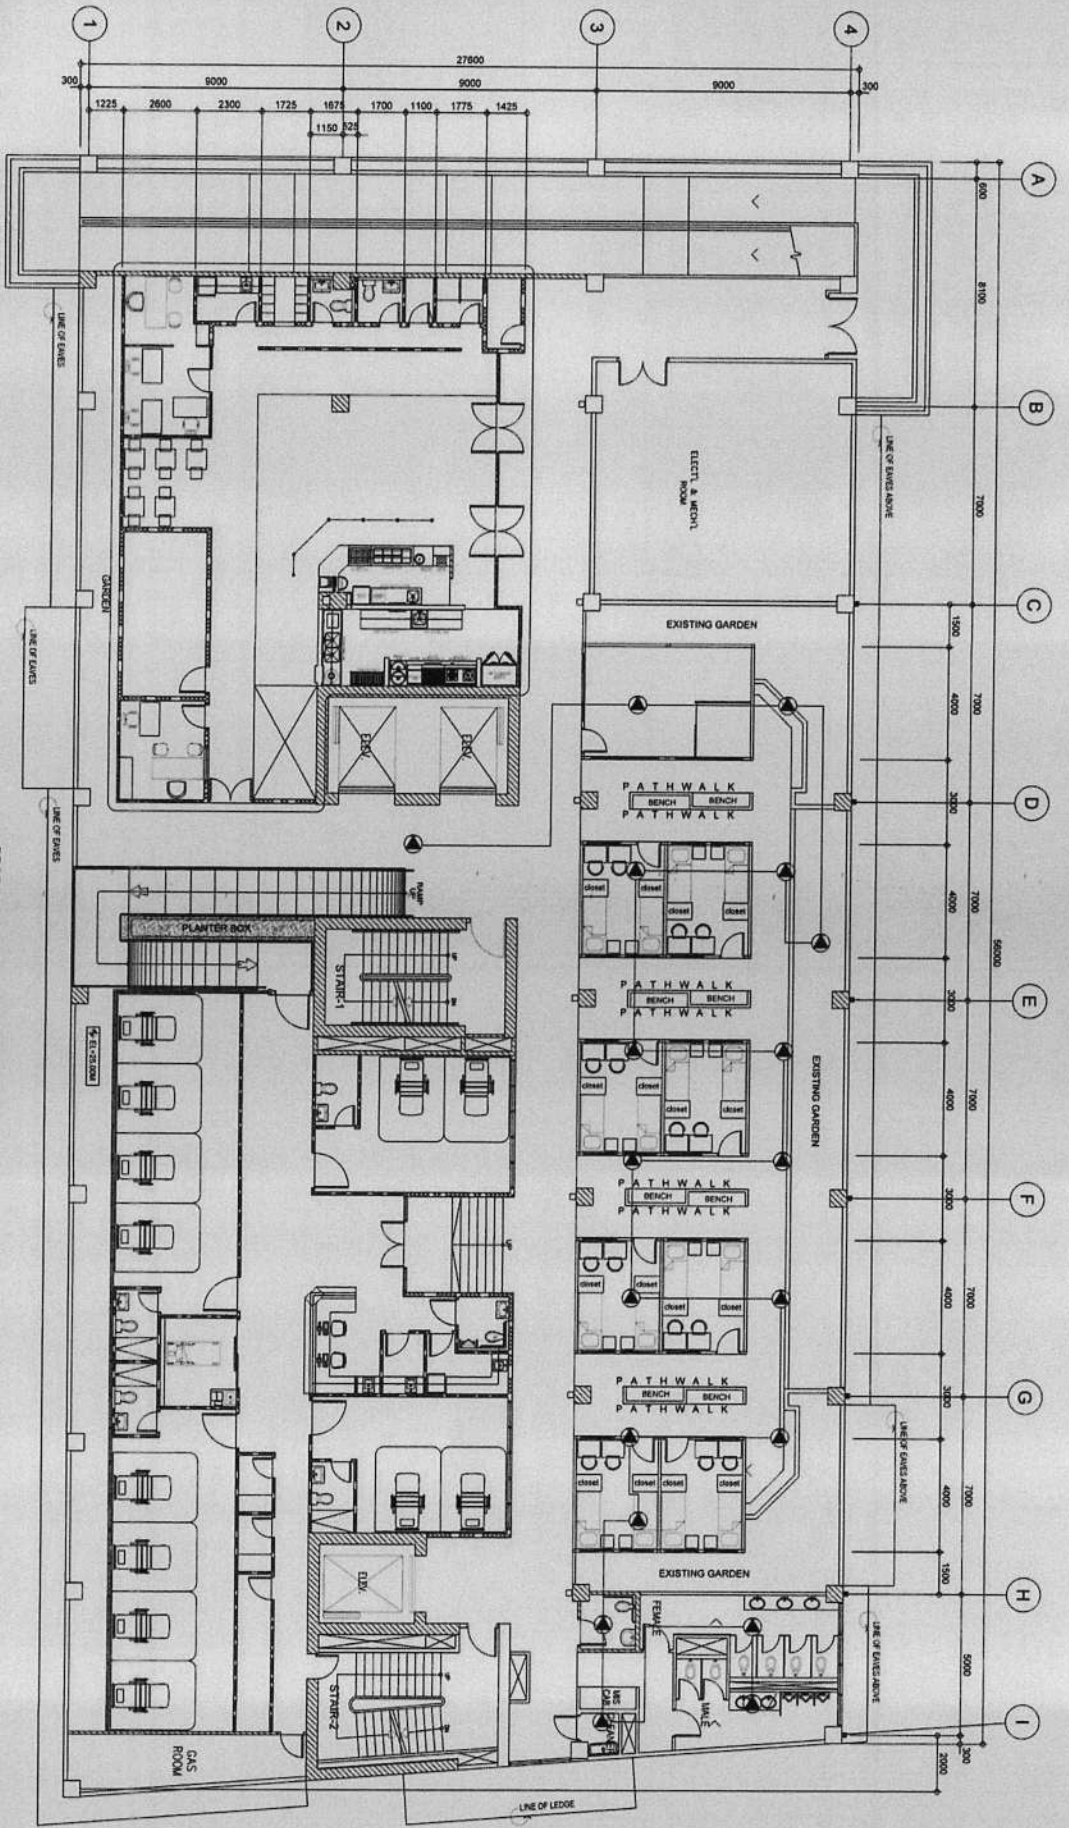


01
SCALE
1:100

PROPOSED LAYOUT FOR REPAIR WORKS
ROOF DECK BGM/PA SYSTEM LAYOUT

<p>REPUBLIC OF THE PHILIPPINES CITY OF PASIG</p>		<p>PROJECT TITLE</p> <p>PROPOSED EXPANSION W/ IMPROVEMENT WORKS AT PASIG CITY CHILDREN'S HOSPITAL</p>		<p>PROJECT IN CHARGE</p> <p>ENGR. CHRISTOPHER B. SOLONON ENGR. EDUARDO BARRERA JR. ENGR. JOHN CRISTINA T. CORTES</p>		<p>PROGRAMMING AND CONSTRUCTION</p> <p>ENGR. CARLA L. BELLIN ENGR. JORGE L. TIRON ENGR. JUAN CARLOS B. BARRERA JR.</p>		<p>RECOMMENDING APPROVAL</p> <p>ENGR. ALBERTO P. PRUDENCIO ENGR. ARTAVENES V. GERONIMO</p>		<p>APPROVED BY</p> <p>VICTOR MA. REGIS N. SOTTO CITY MAYOR</p>		<p>SHEET CONTENT</p> <p>PUBLIC ADDRESS SYSTEM WITH BACKGROUND LAYOUT</p>		<p>SHEET NO.</p> <p>AUX 65173</p>	
<p>CITY ENGINEERING OFFICE</p>		<p>LOCATION: INDUSTRIAL COR. ALCALDE JOSE E. Y. S. PASIG CITY</p>		<p>ENGR. EDUARDO BARRERA JR. ENGR. JOHN CRISTINA T. CORTES</p>		<p>ENGR. JUAN CARLOS B. BARRERA JR.</p>		<p>ENGR. ARTAVENES V. GERONIMO</p>		<p>CITY MAYOR</p>		<p>CONFORME & ACCEPTED BY: C O N T R A C T O R</p>			

IMPORTANT NOTES:

1. NO ALTERATION TO THE EXISTING STRUCTURE SHALL BE MADE WITHOUT THE WRITTEN APPROVAL OF THE ARCHITECT AND ENGINEER.
2. ALL MATERIALS AND WORKMANSHIP SHALL BE SUBJECT TO THE INSPECTION AND APPROVAL OF THE ARCHITECT AND ENGINEER.
3. NO WORK SHALL BE DONE ON THE ROOF DECK WITHOUT THE WRITTEN APPROVAL OF THE ARCHITECT AND ENGINEER.
4. ALL WORK SHALL BE DONE IN ACCORDANCE WITH THE SPECIFICATIONS AND DRAWINGS.
5. THE CONTRACTOR SHALL BE RESPONSIBLE FOR OBTAINING ALL NECESSARY PERMITS AND APPROVALS FROM THE RELEVANT AGENCIES.

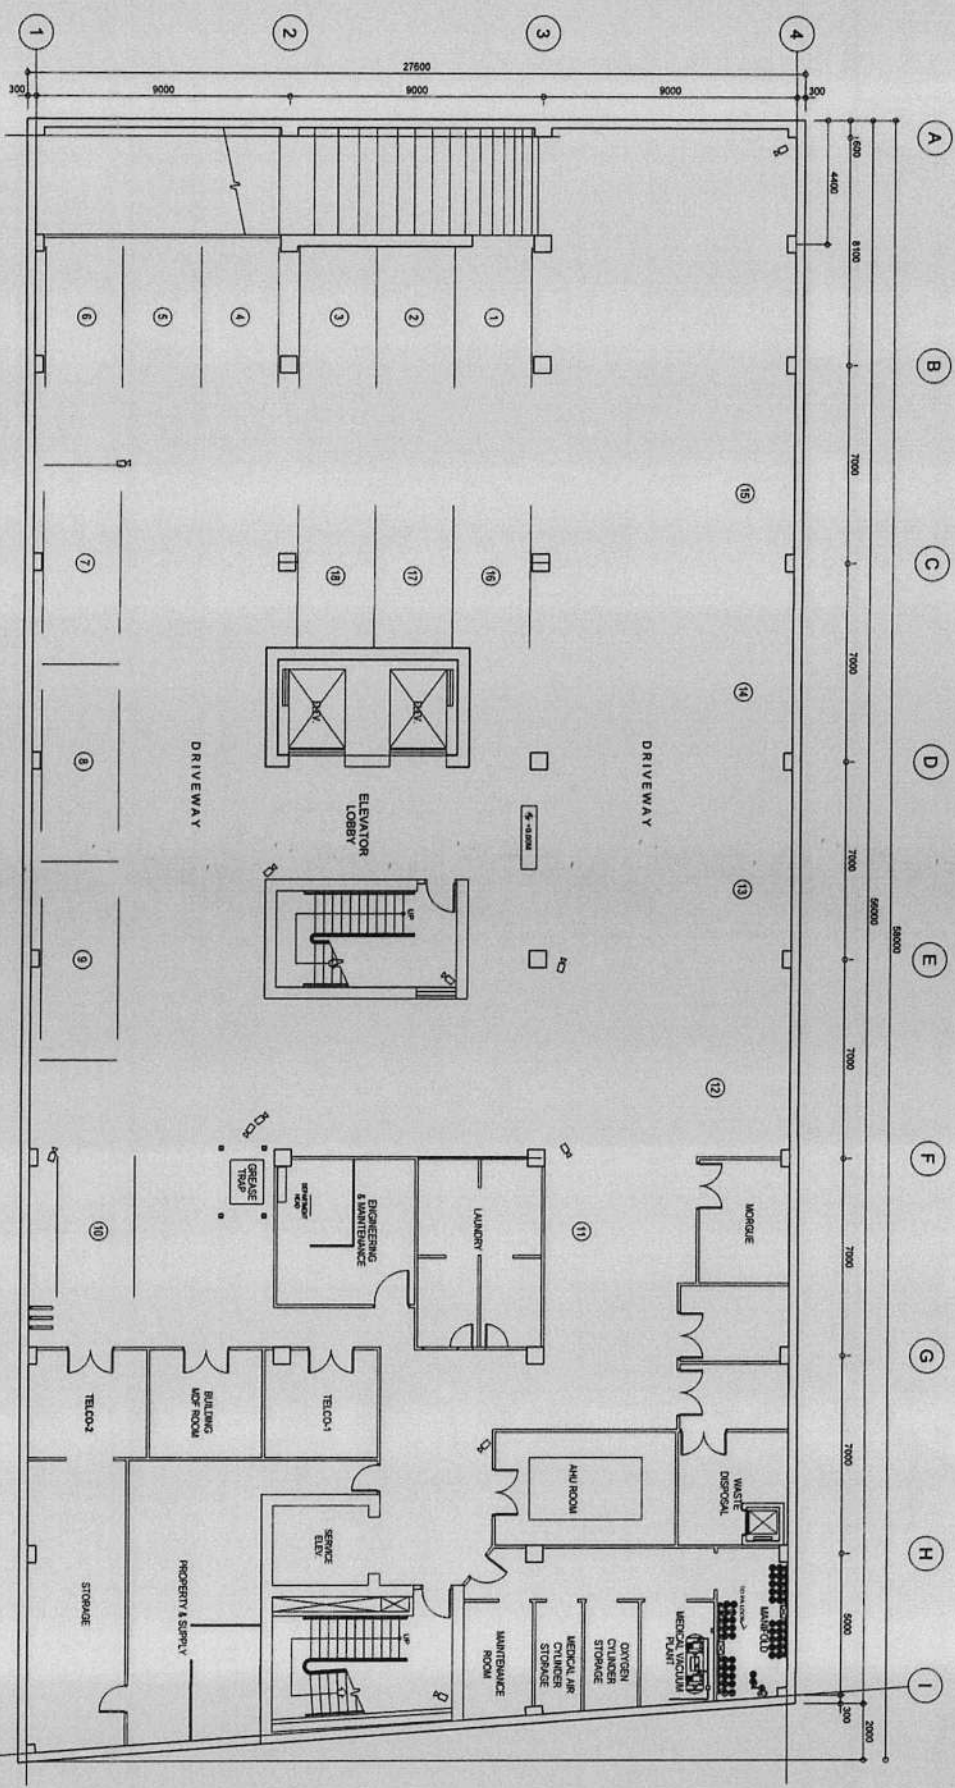

BASEMENT CCTV SYSTEM LAYOUT
 SCALE 1:100



REPUBLIC OF THE PHILIPPINES
 CITY OF PASIG
 OFFICE OF THE MAJOR
 CITY ENGINEERING OFFICE

PROJECT TITLE:
**PROPOSED EXPANSION W/
 IMPROVEMENT WORKS AT
 PASIG CITY CHILDREN'S HOSPITAL**

PROJECT IN CHARGE:
 ENGR. CHRISTOPHER C. SOLACION
 ENGR. EDUARDO C. GARCERA, JR.
 ENGR. JOHN JOSE T. CORTES

PROGRAMMING AND CONSTRUCTION:
 ENGR. CRISTINA BELIN
 ENGR. ORVILLE L. TIZON

RECOMMENDING APPROVAL:
 ENGR. LAWRENCE B. PRUDENCIO

ENGR. ARTAXERES V. GERONIMO

APPROVED BY:
 VICTOR M. REGIS N. SOTTO
 CITY MAJOR

SHEET CONTENT:
 CLOSED CIRCUIT
 TELEVISION (CCTV)

SHEET NO.:
**AUX
 6673**

WORKING NOTES:
 1. ALL ELECTRICAL WORK SHALL BE IN ACCORDANCE WITH THE NATIONAL ELECTRICAL CODE (NEC) AND THE NATIONAL WIRE AND CABLE CODE (NWC).
 2. ALL ELECTRICAL WORK SHALL BE IN ACCORDANCE WITH THE NATIONAL FIRE ALARM AND SIGNAL CODE (NFASC).
 3. THE OWNER SHALL BE RESPONSIBLE FOR THE PROVISION OF ALL NECESSARY SERVICES AND UTILITIES.
 4. ALL WORK SHALL BE SUBJECT TO THE APPROVAL OF THE CITY ENGINEERING OFFICE.
 5. THE CONTRACTOR SHALL BE RESPONSIBLE FOR THE PROVISION OF ALL NECESSARY MATERIALS AND LABOR.
 6. THE CONTRACTOR SHALL BE RESPONSIBLE FOR THE PROVISION OF ALL NECESSARY PERMITS AND APPROVALS.

CONTRACTOR



REPUBLIC OF THE PHILIPPINES
CITY OF PASIG
OFFICE OF THE MAYOR
CITY ENGINEERING OFFICE

PROJECT TITLE
**PROPOSED EXPANSION W/
IMPROVEMENT WORKS AT
PASIG CITY CHILDREN'S HOSPITAL**

PROJECT IN CHARGE
ENGR. CHRISTOPHER BENEDICT C. SOLACION
ENGR. EDUARDO G. BARRERA, JR.
ENGR. JOHN EDUARDO T. CORTES

PROGRAMMING AND CONSTRUCTION
ENGR. CERRIL BELLIN
ENGR. JOSE L. TIZON
OC. ELECTRIC & TELECOMMUNICATIONS SECTION

RECOMMENDING APPROVAL
ENGR. CRISTOPHER PURDONCINO
ENGR. ARTAHEROS V. GERONIMO
OC. CITY ENGINEERING OFFICE


APPROVED BY
VICTOR MA. REGIS N. SOTTO
CITY MAYOR

SHEET CONTENT
CLOSED CIRCUIT TELEVISION (CCTV) LAYOUT


SHEET NO.
AUX
6773

CONFORME & ACCEPTED BY
CONTRACTOR

IMPORTANT NOTES
1. INSTALLATION AND OPERATION SHALL BE IN ACCORDANCE WITH THE CITY ENGINEERING OFFICE'S STANDARDS AND SPECIFICATIONS.
2. THE CONTRACTOR SHALL BE RESPONSIBLE FOR THE PROTECTION OF ALL EXISTING UTILITIES AND STRUCTURES.
3. THE CONTRACTOR SHALL BE RESPONSIBLE FOR THE PROTECTION OF ALL EXISTING UTILITIES AND STRUCTURES.
4. TO BE COMPLETED AND APPROVED BY THE CITY ENGINEERING OFFICE.
5. TO BE COMPLETED AND APPROVED BY THE CITY ENGINEERING OFFICE.
6. TO BE COMPLETED AND APPROVED BY THE CITY ENGINEERING OFFICE.

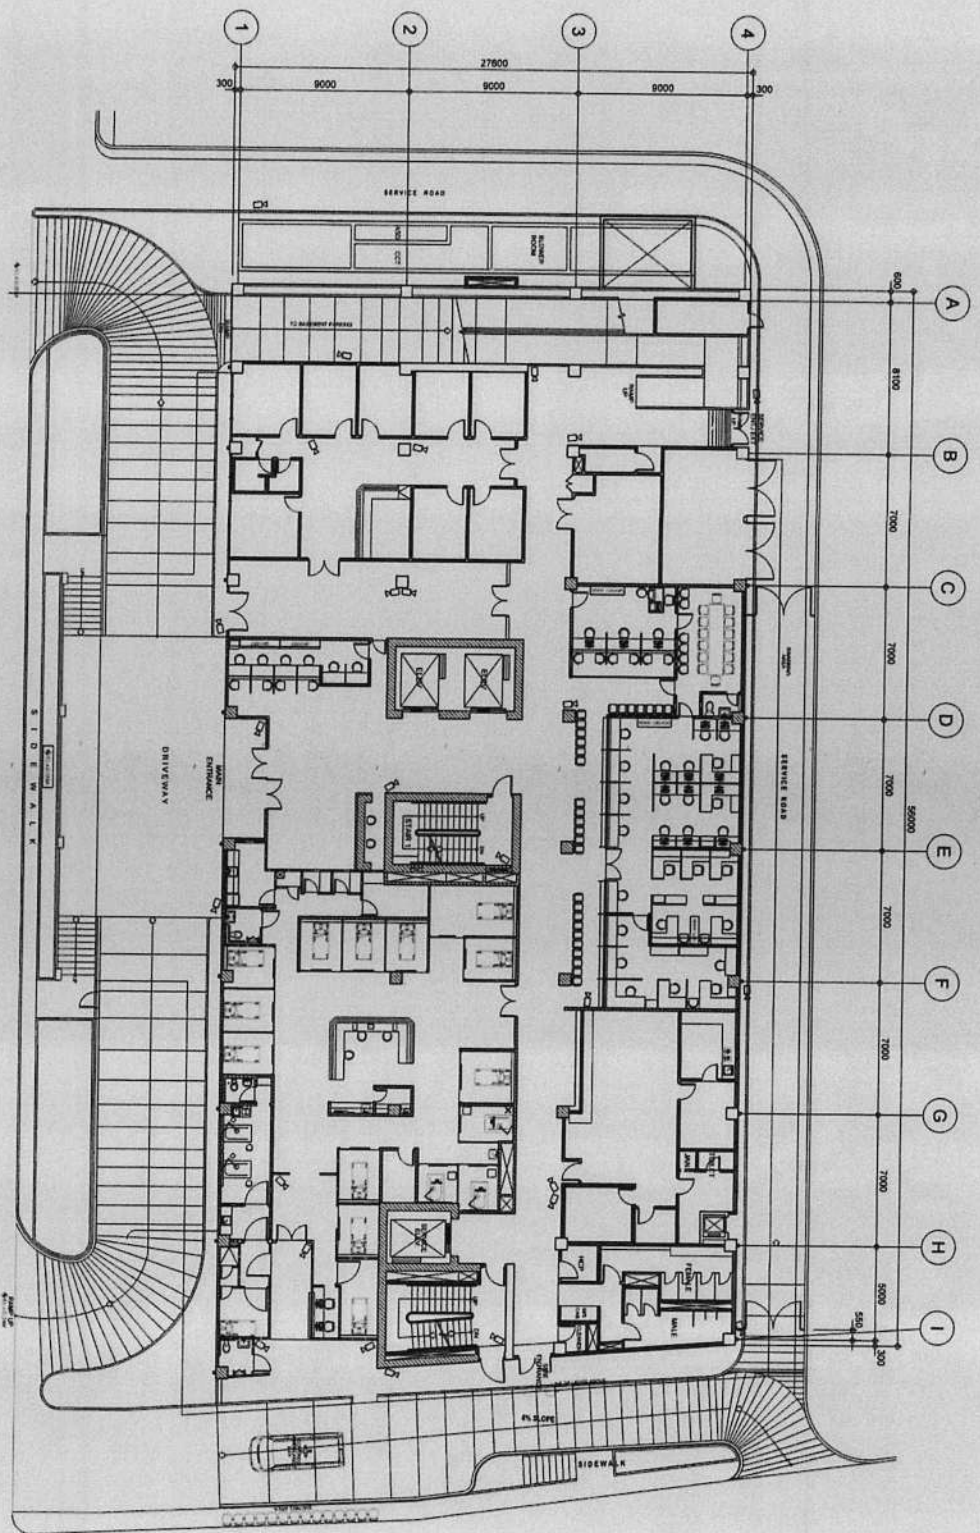


GROUND CCTV SYSTEM LAYOUT
SCALE 1:300 NAL

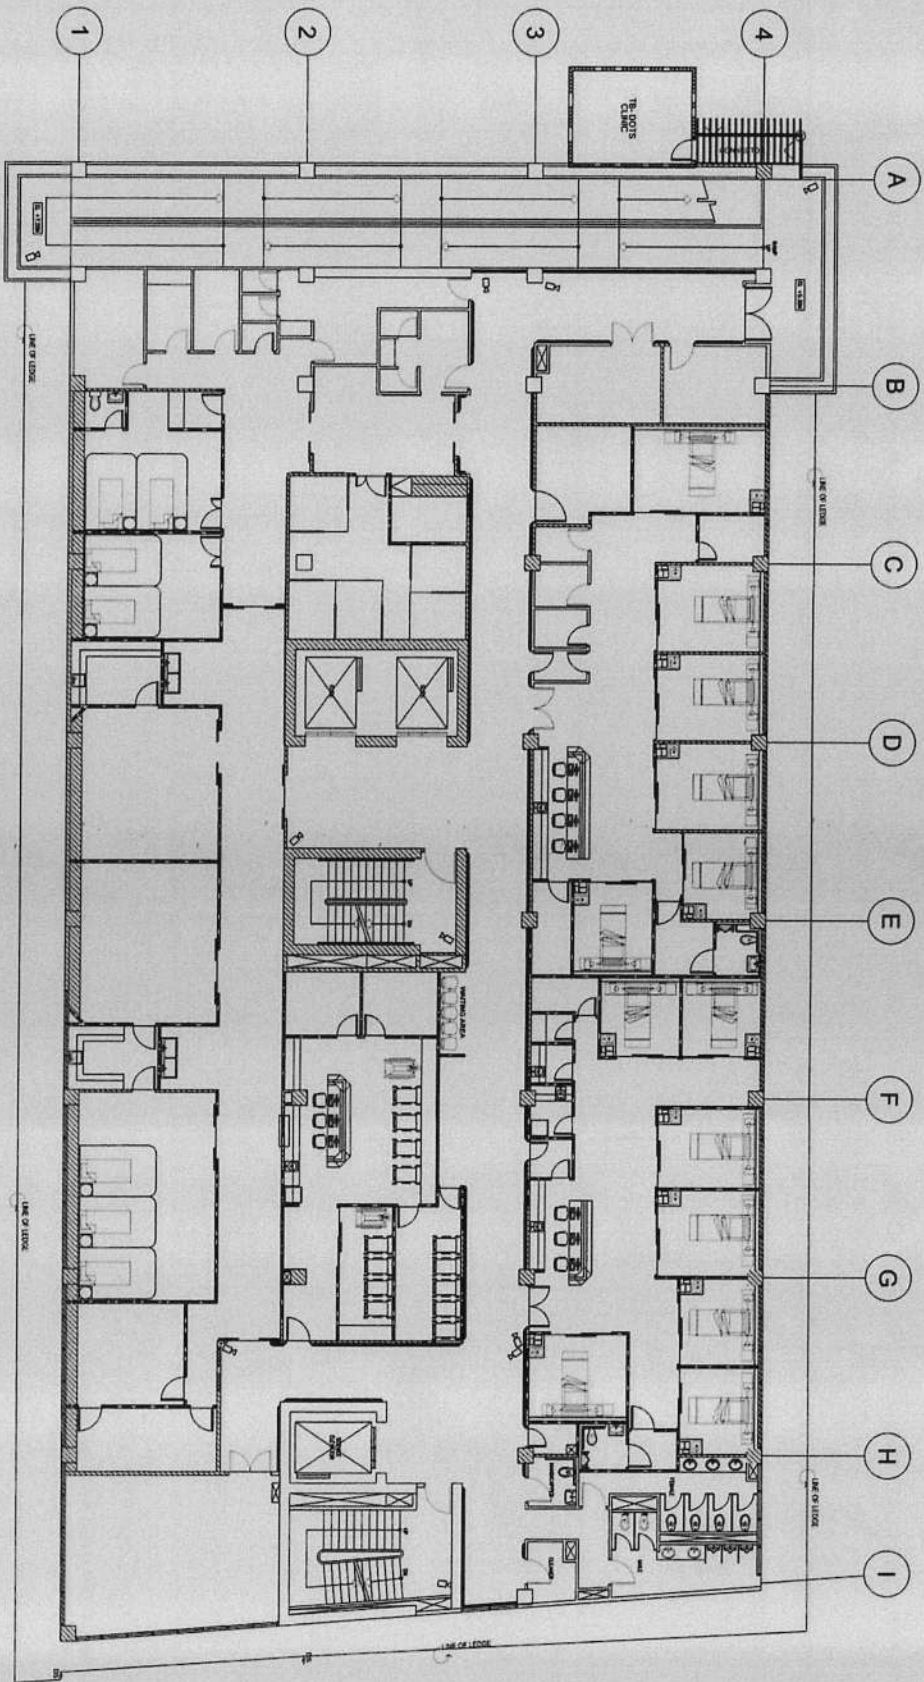


00 SECOND FLOOR CCTV SYSTEM LAYOUT
 SCALE 1:100 M.M.

	REPUBLIC OF THE PHILIPPINES CITY OF PASIG OFFICE OF THE MAJOR CITY ENGINEERING OFFICE	PROJECT TITLE: PROPOSED EXPANSION W/ IMPROVEMENT WORKS AT PASIG CITY CHILDRENS HOSPITAL	PROJECT IN CHARGE: ENGR. <i>CHERRYANNE EMBENIC C. SOLMON</i> ENGR. EDUARDO G. OMBRUNA, JR. ENGR. JOHN A. CORTES	PROGRAMMING AND CONSTRUCTION: ENGR. CARVAL BELAN ENGR. JORGE L. TIZON	RECOMMENDING APPROVAL: ENGR. <i>FRANCISCO TRUJENDICO</i> ENGR. ARTAVERNES V. GERONIMO	APPROVED BY: VICTOR M. REGIS N. SOTTO CITY MAJOR	SHEET CONTENT: CLOSED CIRCUIT TELEVISION (CCTV) LAYOUT	SHEET NO.:
	IMPORTANT NOTES: 1. NO ALTERATION IN SCALE & UNIT SHALL BE MADE WITHOUT THE PRIOR APPROVAL OF THE ARCHITECT AND ENGINEER. 2. CONTRACTOR SHALL BE RESPONSIBLE FOR THE PROVISION OF ALL NECESSARY MATERIALS AND LABORERS. 3. TO BE CONSIDERED AS PART OF THE CONTRACT DOCUMENTS. 4. CONTRACTOR SHALL PROVIDE ONE SET OF ALL DRAWINGS TO THE ARCHITECT & ENGINEER.	LOCATION: INDUSTRIAL COR. ALCAJIDE JOSE STS. PASIG CITY, METRO MANILA	CONTRACTOR: CONFORME & ACCEPTED BY: CONTRACTOR					

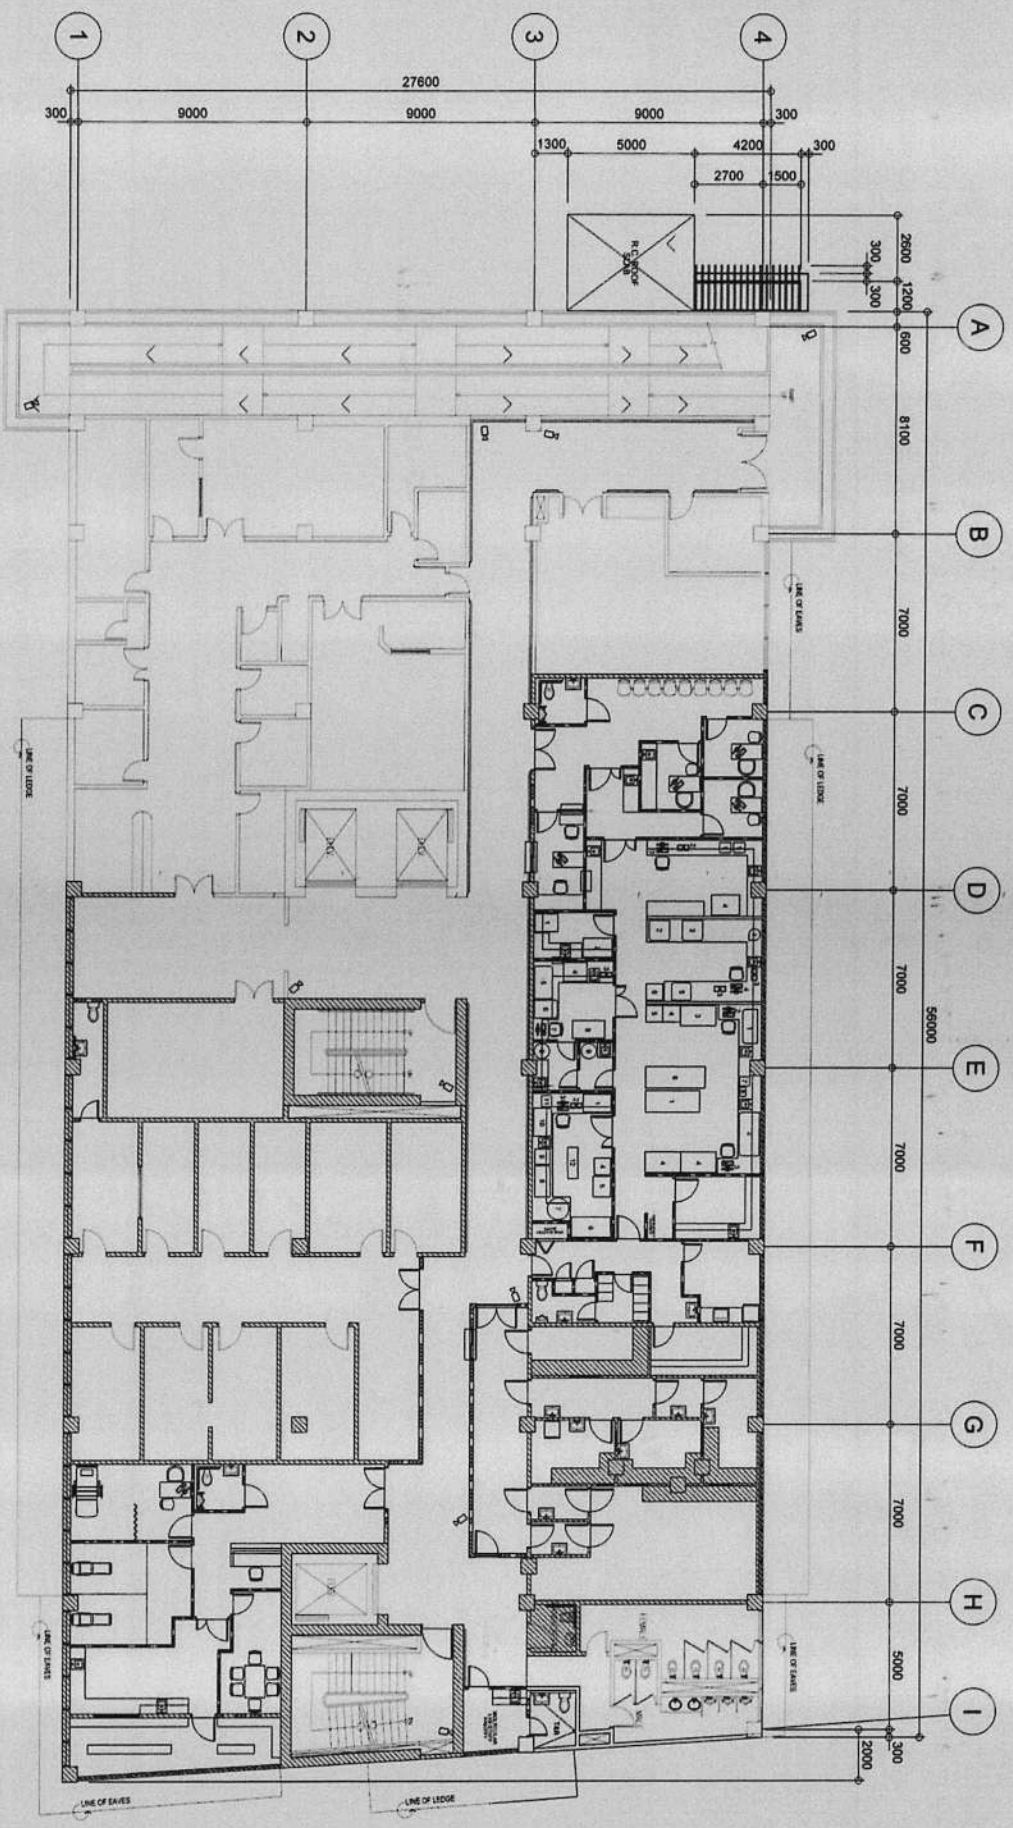


00
A 00 / SCALE
1 : 100 MM
THIRD FLOOR CCTV SYSTEM LAYOUT


 REPUBLIC OF THE PHILIPPINES CITY OF PASIG OFFICE OF THE MAYOR CITY ENGINEERING OFFICE	PROJECT TITLE	PROJECT IN CHARGE		PROGRAMMING AND CONSTRUCTION	RECOMMENDING APPROVAL	APPROVED BY	SHEET CONTENT	SHEET NO.
	PROPOSED EXPANSION W/ IMPROVEMENT WORKS AT PASIG CITY CHILDREN'S HOSPITAL LOCATION: MODERNA COR. ALCADRE JOSE STS. KANSONAN, PASIG CITY	ENGR. CHRISTOPHER B. SOLONON ENGR. EDUARDO S. BARRONIA JR. ENGR. JOHN DOMINIC T. CORTES	ENGR. CAROL BELLIN ENGR. ROSE L. TIZON	ENGR. JUAN P. SPUYENCIO ENGR. ARTAVENDES V. GERONIMO	VICTOR M. NEGIS N. SOTTO CITY MANOR	CLOSED CIRCUIT TELEVISION (CCTV) LAYOUT	AUX 69173	CONFORMANCE & ACCEPTED BY: CONTRACTOR

IMPORTANT NOTES

1. NO PART OF THIS DRAWING IS TO BE REPRODUCED OR TRANSMITTED IN ANY FORM OR BY ANY MEANS, ELECTRONIC OR MECHANICAL, INCLUDING PHOTOCOPYING, RECORDING, OR BY ANY INFORMATION STORAGE AND RETRIEVAL SYSTEM, WITHOUT THE WRITTEN PERMISSION OF THE CITY ENGINEERING OFFICE.
2. THE CONTRACTOR SHALL BE RESPONSIBLE FOR THE PROTECTION OF ALL EXISTING UTILITIES AND STRUCTURES TO REMAIN. ANY DAMAGE TO SUCH UTILITIES OR STRUCTURES SHALL BE REPAIRED AT THE CONTRACTOR'S EXPENSE.
3. IN CASE OF DISCREPANCY IN THE DRAWINGS, THE LATTER SHALL BE SUBMITTED IMMEDIATELY TO THE ARCHITECT FOR REVIEW AND APPROVAL. THE CONTRACTOR SHALL BE RESPONSIBLE FOR THE PROTECTION OF ALL EXISTING UTILITIES AND STRUCTURES TO REMAIN. ANY DAMAGE TO SUCH UTILITIES OR STRUCTURES SHALL BE REPAIRED AT THE CONTRACTOR'S EXPENSE.
4. THE CONTRACTOR SHALL BE RESPONSIBLE FOR THE PROTECTION OF ALL EXISTING UTILITIES AND STRUCTURES TO REMAIN. ANY DAMAGE TO SUCH UTILITIES OR STRUCTURES SHALL BE REPAIRED AT THE CONTRACTOR'S EXPENSE.

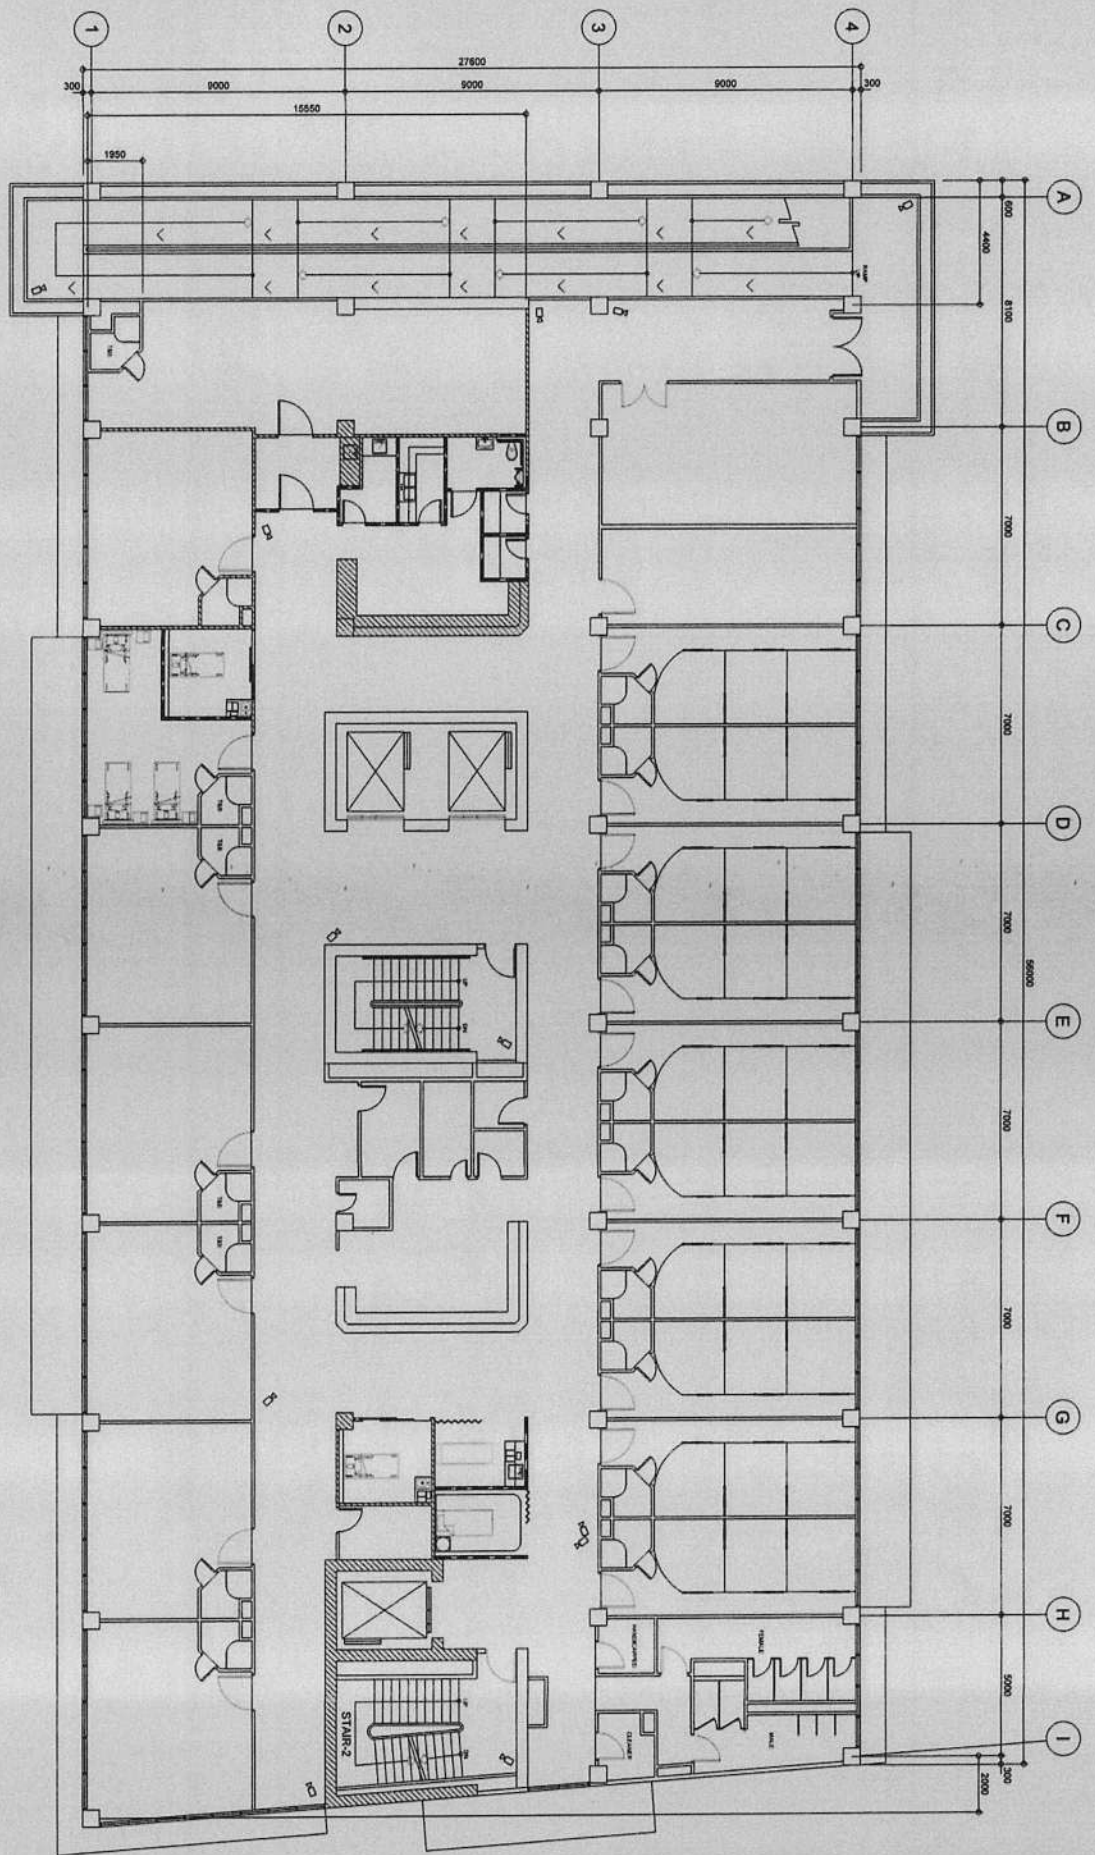


00
A 100 / SCALE
FOURTH FLOOR CCTV SYSTEM LAYOUT
1 : 100 MM

 REPUBLIC OF THE PHILIPPINES CITY OF PASIG OFFICE OF THE MAYOR CITY ENGINEERING OFFICE	PROJECT TITLE PROPOSED EXPANSION W/ IMPROVEMENT WORKS AT PASIG CITY CHILDREN'S HOSPITAL	PROJECT IN CHARGE ENGR. CHERRY BENEDECT C. SOLONON ENGR. EDUARDO BARBUERA JR.	PROGRAMMING AND CONSTRUCTION ENGR. JOSE L. TIZON ENGR. JOHN T. CORTEZ	RECOMMENDING APPROVAL: ENGR. FRANCISCO B. PRUDENCIO ENGR. ARTABERRES V. GERONIMO	APPROVED BY VICTOR MA. REGIS N. SOTTO CITY ENGINEER	SHEET CONTENT: CLOSED CIRCUIT TELEVISION (CCTV) LAYOUT	SHEET NO. AUX 70173
	LOCATION: INDUSTRIAL COR. ALONSO JOSE BIDS.	PROJECT IN CHARGE ENGR. JOHN T. CORTEZ ENGR. JOHN T. CORTEZ	RECOMMENDING APPROVAL: ENGR. FRANCISCO B. PRUDENCIO ENGR. ARTABERRES V. GERONIMO	APPROVED BY VICTOR MA. REGIS N. SOTTO CITY ENGINEER	SHEET CONTENT: CLOSED CIRCUIT TELEVISION (CCTV) LAYOUT	SHEET NO. AUX 70173	

IMPORTANT NOTES:

- NO ALTERATION IN PLANS & SPECIFICATIONS SHALL BE MADE WITHOUT THE APPROVAL OF THE ARCHITECT AND THE CITY ENGINEER.
- IN ANY CASE, THE CONTRACTOR SHALL BE RESPONSIBLE FOR THE PROTECTION OF THE EXISTING UTILITIES AND STRUCTURES. ANY DAMAGE TO THE EXISTING UTILITIES AND STRUCTURES SHALL BE REPAIRS AT THE CONTRACTOR'S EXPENSE.
- IN CASE OF DISCREPANCY IN THE DRAWINGS, THE LATTER SHALL BE DEEMED TO PREVAIL OVER THE FORMER.
- CONSTRUCTION OF THIS PROJECT SHALL BE COMPLETED AT THE EXPENSE OF THE CONTRACTOR.

CONTRACTOR

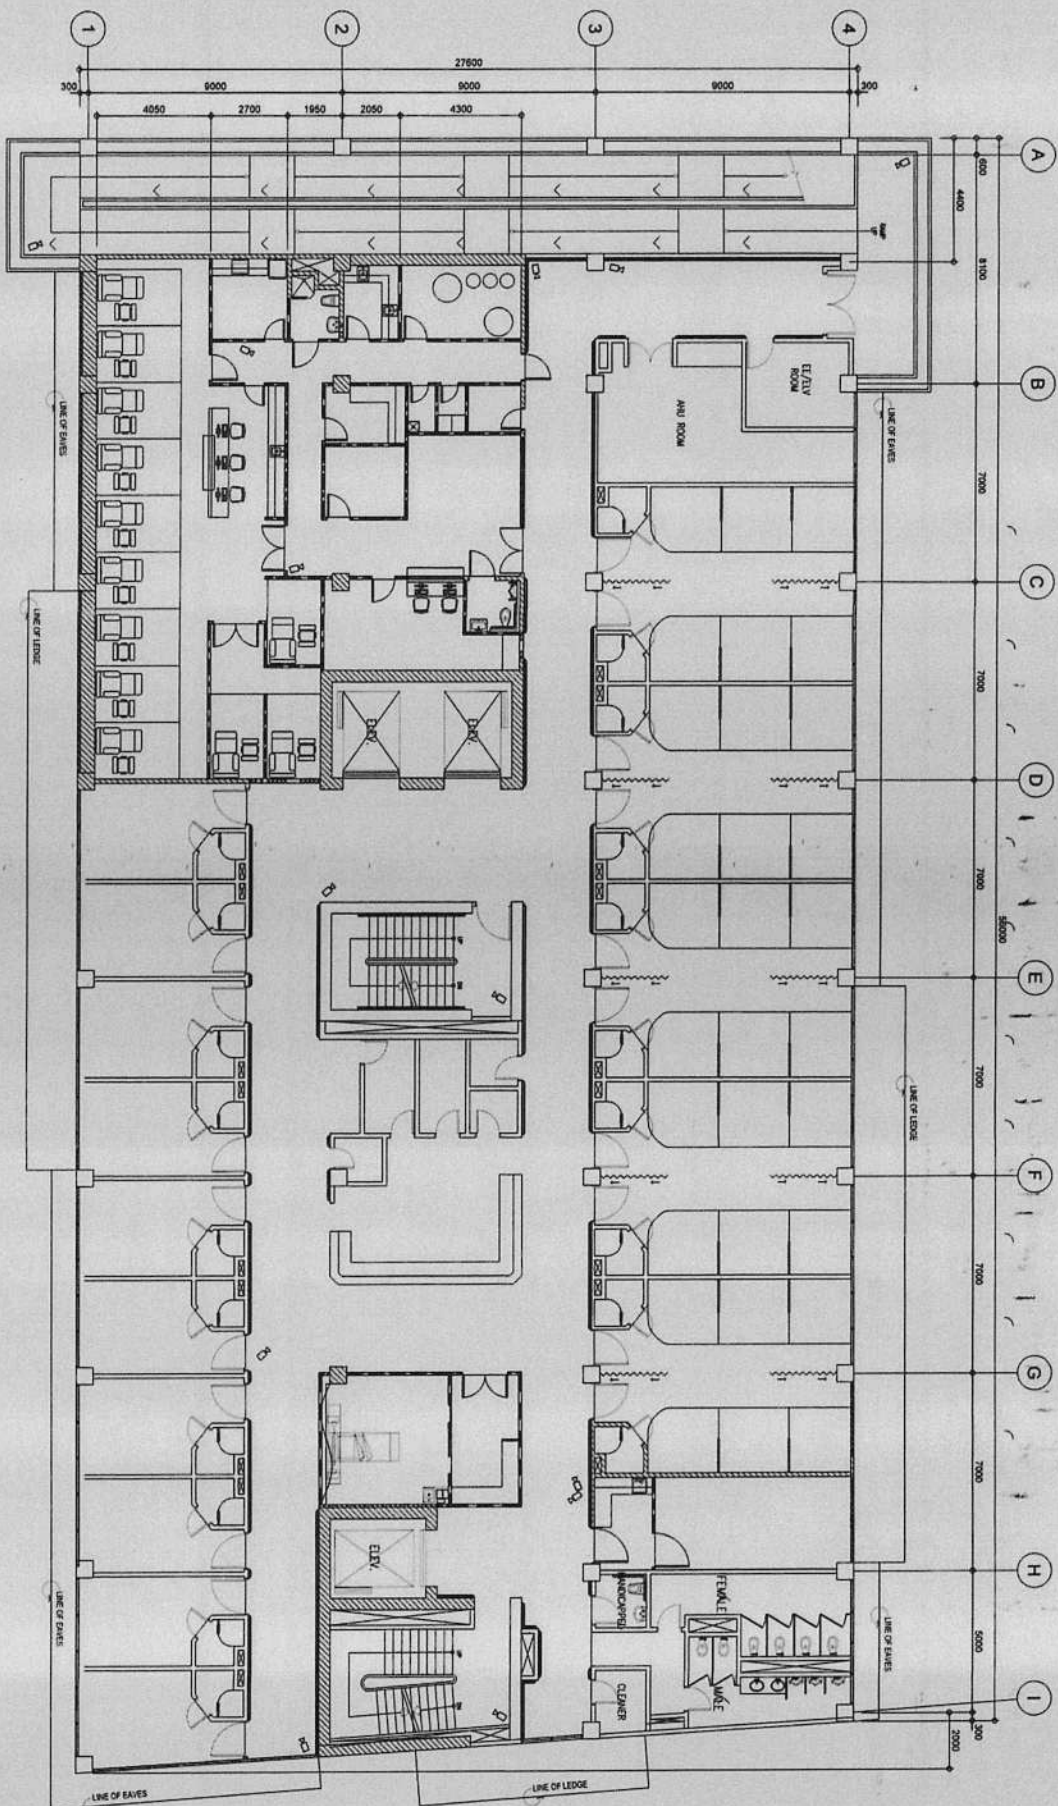

00
100
FIFTH FLOOR CCTV SYSTEM LAYOUT



REPUBLIC OF THE PHILIPPINES
CITY OF PASIG
OFFICE OF THE MAYOR
CITY ENGINEERING OFFICE

PROJECT TITLE
**PROPOSED EXPANSION W/
IMPROVEMENT WORKS AT
PASIG CITY CHILDREN'S HOSPITAL**

PROJECT IN CHARGE
ENGR. **CHRISTOPHER BENEDICT C. SOLONON**
ENGR. **EDUARDO T. BARBERA, JR.**

PROGRAMMING AND CONSTRUCTION
ENGR. **JOSE L. TISON**

RECOMMENDING APPROVAL
ENGR. **ANTHONY B. FRUENDENCO**


APPROVED BY
ENGR. **ARTAVERDES V. GERONIMO**

APPROVED BY
VICTOR **MA. REGIS N. SOTTO**
CITY MAYOR

SHEET CONTENT:
SHEET NO.:
AUX
7173

IMPORTANT NOTES:
1. NO ALTERATION IN SCALE & ORIENTATION SHALL BE MADE.
2. IN ANY CASE, THE CONTRACTOR SHALL BE RESPONSIBLE FOR THE VERIFICATION OF THE EXISTING CONDITIONS OF THE SUBJECT AND THE DIMENSIONS OF THE STRUCTURE.
3. TO THE EXTENT OF THE CONTRACT, THE CONTRACTOR SHALL BE RESPONSIBLE FOR THE VERIFICATION OF THE EXISTING CONDITIONS OF THE SUBJECT AND THE DIMENSIONS OF THE STRUCTURE.
4. THE CONTRACTOR SHALL BE RESPONSIBLE FOR THE VERIFICATION OF THE EXISTING CONDITIONS OF THE SUBJECT AND THE DIMENSIONS OF THE STRUCTURE.

CONFORMABLE & ACCEPTED BY:
C O N T R A C T O R

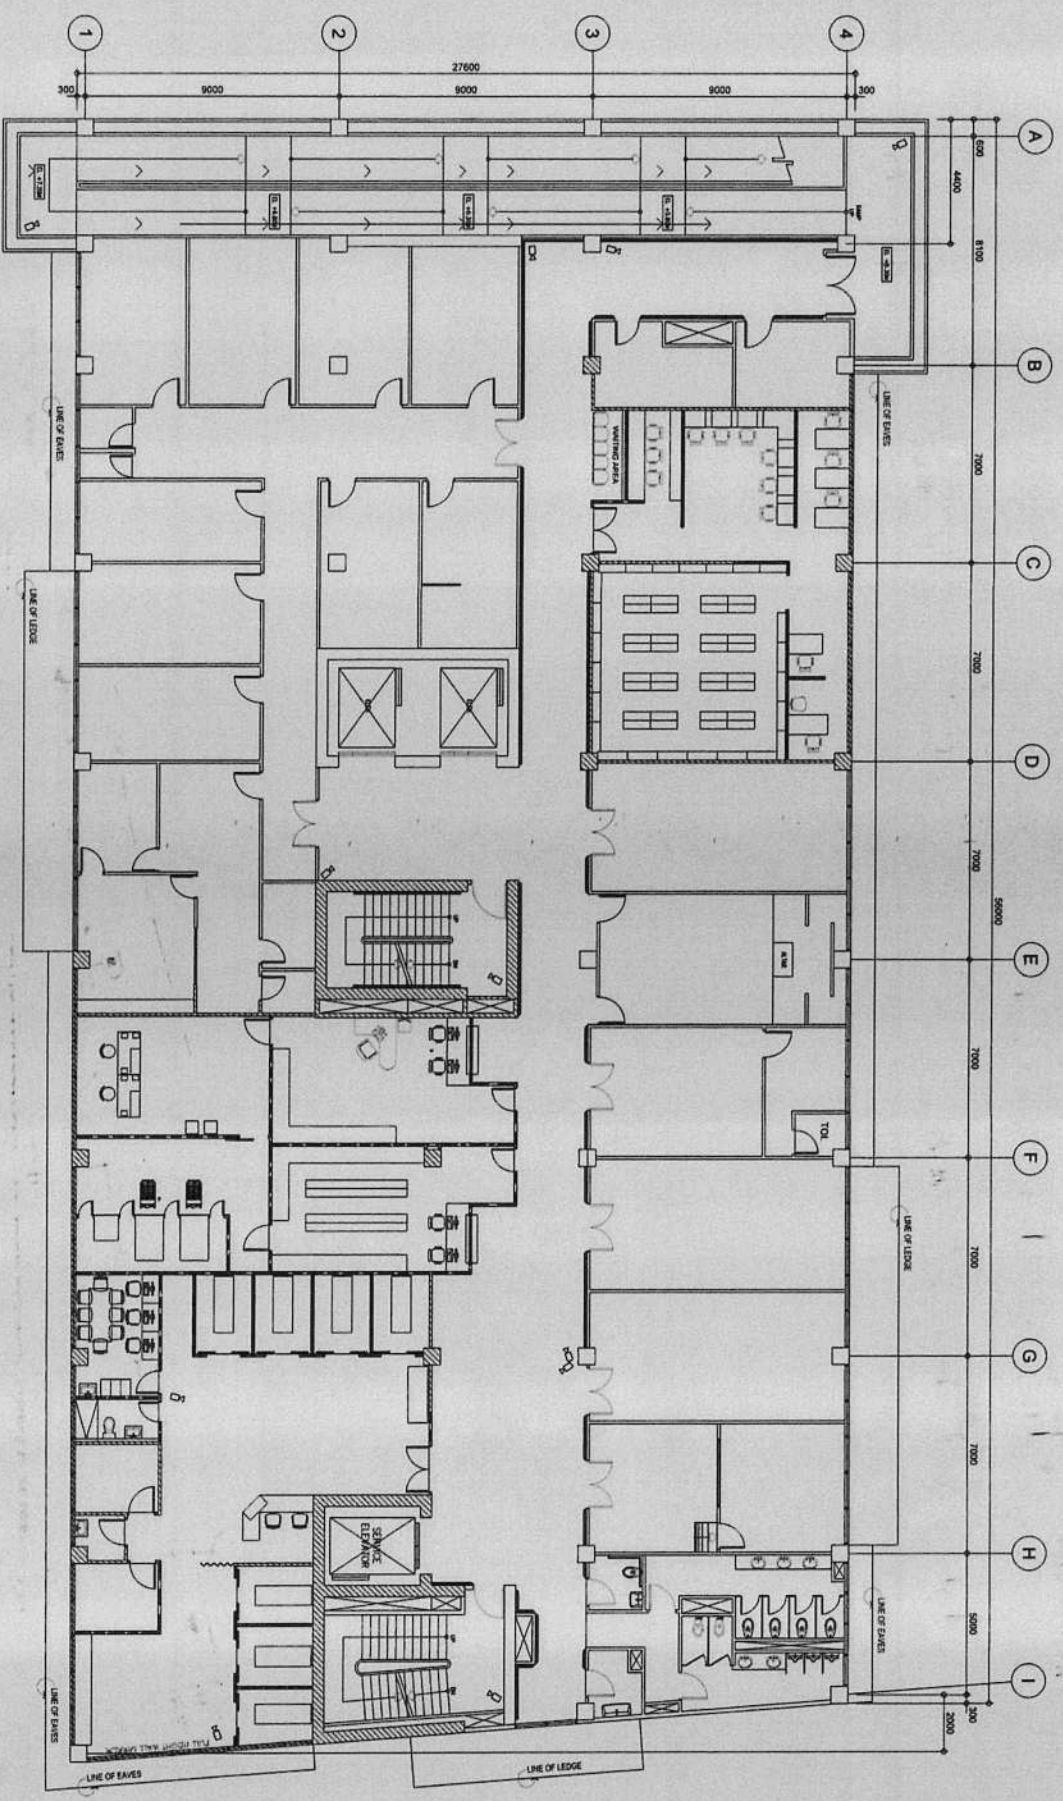

SIXTH FLOOR CCTV SYSTEM LAYOUT
 1/100 SCALE

1:100 IMA



REPUBLIC OF THE PHILIPPINES
 CITY OF PASIG
 OFFICE OF THE MAYOR
 CITY ENGINEERING OFFICE

PROJECT TITLE:
**PROPOSED EXPANSION W/
 IMPROVEMENT WORKS AT
 PASIG CITY CHILDREN'S HOSPITAL**

PROJECT IN CHARGE:
 ENGR. CHRISTOPHER S. SOLICON
 ENGR. EDUARDO S. BARRERA, JR.
 ENGR. JOHN M. BELIN


PROGRAMMING AND CONSTRUCTION:
 ENGR. JESSE L. TIZON
 ENGR. JOHN M. BELIN

RECOMMENDING APPROVAL:
 ENGR. CONRADO B. FRUENDENCO

APPROVED BY:
 ENGR. ARYANERIS V. GERONIMO


SHEET NO.:
 72/73

SHEET CONTENT:
 CLOSED CIRCUIT TELEVISION (CCTV) LAYOUT

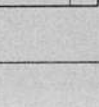

CONTRACTOR:
 CONFORMED & ACCEPTED BY:

1. CONTRACTOR SHALL BE RESPONSIBLE FOR THE PROTECTION OF ALL EXISTING UTILITIES AND STRUCTURES TO REMAIN.
2. CONTRACTOR SHALL BE RESPONSIBLE FOR THE PROTECTION OF ALL EXISTING UTILITIES AND STRUCTURES TO REMAIN.
3. THE CONTRACTOR SHALL BE RESPONSIBLE FOR THE PROTECTION OF ALL EXISTING UTILITIES AND STRUCTURES TO REMAIN.
4. CONTRACTOR SHALL BE RESPONSIBLE FOR THE PROTECTION OF ALL EXISTING UTILITIES AND STRUCTURES TO REMAIN.
5. CONTRACTOR SHALL BE RESPONSIBLE FOR THE PROTECTION OF ALL EXISTING UTILITIES AND STRUCTURES TO REMAIN.

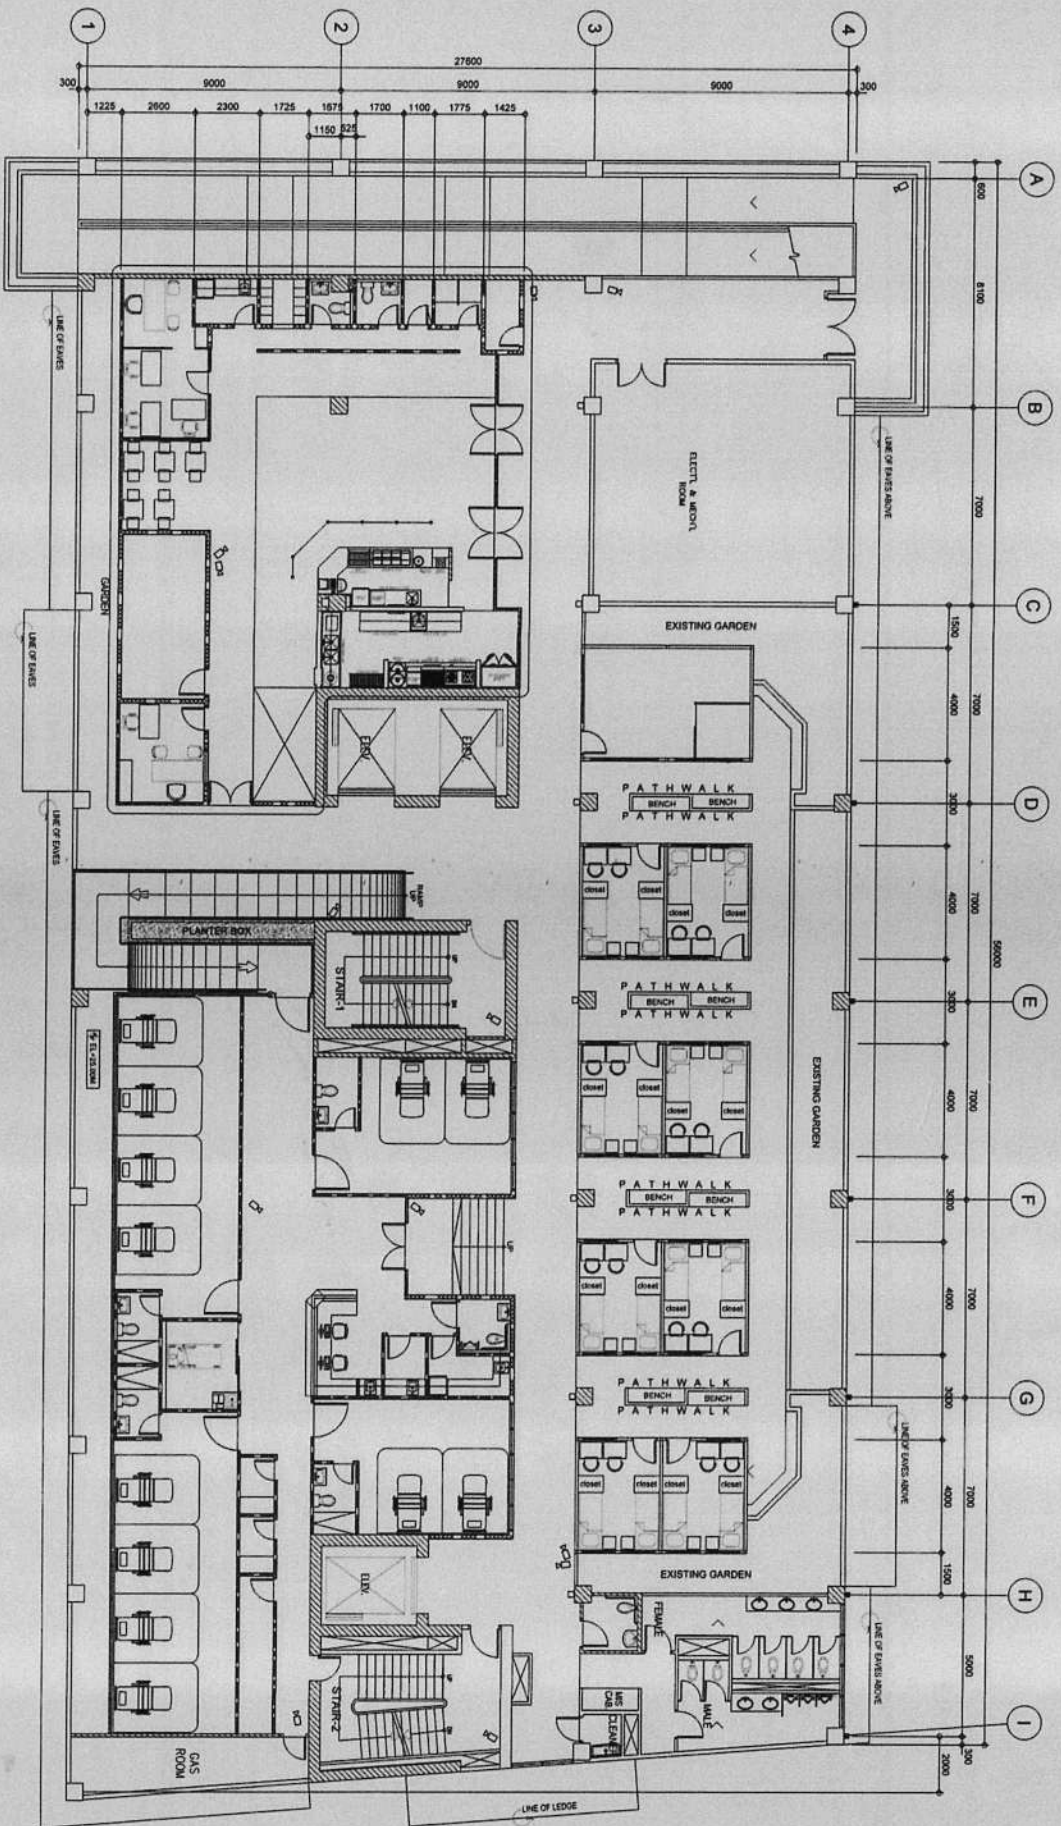

ROOF DECK CCTV SYSTEM LAYOUT
 SCALE 1:100
 1:100 MM

		REPUBLIC OF THE PHILIPPINES CITY OF PASIG OFFICE OF THE MAJOR CITY ENGINEERING OFFICE	
PROJECT TITLE: PROPOSED EXPANSION W/ LINDA TORRES HOSPITAL PASIG CITY CHILDREN'S HOSPITAL		PROJECT IN CHARGE: ENGR. CHRISTOPHER S. SOLOMON ENGR. EDUARDO C. BARRERA, JR.	
LOCATION: INDUSTRIAL COR. ALTAJUE JOSE STE. LAMPANGAN, PASIG CITY		ENGR. CRISTOPHER S. SOLOMON ENGR. JOHN ABEL T. CORTES	
PROGRAMMING AND CONSTRUCTION: ENGR. JOHN ABEL T. CORTES		RECOMMENDING APPROVAL: ENGR. CRISTOPHER S. SOLOMON ENGR. JOHN ABEL T. CORTES	
APPROVED BY: VICTOR WA. REGIS N. SOTTO CITY MAJOR		SHEET NO.: AUX 7373	
SHEET CONTENT: CLOSED CIRCUIT TELEVISION (CCTV) LAYOUT		CONFIRMED & ACCEPTED BY: C O N T R A C T O R	


1. NO PART OF THIS PROJECT SHALL BE REPRODUCED OR TRANSMITTED IN ANY FORM OR BY ANY MEANS, ELECTRONIC OR MECHANICAL, INCLUDING PHOTOCOPYING, RECORDING, OR BY ANY INFORMATION STORAGE AND RETRIEVAL SYSTEM, WITHOUT PERMISSION IN WRITING FROM THE ARCHITECT.

2. NO PART OF THIS PROJECT SHALL BE REPRODUCED OR TRANSMITTED IN ANY FORM OR BY ANY MEANS, ELECTRONIC OR MECHANICAL, INCLUDING PHOTOCOPYING, RECORDING, OR BY ANY INFORMATION STORAGE AND RETRIEVAL SYSTEM, WITHOUT PERMISSION IN WRITING FROM THE ARCHITECT.


3. NO PART OF THIS PROJECT SHALL BE REPRODUCED OR TRANSMITTED IN ANY FORM OR BY ANY MEANS, ELECTRONIC OR MECHANICAL, INCLUDING PHOTOCOPYING, RECORDING, OR BY ANY INFORMATION STORAGE AND RETRIEVAL SYSTEM, WITHOUT PERMISSION IN WRITING FROM THE ARCHITECT.

4. NO PART OF THIS PROJECT SHALL BE REPRODUCED OR TRANSMITTED IN ANY FORM OR BY ANY MEANS, ELECTRONIC OR MECHANICAL, INCLUDING PHOTOCOPYING, RECORDING, OR BY ANY INFORMATION STORAGE AND RETRIEVAL SYSTEM, WITHOUT PERMISSION IN WRITING FROM THE ARCHITECT.

VICINITY MAP

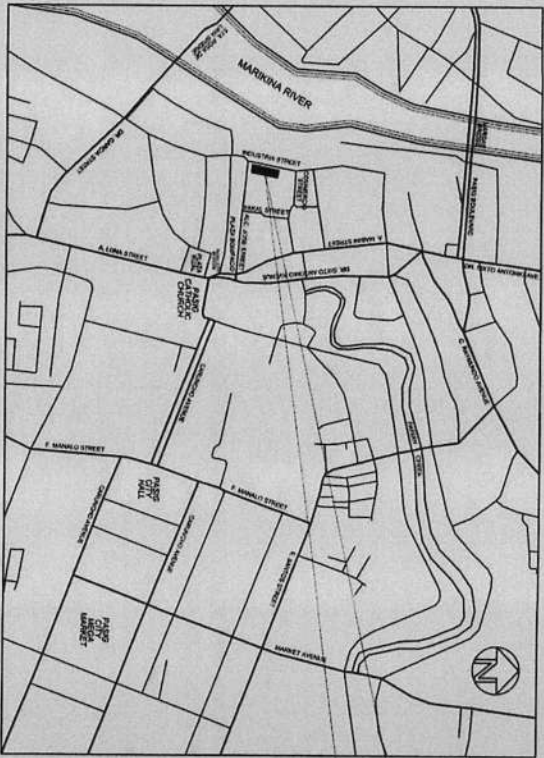

THE SITE

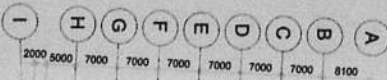


01 SITE DEVELOPMENT PLAN
SCALE 1:2000 IMA

	REPUBLIC OF THE PHILIPPINES CITY OF PASIG OFFICE OF THE MAJOR ENGINEERING OFFICE	PROJECT TITLE: PROPOSED EXPANSION WITH IMPROVEMENT WORKS AT PASIG CITY CHILDREN'S HOSPITAL	PROJECT IN CHARGE: VINCENZO WILLAMOR RAMP ALBERT A. MARTIN RAMP	PROGRAMMING & CONSTRUCTION: ENGR. ERIC V. RANESSES ENGR. JUAN MANUEL I. PEREZ	RECOMMENDING APPROVAL: ENGR. ANTONIO B. PRUDENCIO ENGR. ARTAYANES V. GERONIMO	APPROVED BY: VICTOR M.A. REGIS N. SOTTO, CITY MAJOR	SHEET CONTENTS: SITE DEVELOPMENT PLAN	SHEET NO.: P 01
--	--	--	---	---	---	--	--	--------------------


IMPORTANT NOTES:
 1. NO ALTERATION SHALL BE MADE TO THE ORIGINAL DESIGN.
 2. IF ANY CHANGE IS REQUIRED, THE CONTRACTOR SHALL SUBMIT A REQUEST FOR CHANGE ORDER TO THE ENGINEER.
 3. IN CASE OF CONFLICT, THE INSTRUCTIONS SHALL BE FOLLOWED.
 4. ANY VIOLATION OF THE INSTRUCTION SHALL BE CONSIDERED AT THE RISK OF THE CONTRACTOR.

CONTRACTOR

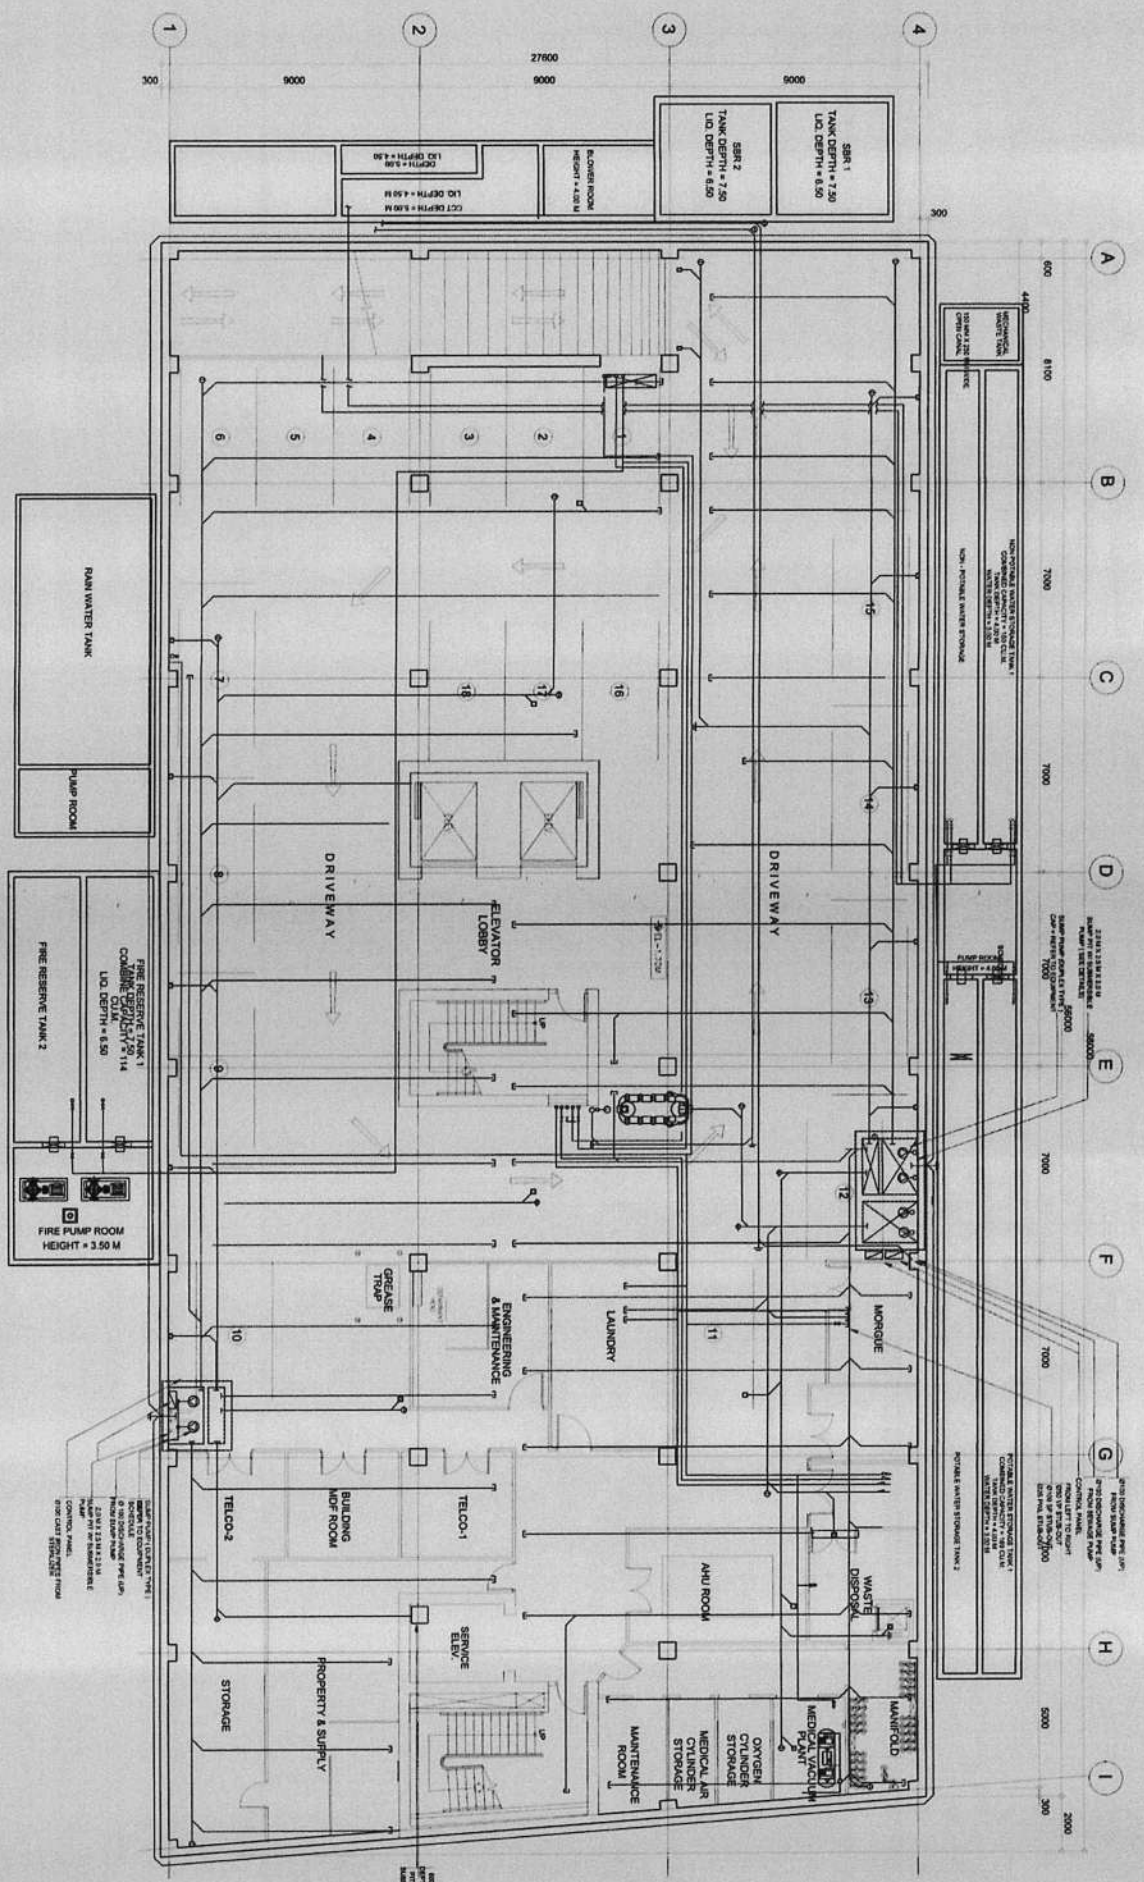


EXISTING BASEMENT FLOOR PLAN

01
 P102
 SCALE
 1 : 100 M.M.

 <p>REPUBLIC OF THE PHILIPPINES OFFICE OF THE MAYOR ENGINEERING OFFICE</p>	<p>PROJECT TITLE: PROPOSED EXPANSION W/ IMPROVEMENT WORKS AT PASIG CITY CHILDREN'S HOSPITAL</p> <p>LOCATION: INDUSTRIAL ZONE ALDABLANO JOSE STS.</p>	<p>PROJECT IN CHARGE: VINCENTE V. YLLAMOR RUP ALDEN A. MARTIN RUP</p>	<p>PROGRAMMING & CONSULTATION: ENGR. ISAAC V. RAMIREZ ENGR. LUCAS B. BERNIZ</p>	<p>RECOMMENDING APPROVAL: ENGR. GERARDO B. TRAVESENCIO ENGR. ARTAVERDEZ V. GERONIMO</p>	<p>APPROVED BY: VICTOR MAX REGIS N. SOTTO CITY MAYOR</p>	<p>SHEET CONTENTS: EXISTING FLOOR PLAN</p> <p>SHEET NO.: 02</p>
---	--	---	---	---	--	--

IMPORTANT NOTES:
 1. NO ALTERATION IN AREA & EXTENT OF WORK SHALL BE MADE WITHOUT THE APPROVAL OF THE ARCHITECT.
 2. IF ANY PART OF THE CONSTRUCTION IS NOT COVERED BY THE DRAWING, THE CONTRACTOR SHALL CONSULT WITH THE ARCHITECT.
 3. IN CASE OF DISCREPANCY IN DIMENSIONS, THE DIMENSIONS SHALL BE TAKEN BY THE CONTRACTOR.
 4. CONTRACTOR SHALL BE RESPONSIBLE FOR THE PROTECTION OF THE EXISTING UTILITIES.
 5. PROJECT IN CHARGE, ENGINEER, ARCHITECT SHALL OBTAIN THE NECESSARY PERMITS FROM THE APPROPRIATE AGENCIES.
 6. CONTRACTOR SHALL BE RESPONSIBLE FOR THE PROTECTION OF THE EXISTING UTILITIES.
 7. CONTRACTOR SHALL BE RESPONSIBLE FOR THE PROTECTION OF THE EXISTING UTILITIES.
 8. CONTRACTOR SHALL BE RESPONSIBLE FOR THE PROTECTION OF THE EXISTING UTILITIES.
 9. CONTRACTOR SHALL BE RESPONSIBLE FOR THE PROTECTION OF THE EXISTING UTILITIES.
 10. CONTRACTOR SHALL BE RESPONSIBLE FOR THE PROTECTION OF THE EXISTING UTILITIES.

CONTRACTOR

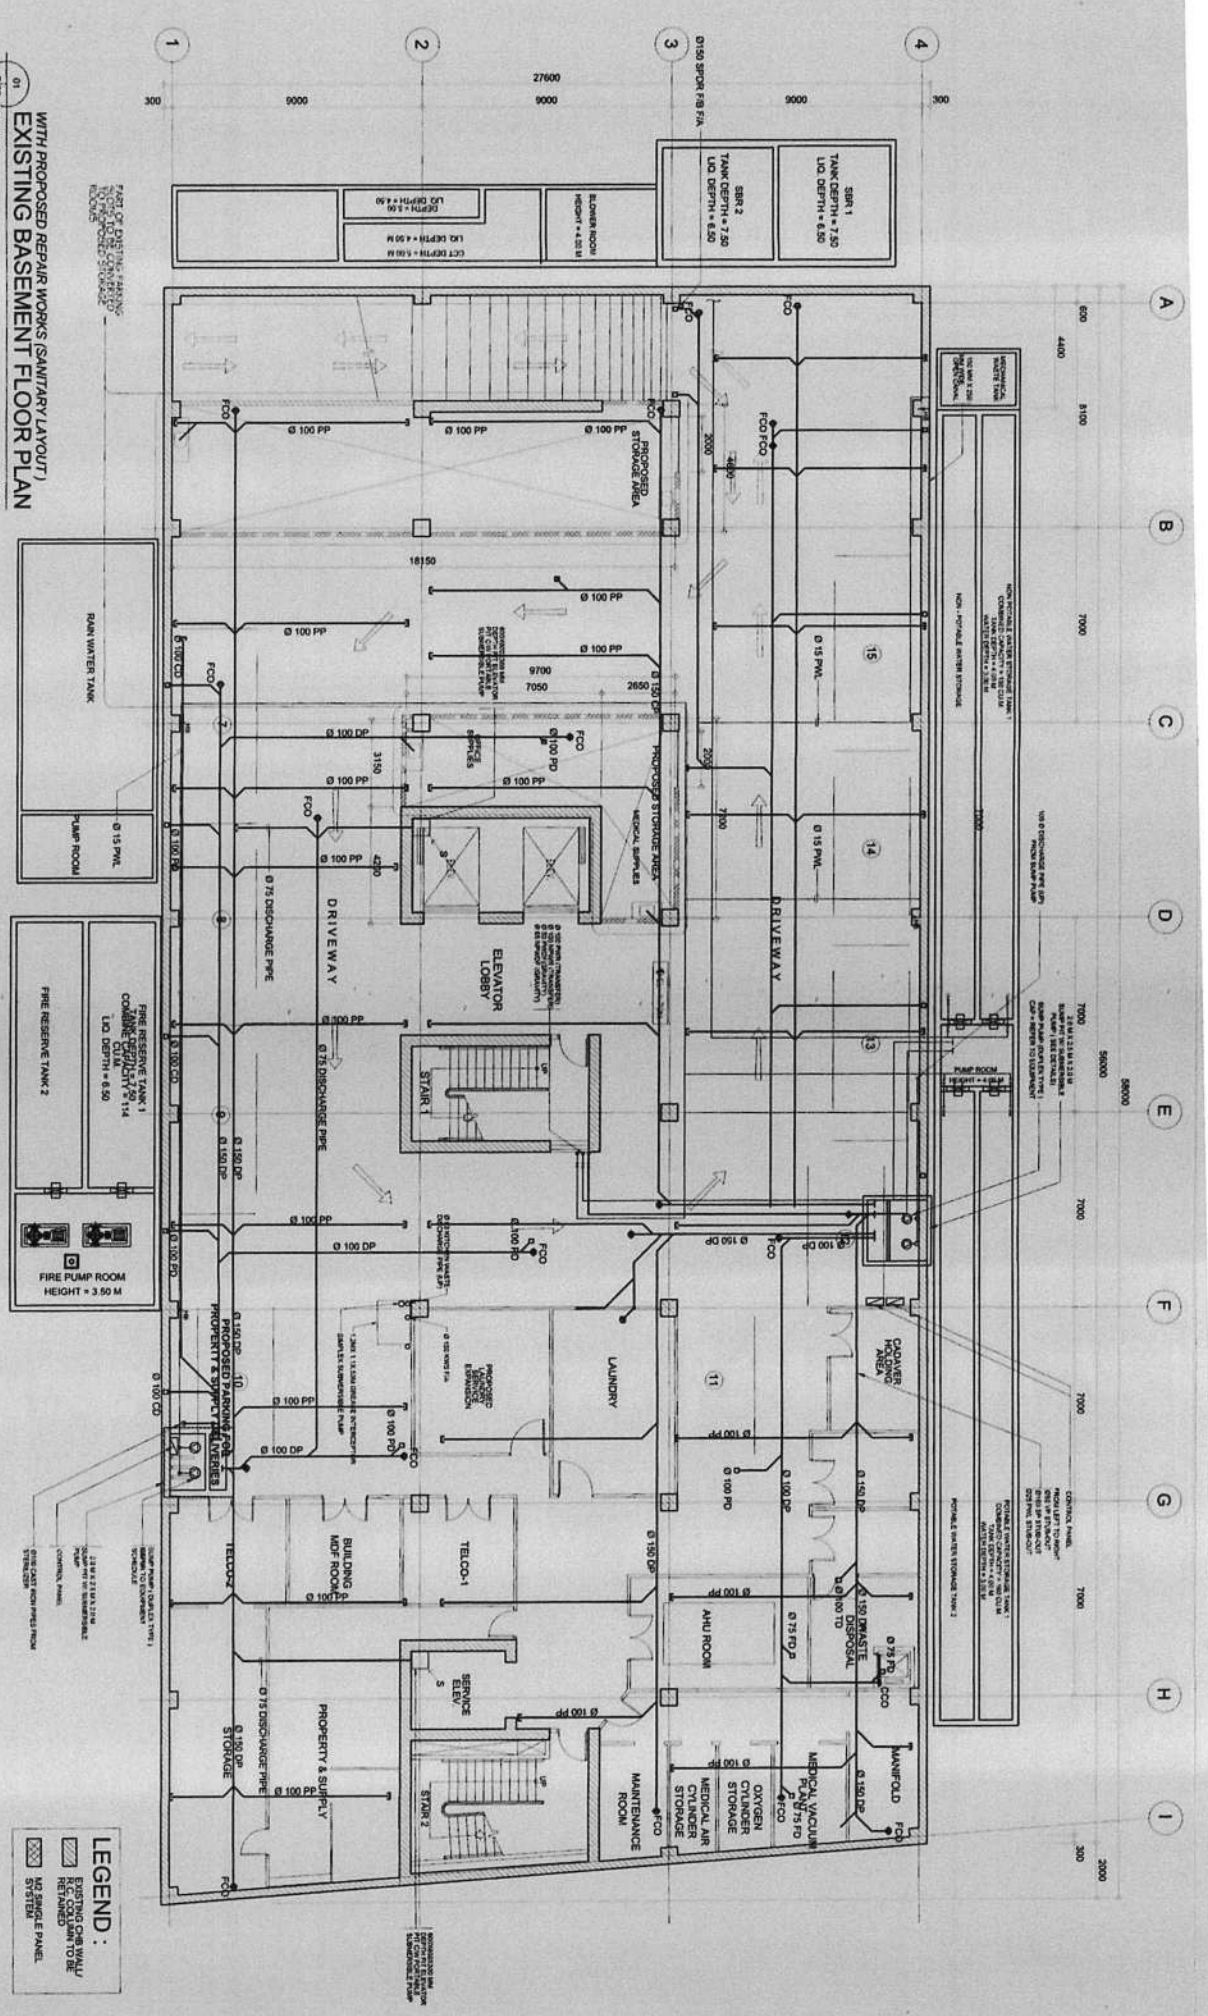

WITH PROPOSED REPAIR WORKS (SANITARY LAYOUT)
EXISTING BASEMENT FLOOR PLAN

SCALE 1:100 ILL.

LEGEND:

	EXISTING CHAS W/ W/
	REG. CONDUIT TO BE
	NO CHANGE PANEL

<p>REPUBLIC OF THE PHILIPPINES CITY OF PASIG ENGINEERING OFFICE</p>	<p>PROJECT TITLE: PROPOSED EXPANSION W/ IMPROVEMENT WORKS AT PASIG CITY CHILDRENS HOSPITAL</p>	<p>PLUMBING: PROJECT IN CHARGE: VINCENT WILLIAMOR RUP</p>	<p>PROGRAMMING & CONSTRUCTION: ENGR. ISMAEL V. RAMERES ENGR. KAREN V. PEREZ</p>	<p>RECOMMENDING APPROVAL: ENGR. CARLOS B. FRUENDENCO ENGR. ARTAVARDES V. GERONIMO</p>	<p>APPROVED BY: VICTOR MA. REGIS N. SOTTO CITY MAYOR</p>	<p>SHEET CONTENTS: EXISTING BASEMENT FLOOR WITH PROPOSED REPAIR WORKS (SANITARY LAYOUT) CADD: MAMARTIN</p>	<p>SHEET NO.: P 03</p>
	<p>LOCATION: INDUSTRIAL CORP. ALIQUILAN JOSE STS.</p>	<p>2. # OF CONTRACTS: THE CONTRACT SHALL BE FOR THE ENTIRE WORK TO BE PERFORMED. THE CONTRACT SHALL BE FOR THE ENTIRE WORK TO BE PERFORMED.</p>	<p>3. # OF CONTRACTS: THE CONTRACT SHALL BE FOR THE ENTIRE WORK TO BE PERFORMED. THE CONTRACT SHALL BE FOR THE ENTIRE WORK TO BE PERFORMED.</p>	<p>4. APPROVAL: THE INSTRUCTIONS SHALL BE CONNECTED TO THE EXTENT OF THE</p>	<p>5. # OF CONTRACTS: THE CONTRACT SHALL BE FOR THE ENTIRE WORK TO BE PERFORMED. THE CONTRACT SHALL BE FOR THE ENTIRE WORK TO BE PERFORMED.</p>	<p>CONTRACTOR & ACCEPTED BY: CONTRACTOR</p>	

REPUBLIC OF THE PHILIPPINES
 CITY OF PASIG
ENGINEERING OFFICE

PROJECT TITLE:
**PROPOSED EXPANSION W/
 IMPROVEMENT WORKS AT
 PASIG CITY CHILDRENS HOSPITAL**

PLUMBING:
 PROJECT IN CHARGE:
VINCENT WILLIAMOR RUP

PROGRAMMING & CONSTRUCTION:
 ENGR. ISMAEL V. RAMERES
 ENGR. KAREN V. PEREZ


RECOMMENDING APPROVAL:
 ENGR. CARLOS B. FRUENDENCO
 ENGR. ARTAVARDES V. GERONIMO

APPROVED BY:
VICTOR MA. REGIS N. SOTTO
 CITY MAYOR


SHEET CONTENTS:
 EXISTING BASEMENT FLOOR
 WITH PROPOSED REPAIR WORKS
 (SANITARY LAYOUT)
 CADD: MAMARTIN

SHEET NO.:
**P
 03**

CONTRACTOR & ACCEPTED BY:
CONTRACTOR

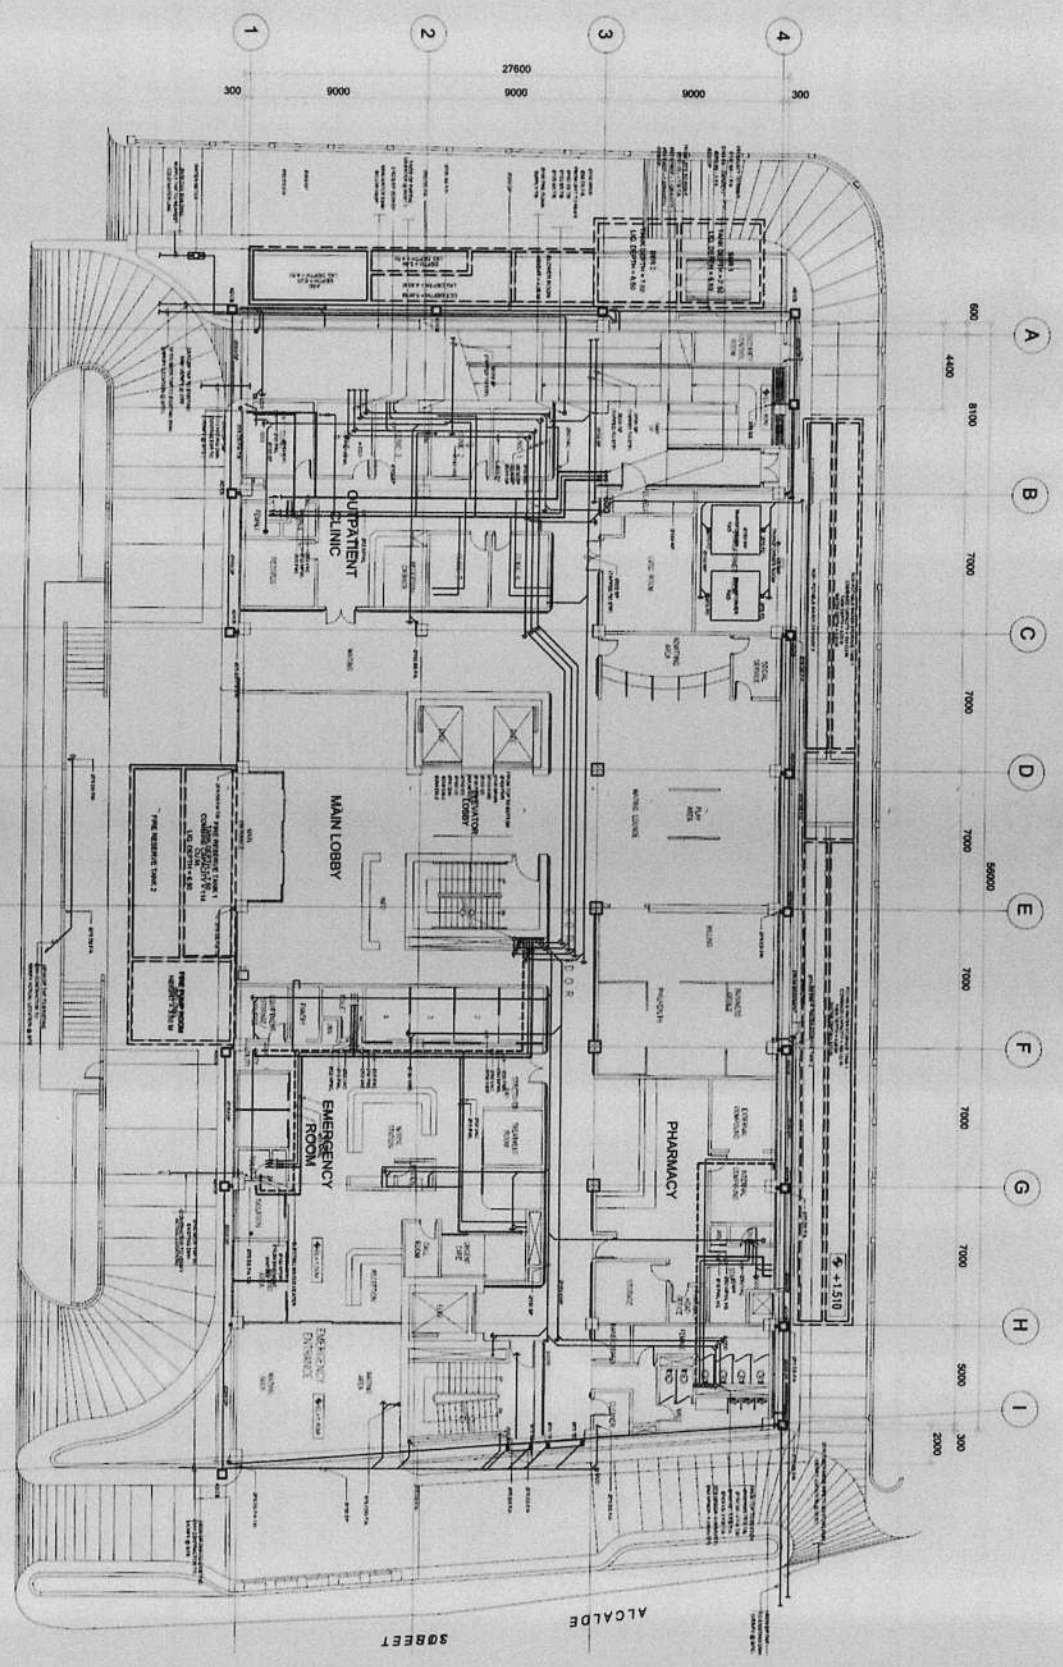


STREET INDUSTRIA
EXISTING GROUND FLOOR PLAN (SANITARY LAYOUT)
SCALE: 1:100

	REPUBLIC OF THE PHILIPPINES CITY OF PASIG OFFICE OF THE MAYOR ENGINEERING OFFICE	PROJECT TITLE: PROPOSED EXPANSION W/ IMPROVEMENT WORKS AT PASIG CITY CHILDREN'S HOSPITAL	PROJECT IN CHARGE: VINCENT WILLIAMOR RUP ALDYN A. MARTIN RUP	PROGRAMMING & CONSTRUCTION: ENGR. JUAN ANTONIO PEREZ	RECOMMENDING APPROVAL: ENGR. ERNESTO TRINIDAD	APPROVED BY: VICTOR MA. REGIS N. SOTTO CITY MAYOR	SHEET CONTENTS: EXISTING GROUND FLOOR (SANITARY LAYOUT)	SHEET NO.: P 04
---	---	--	--	---	--	---	--	-----------------------

IMPORTANT NOTES

1. NO ALTERATION SHALL BE MADE TO THE SCALE OF THIS DRAWING.
2. IF ANY PART OF THIS DRAWING IS TO BE USED IN ANY OTHER PROJECT, THE USER SHALL BE RESPONSIBLE FOR THE ACCURACY OF THE INFORMATION DERIVED THEREFROM.
3. IN THE EVENT OF DISCREPANCY IN THE DRAWING, THE CONTRACTOR SHALL BE RESPONSIBLE FOR THE CORRECTION OF THE SAME.
4. ALL WORK SHALL BE IN ACCORDANCE WITH THE SPECIFICATIONS AND STANDARDS OF THE PROFESSION.
5. THE CONTRACTOR SHALL BE RESPONSIBLE FOR THE PROTECTION OF ALL EXISTING UTILITIES AND STRUCTURES TO REMAIN.
6. THE CONTRACTOR SHALL BE RESPONSIBLE FOR THE PROTECTION OF ALL EXISTING UTILITIES AND STRUCTURES TO REMAIN.

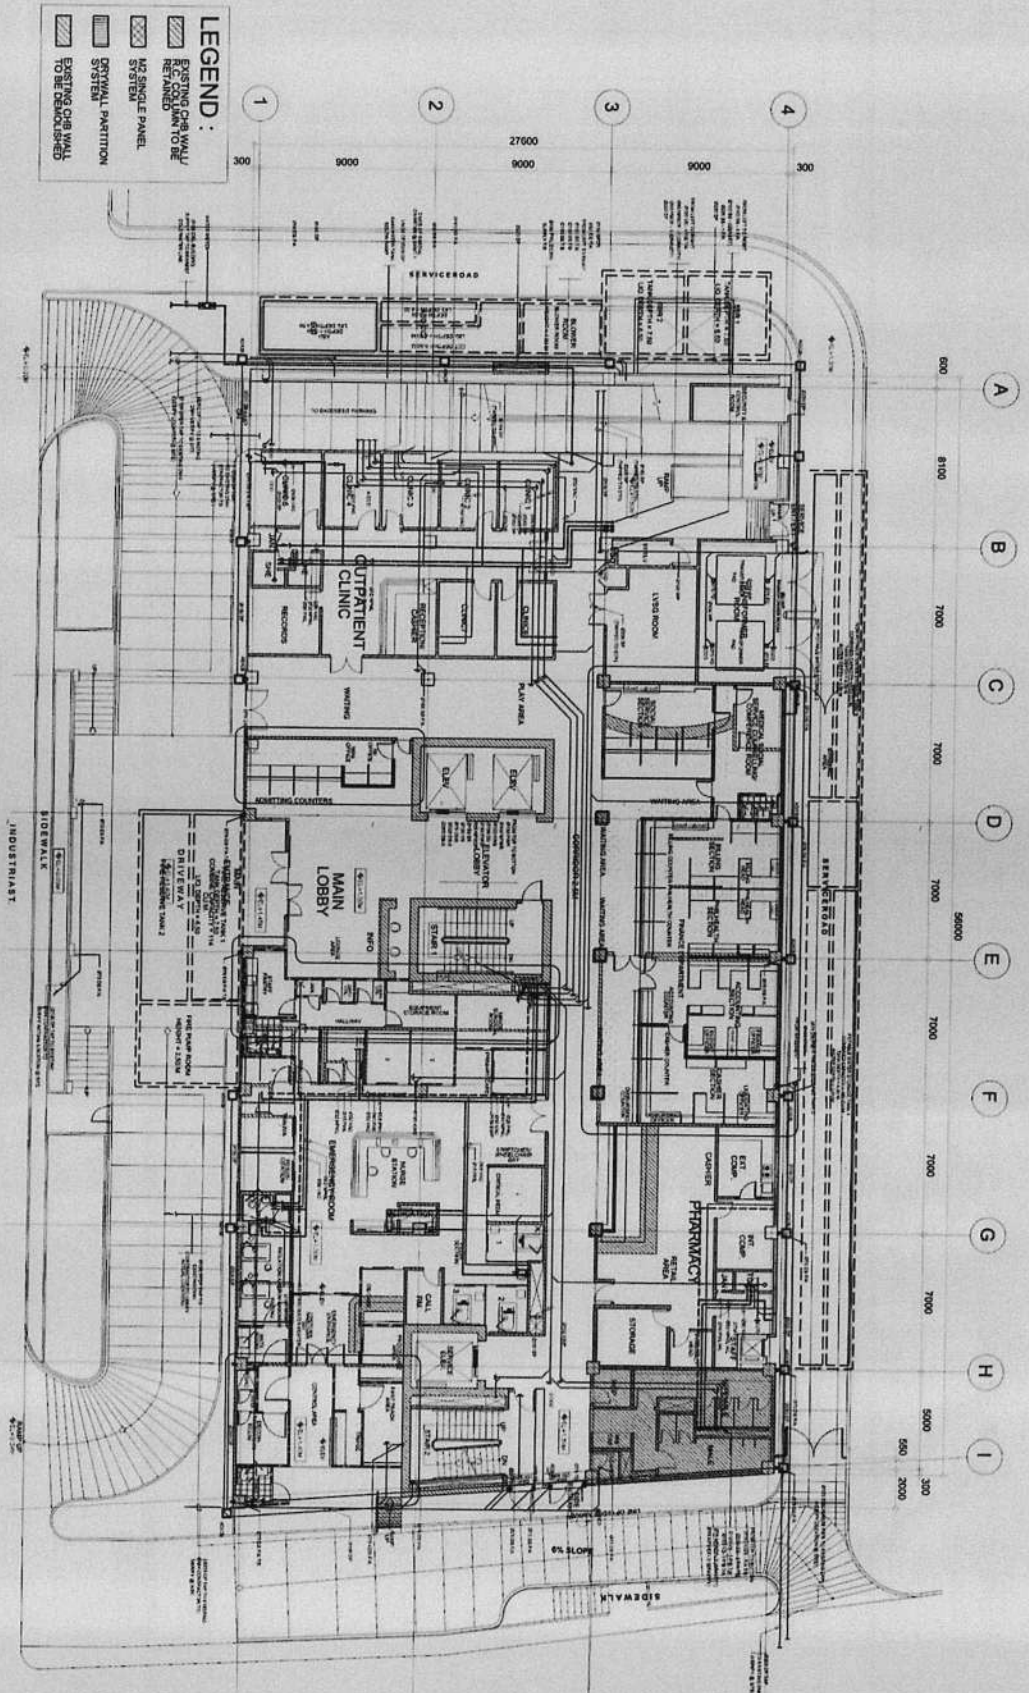

WITH PROPOSED REPAIR WORKS (SANITARY LAYOUT)
 01
 EXISTING GROUND FLOOR PLAN
 1:100 N.M.L.



REPUBLIC OF THE PHILIPPINES
 CITY OF PASIG
 OFFICE OF THE MAYOR
 ENGINEERING OFFICE

PROJECT TITLE:
**PROPOSED EXPANSION W/
 IMPROVEMENT WORKS AT
 PASIG CITY CHILDREN'S HOSPITAL**

PLUMBING:
 PROJECT IN CHARGE
VINCENT V. WILLAMOR RUP
 PROJECT IN CHARGE
ALLEN X. MARTIN RUP

PROGRAMMING & CONSTRUCTION:
ENGR. (SAB) V. RAÑESES
 CHIEF ARCHITECT
ENGR. JUAN V. GARCIA
 ARCHITECT

RECOMMENDING APPROVAL:
ENGR. FRANCISCO B. FRUDESCO
 CHIEF ENGINEER
ENGR. ARTAXERXES V. GERONIMO
 O.I.C. ENGINEERING OFFICE

APPROVED BY:
VICTOR MA. REGIS N. SOTTO
 CITY MAYOR

SHEET CONTENTS:
 EXISTING GROUND FLOOR
 WITH PROPOSED REPAIR
 WORKS (SANITARY LAYOUT)
 CAD: AMMARTIN

SHEET NO.:
 P
 05

IMPORTANT NOTES:
 1. NO ALTERATION IN PLAN & SECTION SHALL BE MADE WITHOUT THE WRITTEN APPROVAL OF THE ARCHITECT.
 2. IF ANY OF THE CONTRACTOR'S WORKERS ARE IN THE COURSE OF THE CONSTRUCTION OF THE PROJECT, THE CONTRACTOR SHALL BE RESPONSIBLE FOR THE PROTECTION OF THE EXISTING STRUCTURE.
 3. IN CASE OF DISCREPANCY BETWEEN THE PROVISIONS OF THE CONTRACT AND THE DRAWINGS, THE CONTRACTOR SHALL CONTACT THE ARCHITECT IMMEDIATELY.
 4. ANY VARIATION OF THIS INSTRUCTION SHALL BE CORRECTED AT THE EXPENSE OF THE CONTRACTOR.
 5. PROJECT IN CHARGE, RECOMMENDING APPROVAL, APPROVED BY, CONTRACTOR, AND CONTRACTOR'S OFFICE SHALL BE RESPONSIBLE FOR THE PROTECTION OF THE EXISTING STRUCTURE.
 CONTRACTOR



REPUBLIC OF THE PHILIPPINES
CITY OF PASIG
OFFICE OF THE MAYOR
ENGINEERING OFFICE

PROJECT TITLE:
**PROPOSED EXPANSION WITH
IMPROVEMENT WORKS AT
PASIG CITY CHILDREN'S HOSPITAL**

PROJECT IN CHARGE:
VINCENT *VILLANOR RUP*
ALIAN M. MARTIN RUP

PROGRAMMING & CONSTRUCTION:
ENGR. *ALBERTO V. RABESSES*
ENGR. *LUIS PEREZ*

RECOMMENDING APPROVAL:
ENGR. *EMERSON E. BRUDENCO*

ENGR. *ART ALEXANDRE V. GERONIMO*
C.I.C. ADMINISTRATION OFFICE


APPROVED BY:
VICTOR MAX TRIGIS N. SOTTO,
CITY MAYOR

SHEET CONTENTS:
EXISTING SECOND FLOOR
CADD: AAMARTIN

SHEET NO.:
P
06

IMPORTANT NOTES:
1. ALL MATERIALS SHALL BE OF THE BEST QUALITY AND SHALL BE APPROVED BY THE ENGINEERING OFFICE.
2. IF ANY PART OF THE CONSTRUCTION IS TO BE COMPLETED IN PHASES, THE PHASES SHALL BE INDICATED IN THE DRAWINGS.
3. ALL WORK SHALL BE IN ACCORDANCE WITH THE SPECIFICATIONS AND STANDARDS OF THE BUREAU OF FIRE PREVENTION AND PROTECTION.
4. ALL WORK SHALL BE COMPLETED WITHIN THE SPECIFIED TIME FRAME.
5. THE CONTRACTOR SHALL BE RESPONSIBLE FOR OBTAINING ALL NECESSARY PERMITS AND APPROVALS.
6. THE CONTRACTOR SHALL BE RESPONSIBLE FOR THE PROTECTION AND MAINTENANCE OF ALL EXISTING UTILITIES AND STRUCTURES.

EXISTING SECOND FLOOR PLAN
1:500

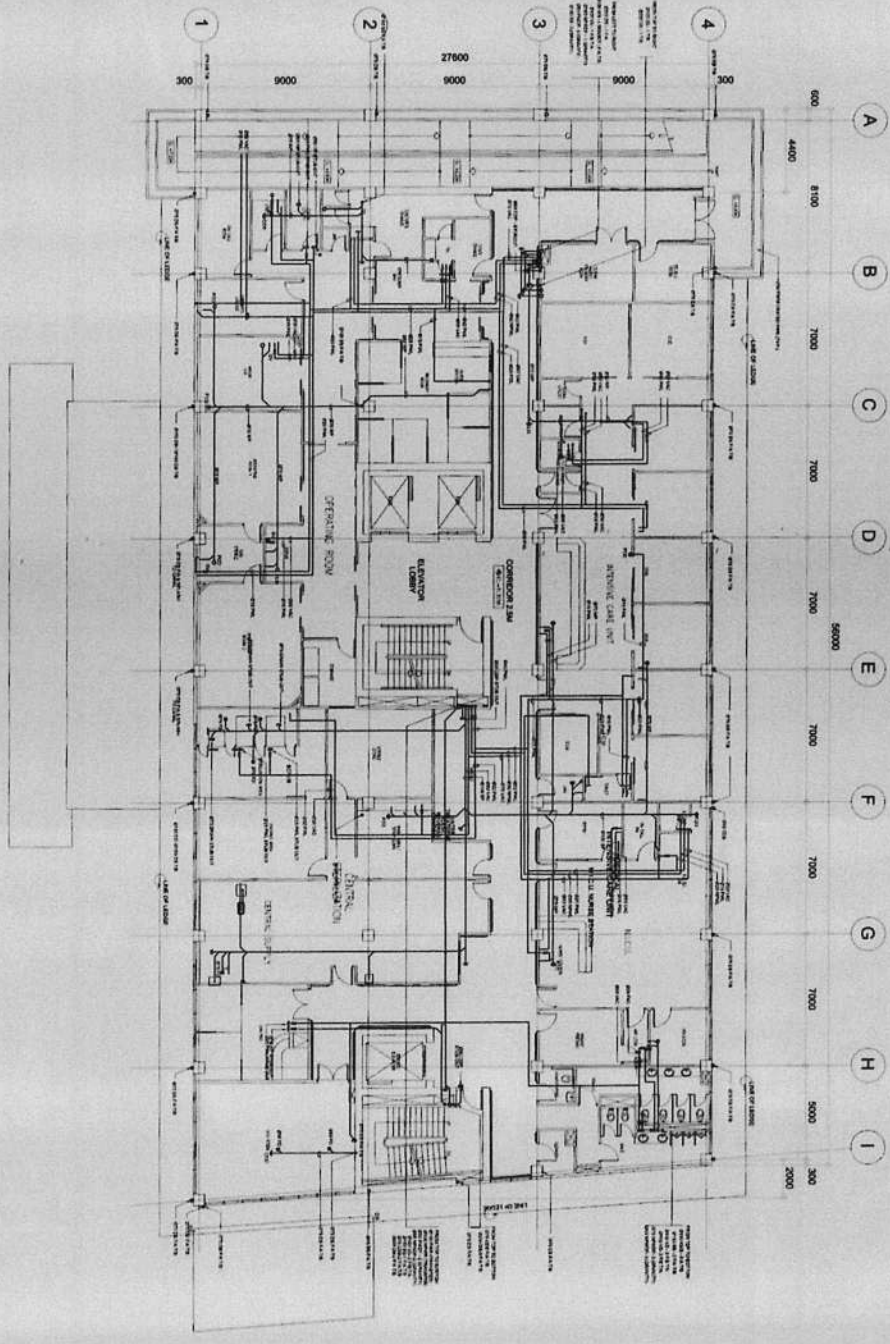



REPUBLIC OF THE PHILIPPINES
CITY OF PASIG
OFFICE OF THE MAYOR
ENGINEERING OFFICE

PROJECT TITLE:
**PROPOSED EXPANSION W/
IMPROVEMENT WORKS AT
PASIG CITY CHILDREN'S HOSPITAL**

PLUMBING
PROJECT IN CHARGE:
VINCENT V. WILLAMOR RUP
ALLAN A. MARTIN RUP

PROGRAMMING & CONSTRUCTION:
ENGR. **ISABELA S. GABARDES**
ENGR. **ALBERTO S. GABARDES**


RECOMMENDING APPROVAL:
ENGR. **JOSE B. RAUDENCIO**
ENGR. **ARTABERES V. GERONIMO**

APPROVED BY:
VICTOR MAX REGIS N. SOTTO
CITY MAYOR


SHEET CONTENTS:
EXISTING SECOND FLOOR
WITH PROPOSED REPAIR
(SANITARY LAYOUT)
CADD: AMMARTIN

SHEET NO.:
P
07

IMPORTANT NOTES:
1. NO ALTERATION IN PLUMBING & ELECTRICAL SYSTEMS SHALL BE MADE WITHOUT THE APPROVAL OF THE ARCHITECT AND ENGINEER.
2. IF ANY WORK IS TO BE DONE IN THE EXISTING SYSTEM, THE CONTRACTOR SHALL BE RESPONSIBLE FOR THE PROTECTION OF THE SAME.
3. IN CASE OF DISCREPANCY BETWEEN THE CONTRACT DOCUMENTS, THE CONTRACTOR SHALL BE RESPONSIBLE FOR THE CORRECTION.
4. APPROVED FOR THE CONTRACTOR BY THE ARCHITECT & ENGINEER.
5. PROJECT REPORT TO THE RESIDENT ENGINEER, THE PROJECT AT ALL STAGES SHALL BE SUBMITTED TO THE ARCHITECT & ENGINEER.
6. CONTRACTOR SHALL BE RESPONSIBLE FOR THE PROTECTION OF THE EXISTING SYSTEMS.

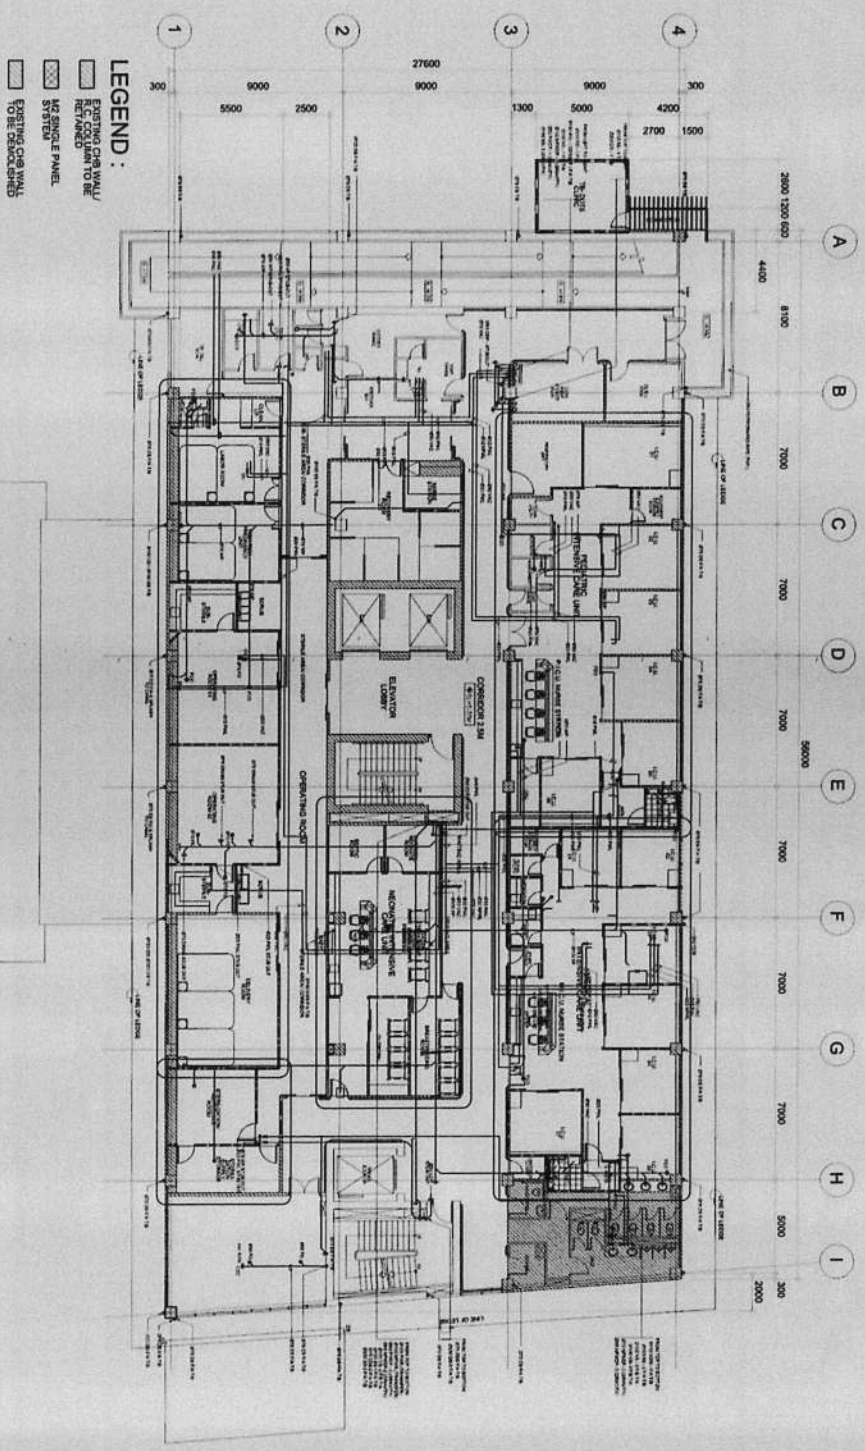


WITH PROPOSED REPAIR WORKS (SANITARY LAYOUT)
EXISTING SECOND FLOOR PLAN
1:100 SCALE

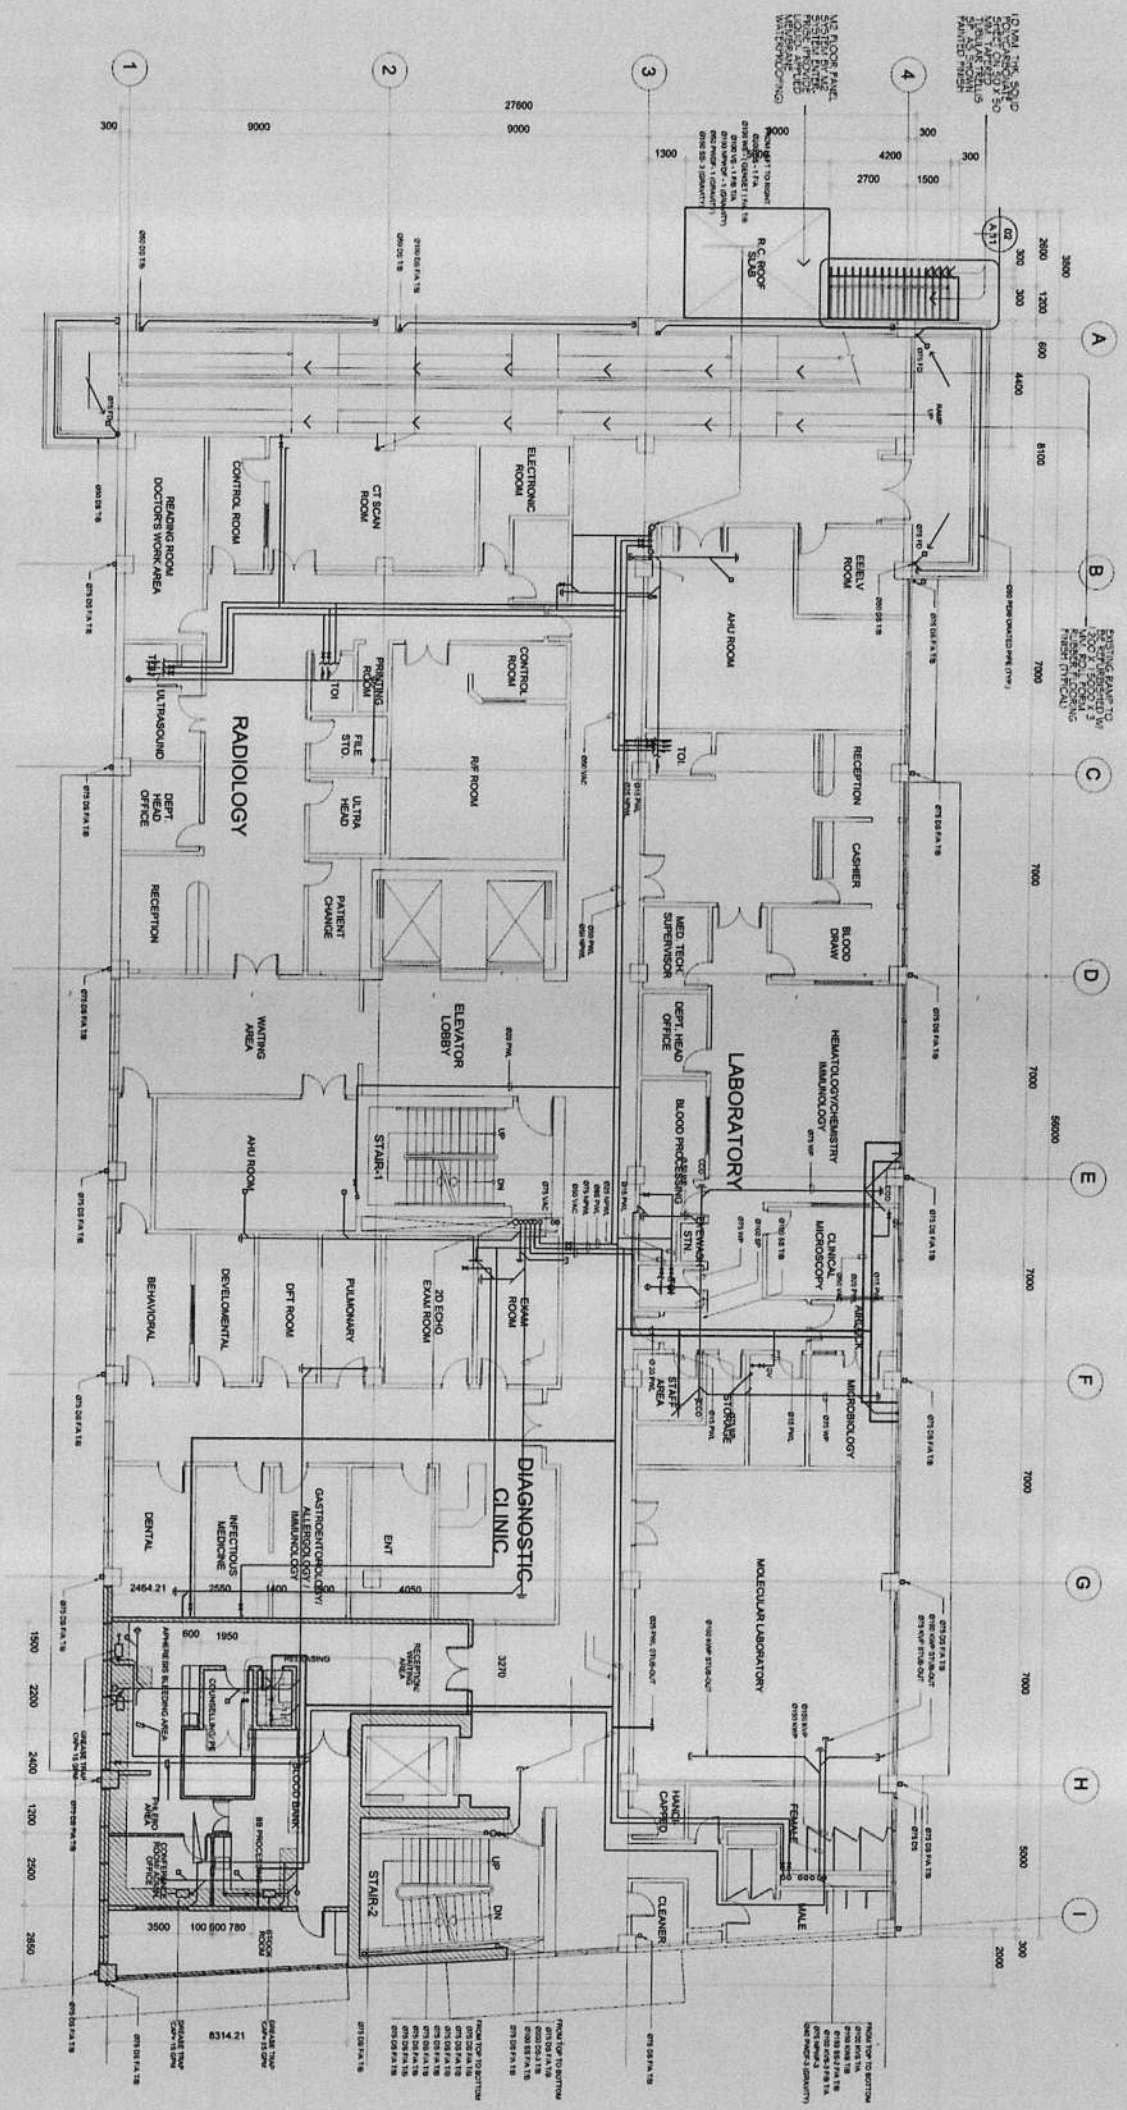

EXISTING THIRD FLOOR PLAN
 1:100 M.M.

	REPUBLIC OF THE PHILIPPINES CITY OF PASIG OFFICE OF THE MAYOR ENGINEERING OFFICE	PROJECT TITLE: PROPOSED EXPANSION W/ IMPROVEMENT WORKS AT PASIG CITY CHILDREN'S HOSPITAL	PROJECT NO. CHARGED: VINCENY V. VILLAMOR RUP	PROGRAMMING & CONSTRUCTION: ENGR. JUAN V. RAMAYSES CHIEF OF DIVISION	RECOMMENDING APPROVAL: ENGR. ARTAVERSEY GERONIMO CHIEF OF DIVISION	APPROVED BY: VICTOR MAE REGIS N. SOTTO CITY MAYOR	SHEET CONTENTS: EXISTING THIRD FLOOR P	SHEET NO.: 08	
IMPORTANT NOTES: 1. NO ALTERATION IN PLAN & SPECIFICATIONS SHALL BE MADE WITHOUT THE APPROVAL OF THE ARCHITECT AND ENGINEER. 2. CONTRACTOR SHALL BE RESPONSIBLE FOR OBTAINING ALL NECESSARY PERMITS AND APPROVALS FROM THE APPROPRIATE AGENCIES. 3. ALL WORK SHALL BE COMPLETED WITHIN THE SPECIFIED TIME FRAME. 4. ANY VIOLATION OF THIS INSTRUCTION SHALL BE CONSIDERED AT THE RISK OF THE CONTRACTOR.		LOCATION: INDUSTRIAL COR. ALAYOGUE JOSE STR. PASIG, METRO MANILA		PROJECT NO. CHARGED: ALLANTA A. MARTIN RUP		RECOMMENDING APPROVAL: ENGR. JUAN V. RAMAYSES CHIEF OF DIVISION		APPROVED BY: VICTOR MAE REGIS N. SOTTO CITY MAYOR	
		PROJECT TITLE: PROPOSED EXPANSION W/ IMPROVEMENT WORKS AT PASIG CITY CHILDREN'S HOSPITAL		PROGRAMMING & CONSTRUCTION: ENGR. JUAN V. RAMAYSES CHIEF OF DIVISION		RECOMMENDING APPROVAL: ENGR. ARTAVERSEY GERONIMO CHIEF OF DIVISION		SHEET CONTENTS: EXISTING THIRD FLOOR P	
		PROJECT TITLE: PROPOSED EXPANSION W/ IMPROVEMENT WORKS AT PASIG CITY CHILDREN'S HOSPITAL		PROGRAMMING & CONSTRUCTION: ENGR. JUAN V. RAMAYSES CHIEF OF DIVISION		RECOMMENDING APPROVAL: ENGR. ARTAVERSEY GERONIMO CHIEF OF DIVISION		SHEET NO.: 08	

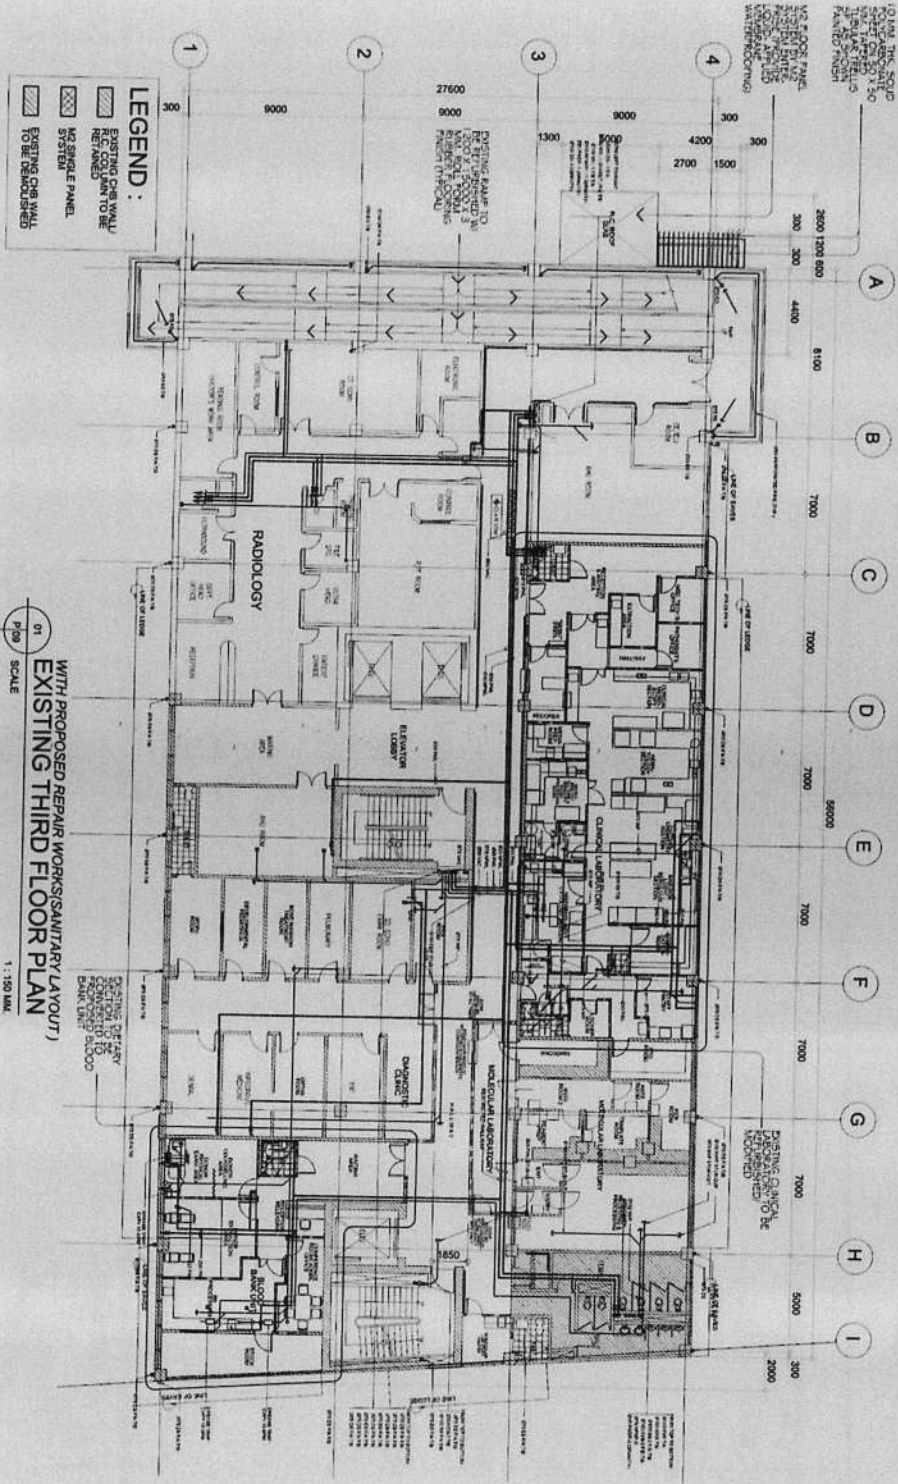

WITH PROPOSED REPAIR WORKS (SANITARY LAYOUT)
 01
 EXISTING THIRD FLOOR PLAN
 SCALE 1:150



REPUBLIC OF THE PHILIPPINES
 CITY OF PASIG
 OFFICE OF THE MAYOR
 ENGINEERING OFFICE

PROJECT TITLE:
**PROPOSED EXPANSION W/
 IMPROVEMENT WORKS AT
 PASIG CITY CHILDREN'S HOSPITAL**

PLANNING
 PROJECT CHARGE
VINCENZO V. VILLAMOR RMP
ALDIN A. MARTIN RMP

PROGRAMMING & CONSTRUCTION:
 ENGR. **JOSE V. RALESSES**
 ENGR. **JUAN CARLOS I. PEREZ**


RECOMMENDING APPROVAL:
 ENGR. **EDUARDO B. PRUDENCIO**
 ENGR. **ARTAVERDES V. GERONIMO**

APPROVED BY:
VICTOR MA. REGIS N. SOTTO
 CITY MAYOR


SHEET CONTENTS:
 EXISTING 3RD FLOOR
 WITH PROPOSED REPAIR
 (SANITARY LAYOUT)
 CADD: **AMMARTIN**


SHEET NO.:
**P
 09**

IMPORTANT NOTES:
 1. NO ALTERATION IN MATERIALS AND SECTION OF THE STRUCTURE SHALL BE MADE.
 2. IF ANY CHANGE IN THE CONSTRUCTION METHODS, MATERIALS, OR SECTION OF THE STRUCTURE, THE CONTRACTOR SHALL BE RESPONSIBLE FOR THE STRUCTURE.
 3. IN CASE OF CONSTRUCTION, THE CONTRACTOR SHALL BE RESPONSIBLE FOR THE CONSTRUCTION.
 4. ANY VIOLATION OF THIS RESTRICTION SHALL BE CONSIDERED AS THE EXPENSE OF THE CONTRACTOR.
 5. PROJECT IN COMPLIANCE WITH THE PROVISIONS OF THE NATIONAL BUILDING CODE AND THE NATIONAL ELECTRICAL CODE.
 6. CONTRACTOR SHALL PROVIDE ALL NECESSARY PERMITS AND APPROVALS FROM THE CONCERNED AGENCIES.
 CONTRACTOR

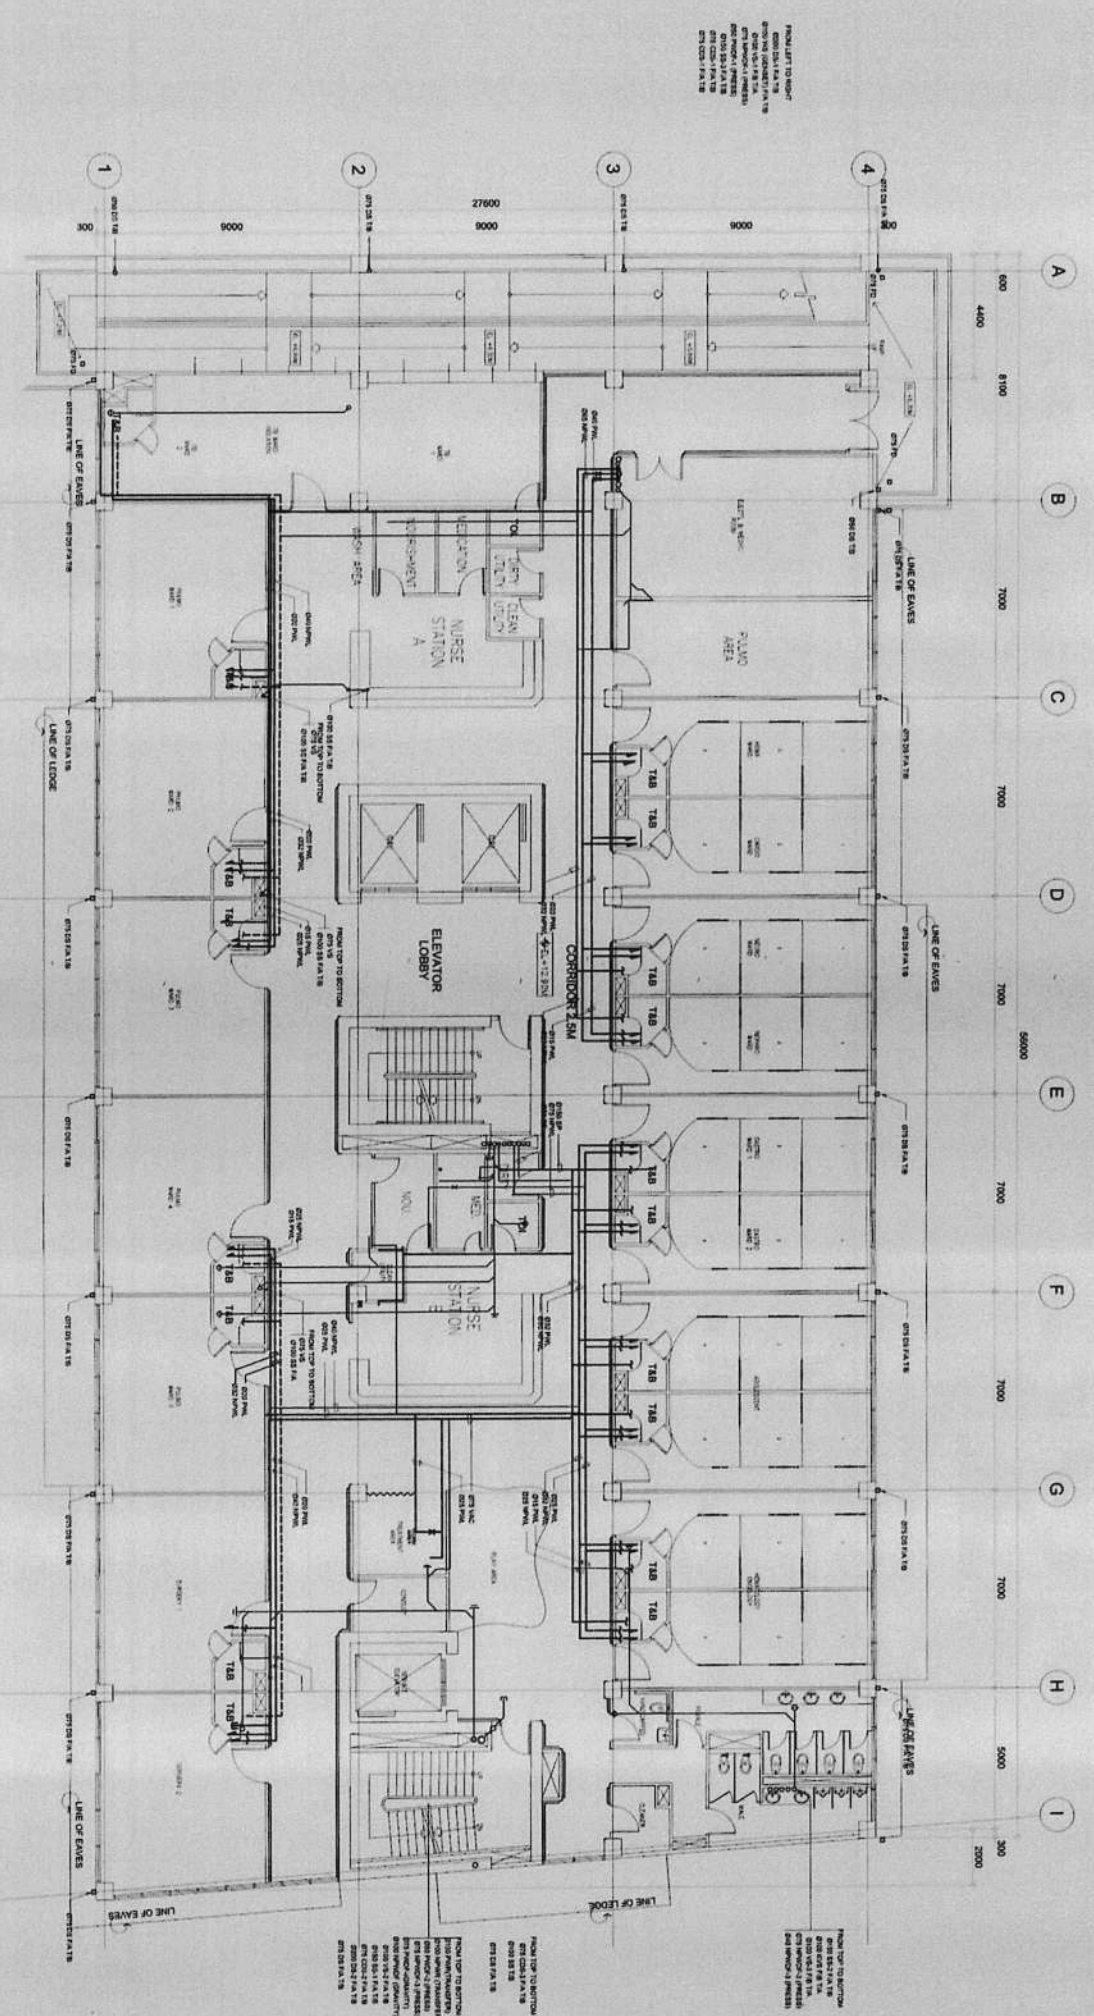


EXISTING FOURTH FLOOR PLAN
 01
 P10
 SCALE
 1 : 100 MM

	REPUBLIC OF THE PHILIPPINES OFFICE OF THE MAYOR ENGINEERING OFFICE	PROJECT TITLE: PROPOSED EXPANSION W/ IMPROVEMENT WORKS AT PASIG CITY CHILDREN'S HOSPITAL	PLUMBING PROJECT IN CHARGE: VINCENT WILLIAMOR RMP ALDYN A. MARTIN RMP	PROGRAMMING & CONSTRUCTION: ENGR. JESPER RANESSES ENGR. JUAN P. GENEZ	RECOMMENDING APPROVAL: ENGR. FRANCIS PRUDENCIO ENGR. ARTAVARDES V. GERONIMO	APPROVED BY: VICTOR MA. REGIS N. SOTTO CITY MAYOR	SHEET CONTENTS: EXISTING FOURTH FLOOR CADD: AMMARTIN	SHEET NO.: <div style="border: 1px solid black; width: 30px; height: 30px; text-align: center; margin: 0 auto;"> P <hr/> 10 </div>
IMPORTANT NOTES: 1. LOCAL REGULATIONS & SPECIFICATIONS SHALL BE USED. 2. THE CONTRACTOR SHALL BE RESPONSIBLE FOR THE DESIGN AND CONSTRUCTION OF THE STRUCTURE. 3. A NOTE OF CORRECTION IN THE CONTRACT SHALL BE SUBMITTED TO THE ARCHITECT FOR APPROVAL. 4. ANY MODIFICATION OF THE INSTRUCTIONS SHALL BE CONNECTED AT THE EXPENSE OF THE CONTRACTOR.		LOCATION: INDUSTRIAL COR. ALABANG JOSE STS. PASIG CITY		5. PROJECT REPORT: THE CONTRACTOR SHALL SUBMIT THE REPORT AT ALL STAGES OF THE PROJECT. 6. CONTRACTOR SHALL NOTIFY THE ARCHITECT & ENGINEER WHO		CONTRACTOR & ACCEPTED BY: <div style="border: 1px solid black; width: 100%; height: 30px; margin: 0 auto;"></div>		

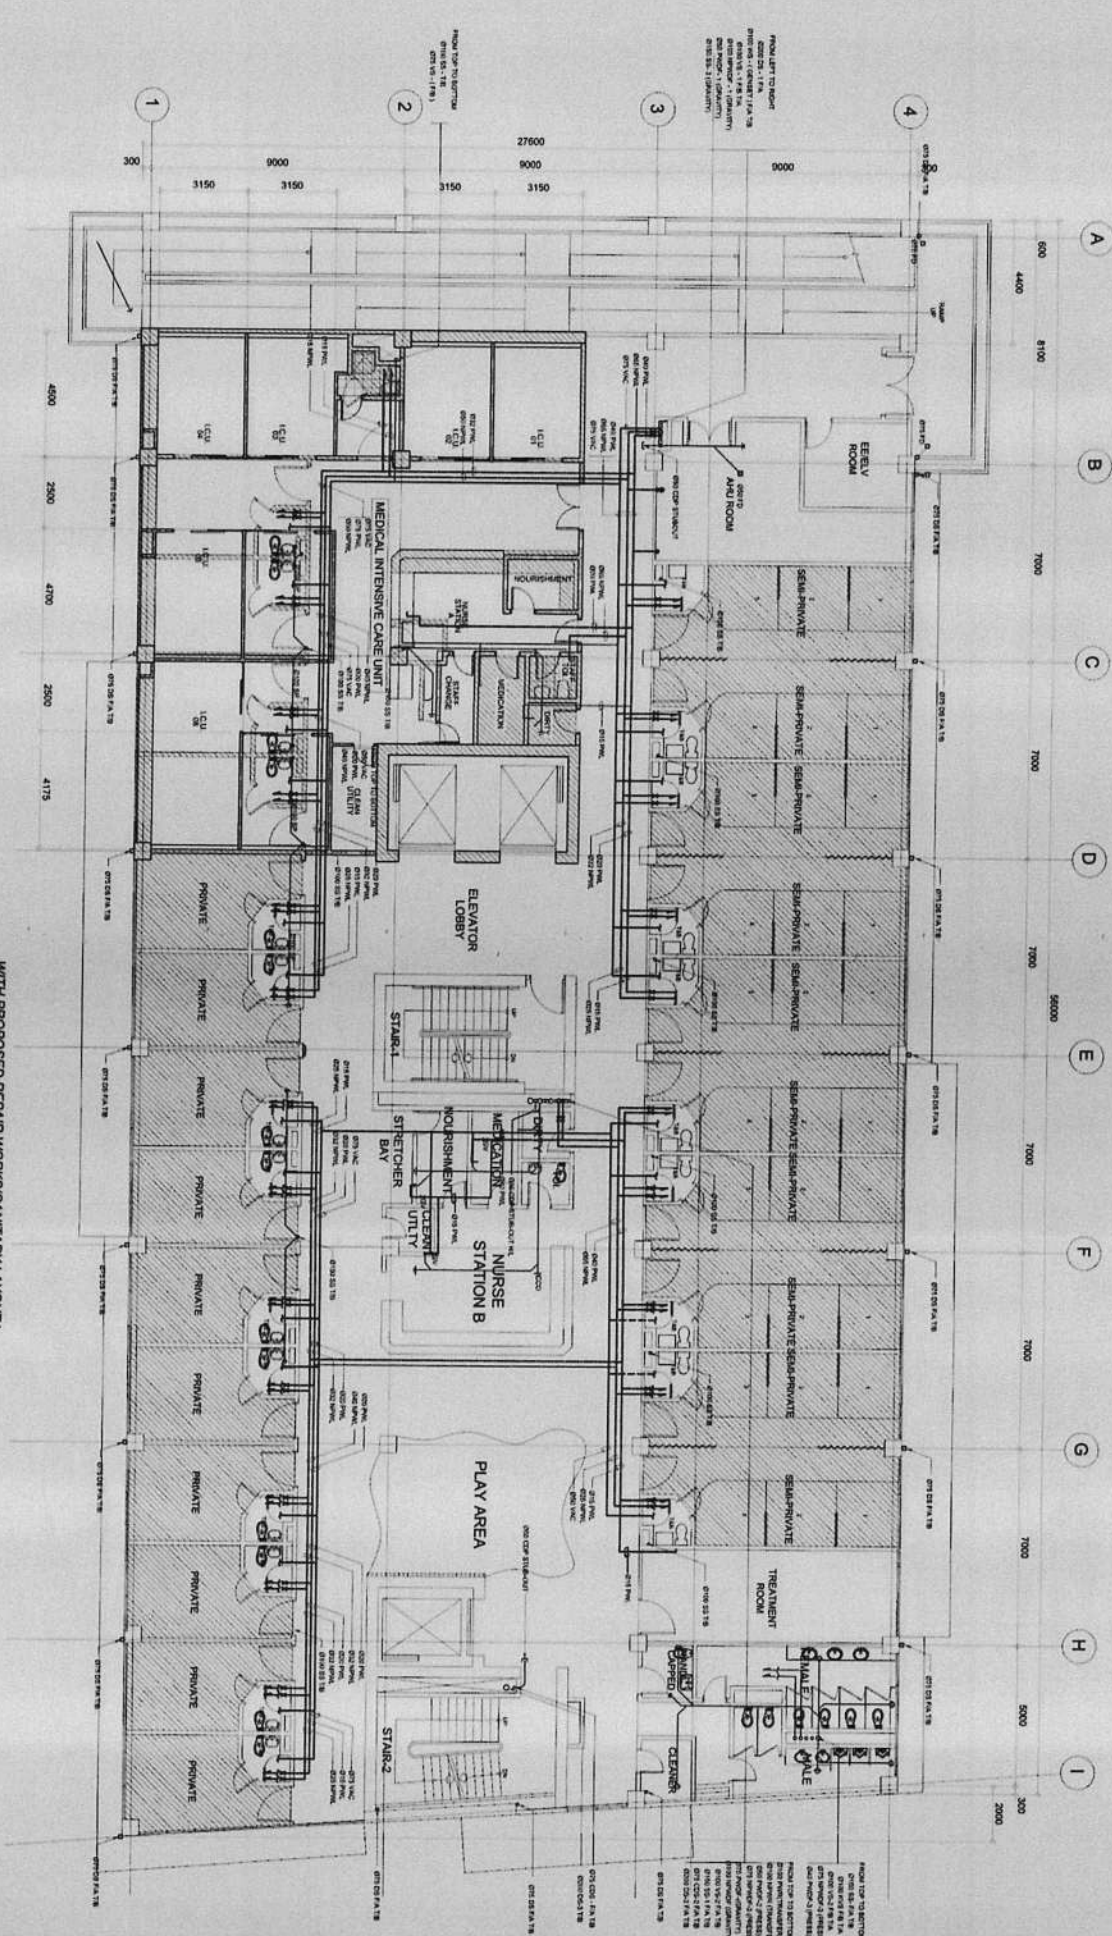

WITH PROPOSED REPAIR WORKS (SANITARY LAYOUT)
 EXISTING FIFTH FLOOR PLAN
 SCALE 1:100

		REPUBLIC OF THE PHILIPPINES CITY OF PASIG OFFICE OF THE MAYOR ENGINEERING OFFICE		PROJECT TITLE: PROPOSED EXPANSION W/ IMPROVEMENT WORKS AT PASIG CITY CHILDREN'S HOSPITAL		PROJECT IN CHARGE: VINCENZO VILLAMOR RAMP ALBERTO MARTIN RAMP		PROGRAMMING & CONSTRUCTION: ENGR. JESUS V. RAJARES ENGR. JUAN V. PEREZ		RECOMMENDING APPROVAL: ENGR. ARTAVARDES V. GERONIMO D.L. ENGINEERING OFFICE		APPROVED BY: VICTOR MA. REGIS N. SOTTO CITY MAYOR		SHEET CONTENTS: EXISTING 5TH FLOOR PLAN (SANITARY LAYOUT)		SHEET NO.: 12	
IMPORTANT NOTES: 1. NO ALTERATION IN THE SANITARY LAYOUT OF THE EXISTING FLOOR SHALL BE MADE WITHOUT THE APPROVAL OF THE ARCHITECT. 2. THE CONTRACTOR SHALL BE RESPONSIBLE FOR THE PROTECTION OF THE EXISTING STRUCTURE AND UTILITIES. 3. THE CONTRACTOR SHALL BE RESPONSIBLE FOR THE PROTECTION OF THE EXISTING UTILITIES. 4. ANY ALTERATION OF THE STRUCTURE SHALL BE COMPLETED AT THE EXPENSE OF THE CONTRACTOR. 5. THE CONTRACTOR SHALL BE RESPONSIBLE FOR THE PROTECTION OF THE EXISTING UTILITIES. 6. THE CONTRACTOR SHALL BE RESPONSIBLE FOR THE PROTECTION OF THE EXISTING UTILITIES.														CONTRACTOR: CONFORME & ACCEPTED BY:			

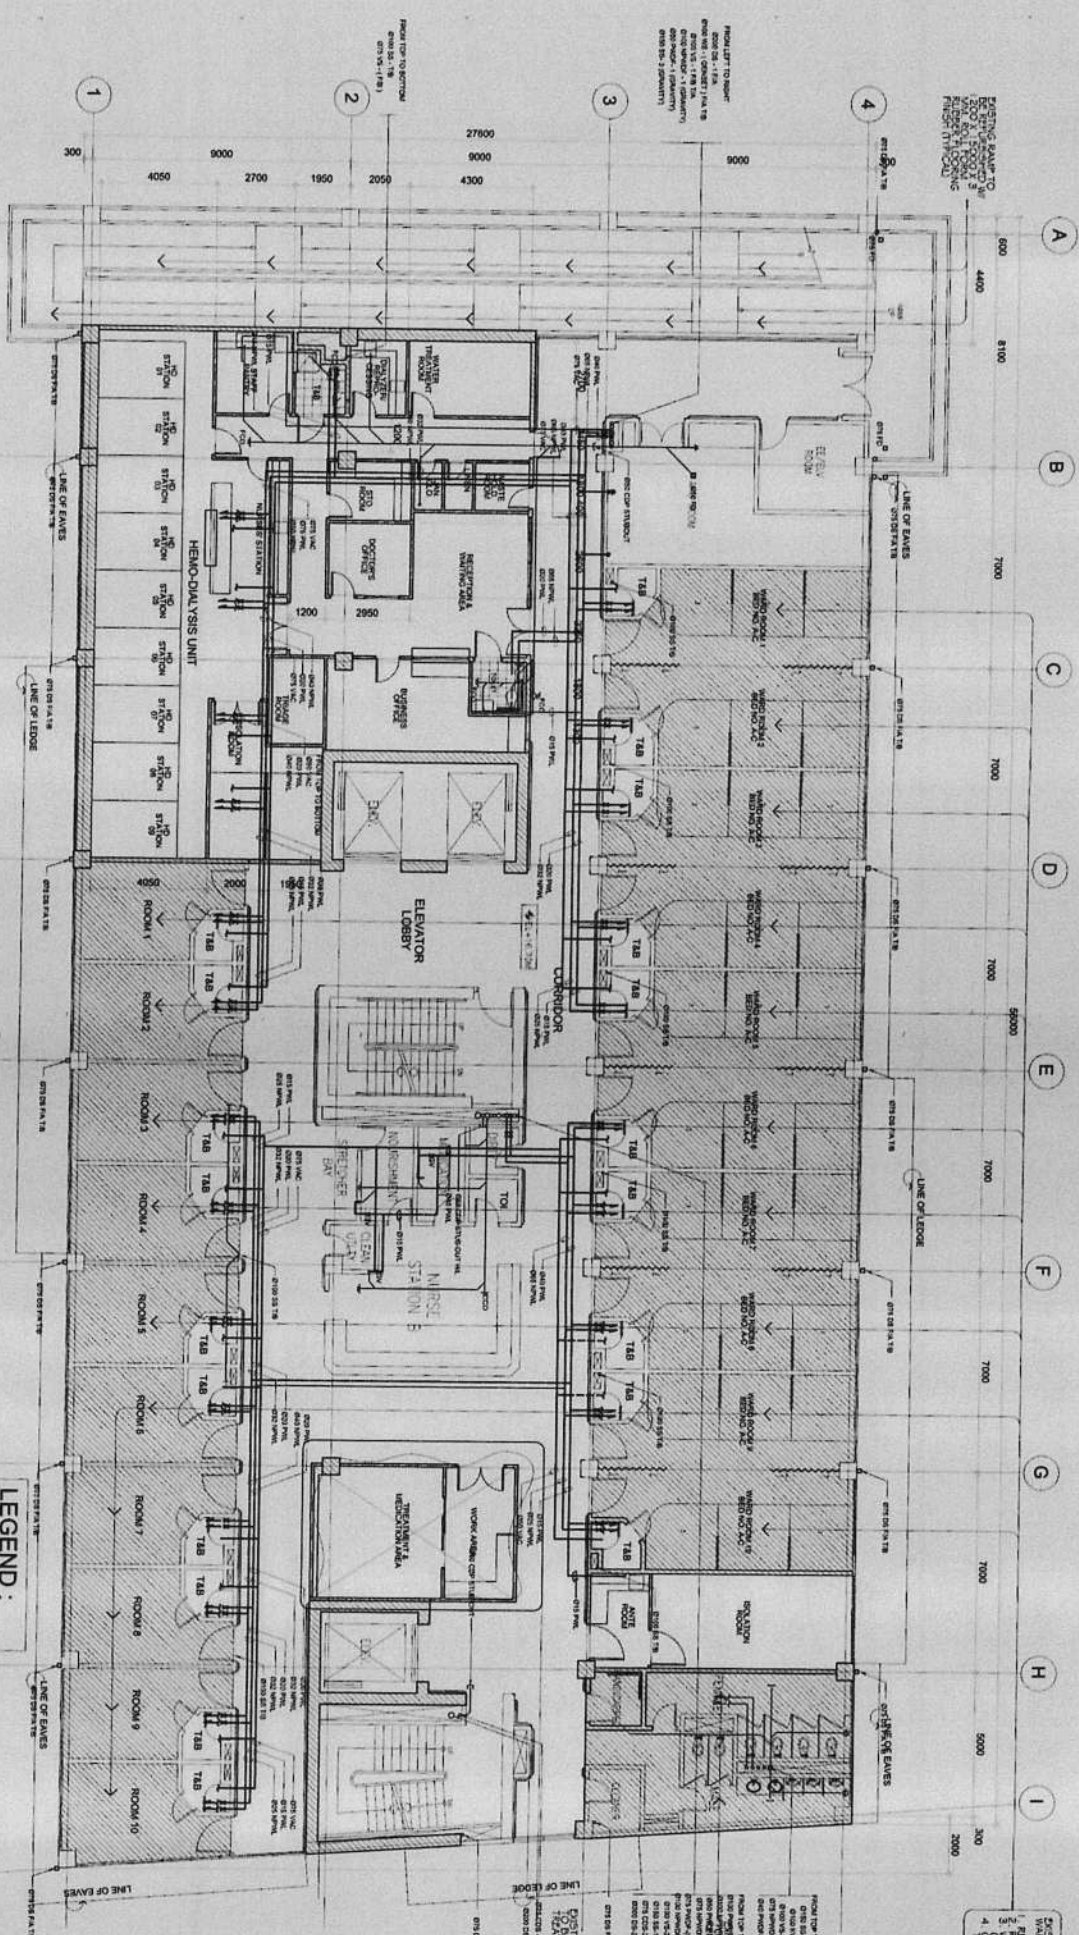

WITH PROPOSED REPAIR WORKS (SANITARY LAYOUT)
 EXISTING FIFTH FLOOR PLAN
 01 SCALE
 1:480 MM

LEGEND:

	EXISTING CHIB WALL
	NEW CHIB WALL
	EXISTING CHIB PANEL
	NEW CHIB PANEL
	EXISTING CHIB WALL TO BE DEMOLISHED

REPAIRS SHALL BE DONE IN ACCORDANCE WITH THE FOLLOWING: 1. REPAIRING OF WALLS, FLOORS & WALLS OF EXISTING FLOORS & WALLS OF EXISTING FLOORS. 2. REPAIRING OF WALLS, FLOORS & WALLS OF EXISTING FLOORS. 3. REPAIRING OF WALLS, FLOORS & WALLS OF EXISTING FLOORS. 4. REPAIRING OF WALLS, FLOORS & WALLS OF EXISTING FLOORS.



REPUBLIC OF THE PHILIPPINES
 OFFICE OF THE MAYOR
 ENGINEERING OFFICE

PROJECT TITLE:
 PROPOSED EXPANSION W/
 IMPROVEMENTS IN PASIG CITY CHILDREN'S HOSPITAL

PLANNING:
 PROJECT IN CHARGE: VINCENTE P. WILLAMOR RAMP
 ALYAN A. MARTIN RAMP


PROGRAMMING & CONSTRUCTION:
 ENGR. JAMES RAYNES
 ENGR. JUAN PEREZ

RECOMMENDING APPROVAL:
 ENGR. ARTAVERVES V. GERONIMO
 O.I.C. ENGINEERING OFFICE

APPROVED BY:
 VICTOR M.A. REGIS N. SOTTO
 CITY MAYOR

SHEET CONTENTS:
 EXISTING FIFTH FLOOR WITH PROPOSED REPAIRS
 CADD: MAMARTIN
 SHEET NO.: P 13


PROGRAM NOTES:
 1. ALL REPAIRS SHALL BE DONE IN ACCORDANCE WITH THE FOLLOWING: 1. REPAIRING OF WALLS, FLOORS & WALLS OF EXISTING FLOORS. 2. REPAIRING OF WALLS, FLOORS & WALLS OF EXISTING FLOORS. 3. REPAIRING OF WALLS, FLOORS & WALLS OF EXISTING FLOORS. 4. REPAIRING OF WALLS, FLOORS & WALLS OF EXISTING FLOORS.
 2. ALL REPAIRS SHALL BE DONE IN ACCORDANCE WITH THE FOLLOWING: 1. REPAIRING OF WALLS, FLOORS & WALLS OF EXISTING FLOORS. 2. REPAIRING OF WALLS, FLOORS & WALLS OF EXISTING FLOORS. 3. REPAIRING OF WALLS, FLOORS & WALLS OF EXISTING FLOORS. 4. REPAIRING OF WALLS, FLOORS & WALLS OF EXISTING FLOORS.
 3. ALL REPAIRS SHALL BE DONE IN ACCORDANCE WITH THE FOLLOWING: 1. REPAIRING OF WALLS, FLOORS & WALLS OF EXISTING FLOORS. 2. REPAIRING OF WALLS, FLOORS & WALLS OF EXISTING FLOORS. 3. REPAIRING OF WALLS, FLOORS & WALLS OF EXISTING FLOORS. 4. REPAIRING OF WALLS, FLOORS & WALLS OF EXISTING FLOORS.
 4. ALL REPAIRS SHALL BE DONE IN ACCORDANCE WITH THE FOLLOWING: 1. REPAIRING OF WALLS, FLOORS & WALLS OF EXISTING FLOORS. 2. REPAIRING OF WALLS, FLOORS & WALLS OF EXISTING FLOORS. 3. REPAIRING OF WALLS, FLOORS & WALLS OF EXISTING FLOORS. 4. REPAIRING OF WALLS, FLOORS & WALLS OF EXISTING FLOORS.
 5. ALL REPAIRS SHALL BE DONE IN ACCORDANCE WITH THE FOLLOWING: 1. REPAIRING OF WALLS, FLOORS & WALLS OF EXISTING FLOORS. 2. REPAIRING OF WALLS, FLOORS & WALLS OF EXISTING FLOORS. 3. REPAIRING OF WALLS, FLOORS & WALLS OF EXISTING FLOORS. 4. REPAIRING OF WALLS, FLOORS & WALLS OF EXISTING FLOORS.
 6. ALL REPAIRS SHALL BE DONE IN ACCORDANCE WITH THE FOLLOWING: 1. REPAIRING OF WALLS, FLOORS & WALLS OF EXISTING FLOORS. 2. REPAIRING OF WALLS, FLOORS & WALLS OF EXISTING FLOORS. 3. REPAIRING OF WALLS, FLOORS & WALLS OF EXISTING FLOORS. 4. REPAIRING OF WALLS, FLOORS & WALLS OF EXISTING FLOORS.

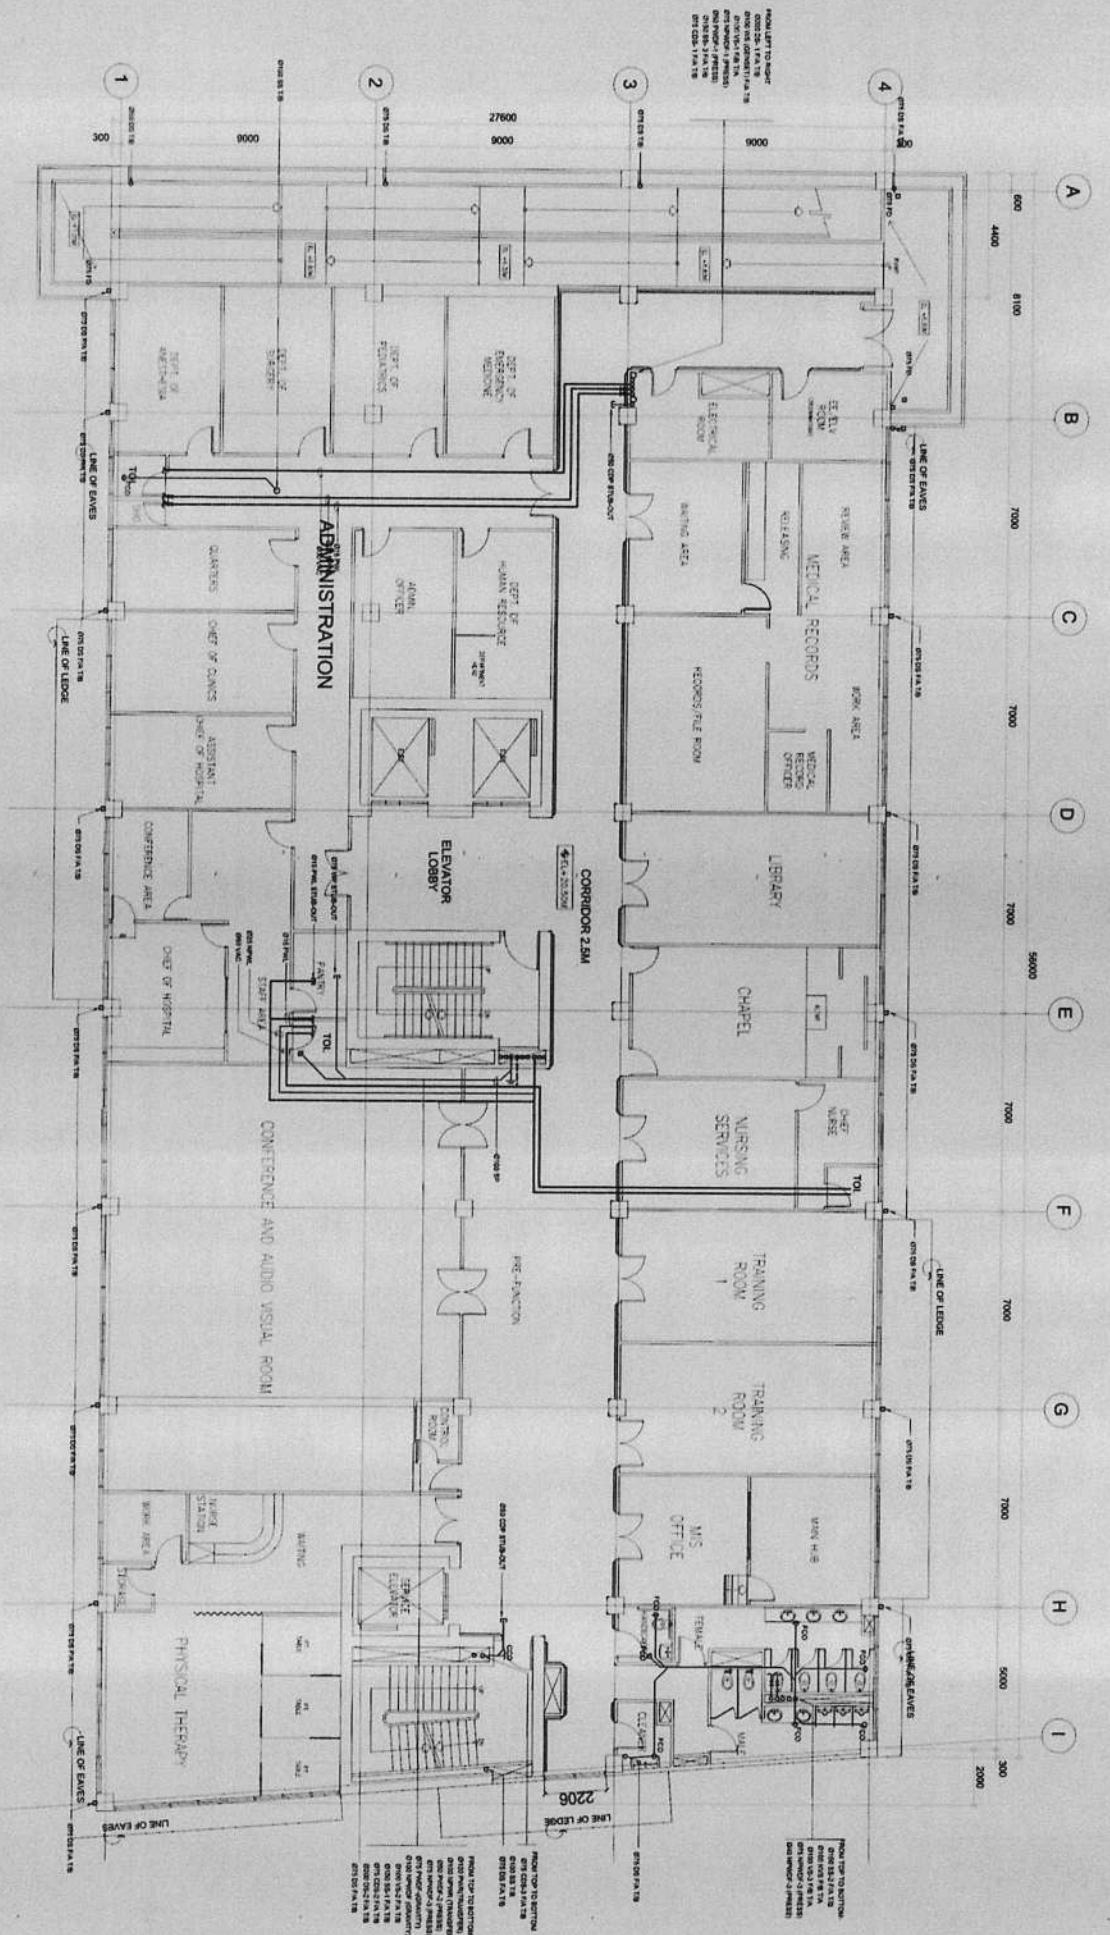


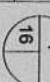
WITH PROPOSED REPAIR WORKS/SANITARY LAYOUT
 OF
 EXISTING SIXTH FLOOR PLAN
 SCALE 1:100 MAX.


	REPUBLIC OF THE PHILIPPINES CITY OF PASIG OFFICE OF THE MAYOR ENGINEERING OFFICE	PROJECT TITLE PROPOSED EXPANSION W/ IMPROVEMENT WORKS AT PASIG CITY CHILDREN'S HOSPITAL	PROJECT IN CHARGE VINCENT VILLAMOR RAMP ALYVA A. MARTIN RMP	PROGRAMMING & CONSTRUCTION: ENGR. LINDA B. RANESSES CHIEF ENGINEER	RECOMMENDING APPROVAL: ENGR. CALVIN B. THEREZ CHIEF ENGINEER	APPROVED BY: VICTOR M. REGIS N. SOTTO CITY MAYOR	SHEET NO.: P
	LOCATION: INDUSTRIAL COR. ALBUQUE JOSE STS. 1. NO. 14, 15, 16, 999, 1000	2. REVISIONS TO THE SANITARY LAYOUT SHALL BE MADE BY THE CONTRACTOR IN CONSULTATION WITH THE ENGINEER.	3. REVISIONS TO THE SANITARY LAYOUT SHALL BE MADE BY THE CONTRACTOR IN CONSULTATION WITH THE ENGINEER.	4. APPROVAL OF THIS INSTRUMENT SHALL BE CONNECTED AT THE OFFICE OF THE CONTRACTOR.	5. PROJECT & CONTRACTOR'S SEAL SHALL BE CONNECTED AT THE OFFICE OF THE CONTRACTOR.	SHEET CONTENTS: EXISTING SIXTH FLOOR WITH PROPOSED REPAIR (SANITARY LAYOUT)	SHEET NO.: 14

CONTRACTOR

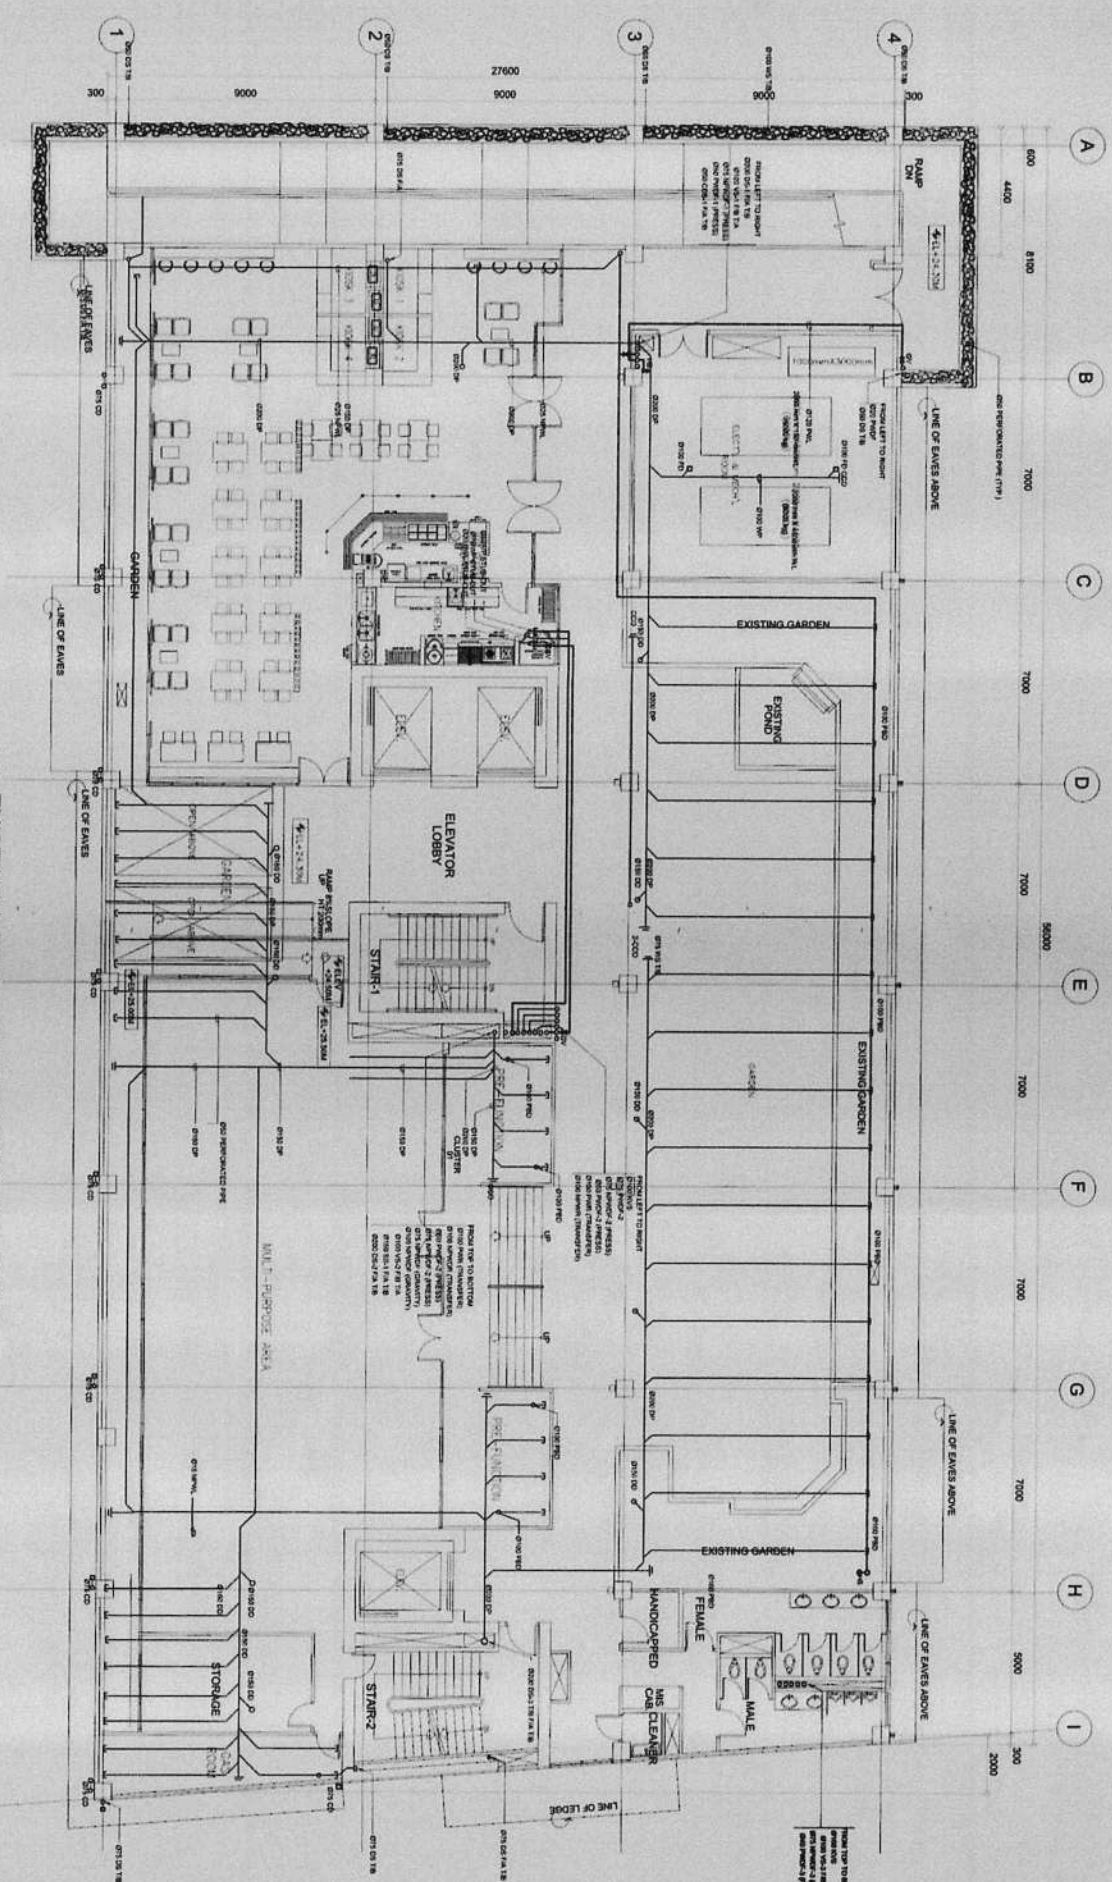

EXISTING LOWER ROOF DECK FLOOR PLAN
 SCALE 1 : 100 MM

 REPUBLIC OF THE PHILIPPINES CITY OF PASIG OFFICE OF THE MAYOR ENGINEERING OFFICE	PROJECT TITLE:	PLUMBING	PROGRAMMING & CONSTRUCTION:	RECOMMENDING APPROVAL:	APPROVED BY:	SHEET CONTENTS:	SHEET NO.:
	PROPOSED EXPANSION W/ IMPROVEMENT WORKS AT PASIG CITY CHILDRENS HOSPITAL LOCATION: PASIG CITY INDUSTRIAL COR. ALCAZAR JOSE STS. PASIG CITY	PROJECT IN CHARGE: VINCENT WILLAMOR RAMP ALDAN X MARTIN RAMP	ENGR. ISSA V. BARRALES ENGR. JUAN M. PEREZ	ENGR. ANTONIO B. PRODELICHO ENGR. ARTAVEXES V. GERONIMO	VICTOR M. REGIS N. SOTTO CITY BAYON	EXISTING LOWER ROOF DECK 16	P
REPORTING NOTES: 1. THIS DRAWING IS THE PROPERTY OF THE ENGINEERING OFFICE OF THE MAYOR, PASIG CITY. 2. IT IS TO BE USED ONLY FOR THE PROJECT AND SITE SPECIFICALLY MENTIONED HEREIN. 3. NO PART OF THIS DRAWING SHALL BE REPRODUCED OR TRANSMITTED IN ANY FORM OR BY ANY MEANS, ELECTRONIC OR MECHANICAL, WITHOUT THE WRITTEN PERMISSION OF THE ENGINEERING OFFICE OF THE MAYOR, PASIG CITY. 4. ANY MODIFICATION OR ALTERATION TO THIS DRAWING SHALL BE THE RESPONSIBILITY OF THE CONTRACTOR. 5. THIS DRAWING IS THE PROPERTY OF THE ENGINEERING OFFICE OF THE MAYOR, PASIG CITY. 6. CONTRACTOR SHALL BE RESPONSIBLE FOR THE PROTECTION OF ALL UTILITIES AND STRUCTURES TO REMAIN.	CONTRACTOR: 						

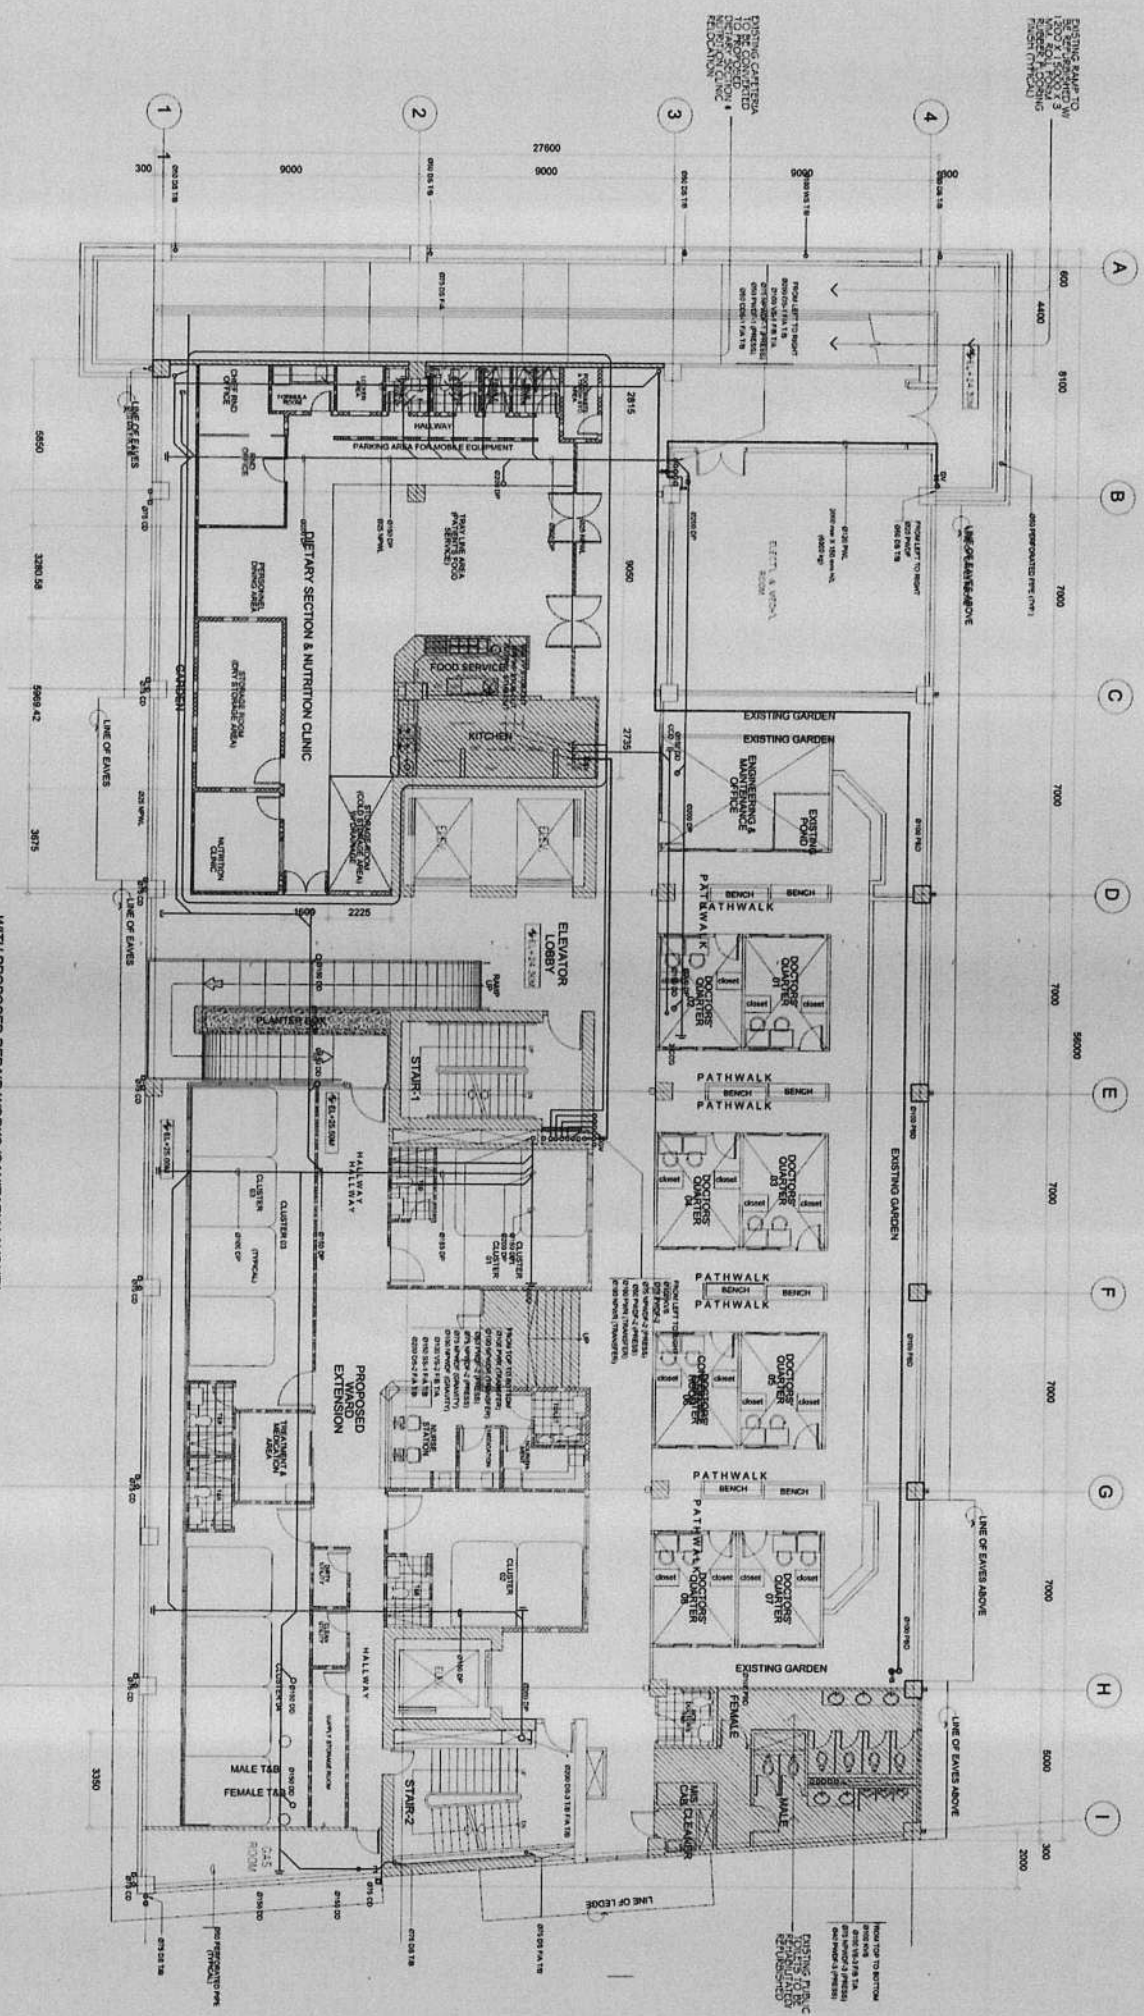


WITH PROPOSED REPAIR WORKS (SANITARY LAYOUT)
 EXISTING LOWER ROOF DECK FLOOR PLAN
 SCALE: 1:100 NIL



<p>REPUBLIC OF THE PHILIPPINES CITY OF PASIG</p> <p>OFFICE OF THE MAJOR ENGINEERING OFFICE</p>	<p>PROJECT TITLE: PROPOSED EXPANSION W/ IMPROVEMENT WORKS AT PASIG CITY CHILDREN'S HOSPITAL</p> <p>LOCATION: MARIKINA COR. VICENTE JOSE STS.</p>	<p>PLUMBING: PROJECT CHARGE: VINCENT V. WILLAMOR RMP ALAN A. MARTIN RMP</p>	<p>PROGRAMMING & CONSTRUCTION: ENGR. LEMUEL V. RAÑERES ENGR. JANNAPALLO S. BEREZ</p>	<p>RECOMMENDING APPROVAL: ENGR. WENDEL B. PRUDENCIO ENGR. ARTAVERDES V. GERONIMO</p>	<p>APPROVED BY: VICTOR M. BEGINS N. SOTTO CITY MAJOR</p>
<p>IMPORTANT NOTES:</p> <p>1. ALL REVISIONS MUST BE MADE IN ACCORDANCE WITH THE INSTRUCTIONS OF THE ARCHITECT.</p> <p>2. IN ALL CASES, THE CONTRACTOR SHALL BE RESPONSIBLE FOR THE PROTECTION AND PRESERVATION OF ALL EXISTING UTILITIES AND STRUCTURES.</p> <p>3. THE CONTRACTOR SHALL BE RESPONSIBLE FOR THE PROTECTION AND PRESERVATION OF ALL EXISTING UTILITIES AND STRUCTURES.</p> <p>4. ANY MODIFICATION OF THE INSTRUCTIONS SHALL BE CONNECTED AT THE EXPENSE OF THE CONTRACTOR.</p> <p>5. THE CONTRACTOR SHALL BE RESPONSIBLE FOR THE PROTECTION AND PRESERVATION OF ALL EXISTING UTILITIES AND STRUCTURES.</p>					
<p>SHEET CONTENTS:</p> <p>EXISTING LOWER ROOF DECK FLOOR PLAN (SANITARY LAYOUT)</p> <p>CADD: AMARTIN</p>		<p>SHEET NO.:</p> <p style="text-align: center; font-size: 2em; border: 1px solid black; border-radius: 50%; width: 40px; height: 40px; display: flex; align-items: center; justify-content: center;">P 17</p>			
<p>CONTRACTOR</p> <p>CONCEDES & ACCEPTED BY:</p>					

01
P 18
SCALE

**EXISTING
POTABLE WATER SUPPLY SYSTEM SCHEMATIC DIAGRAM**
1 : 100 I.M.L.

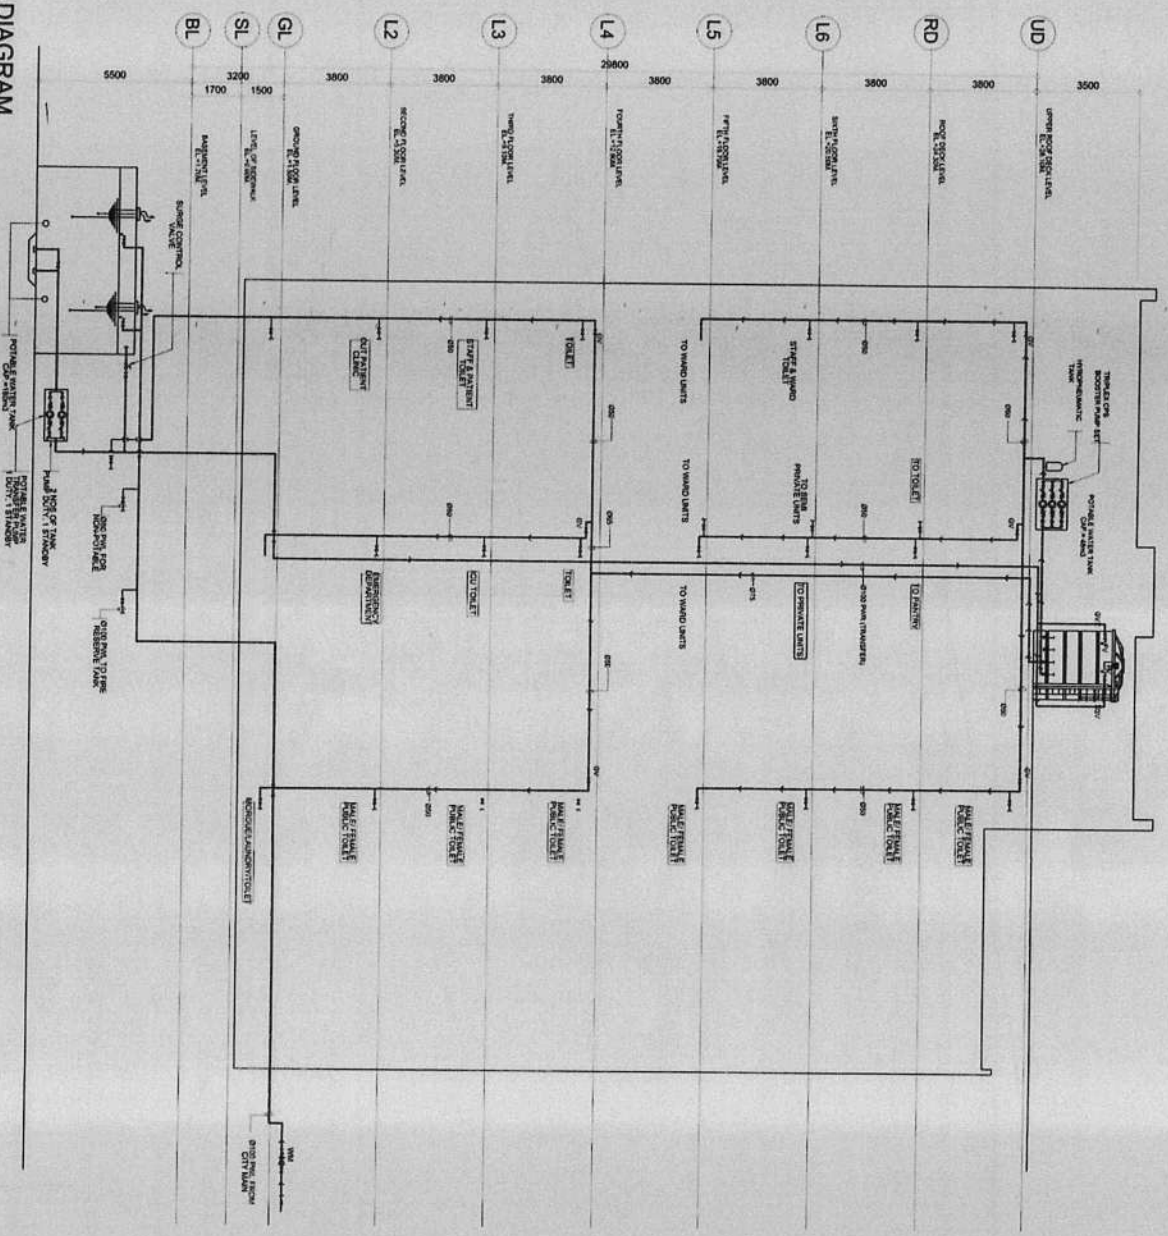


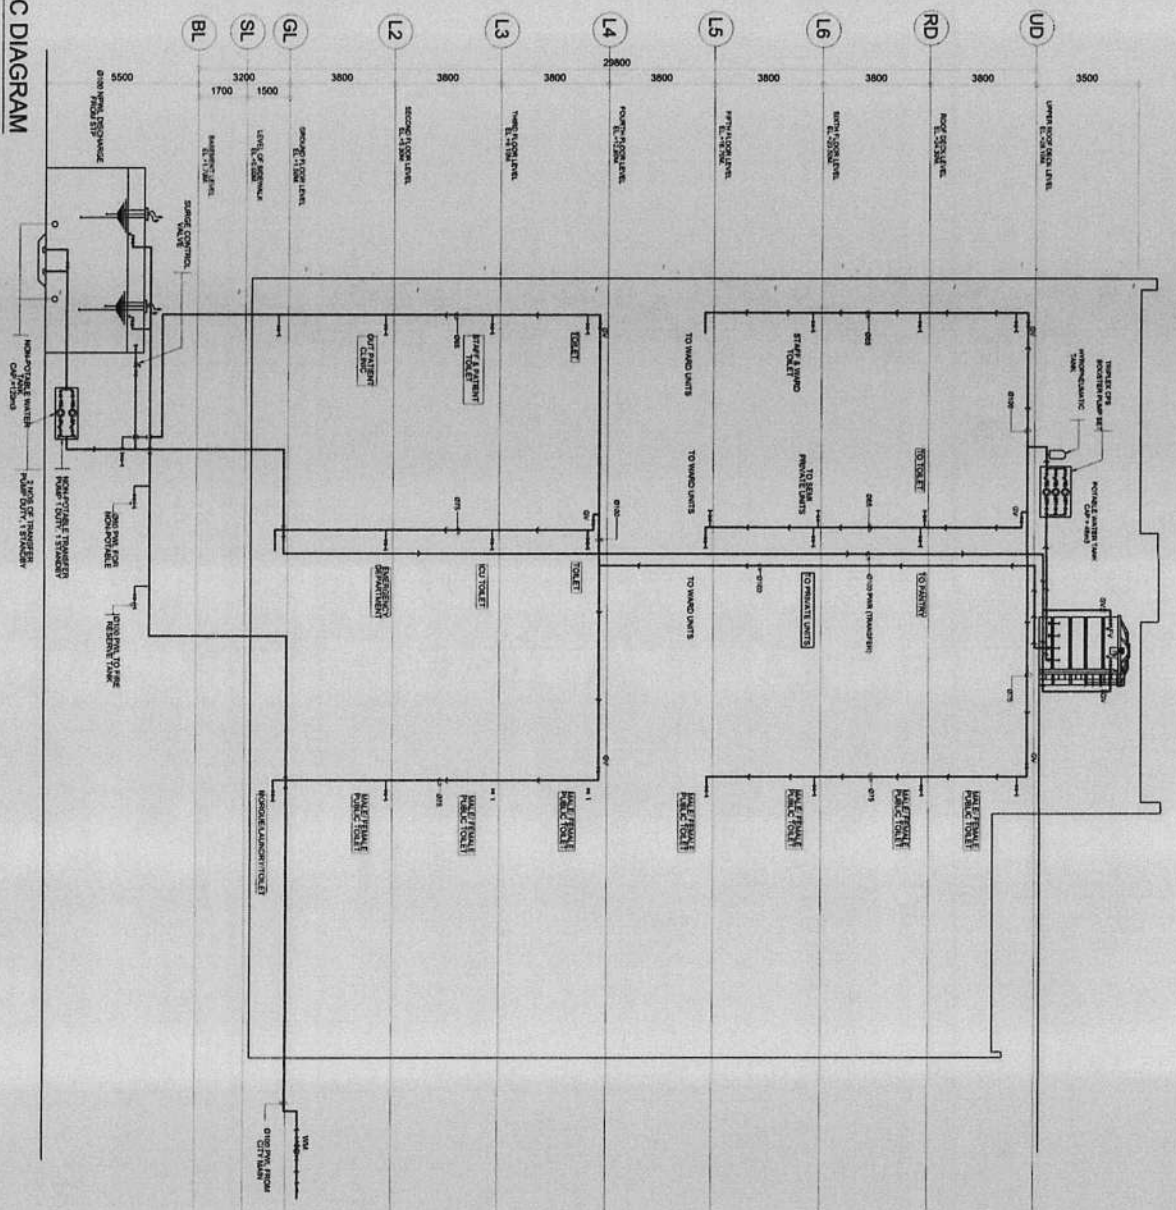
	<p>REPUBLIC OF THE PHILIPPINES CITY OF PASIG OFFICE OF THE MAYOR ENGINEERING OFFICE</p>	<p>PROJECT TITLE: PROPOSED EXPANSION W/ IMPROVEMENT WORKS AT PASIG CITY CHILDREN'S HOSPITAL</p> <p>LOCATION: INDUSTRIAL COR. ALDOPE JOSE STS. NO. 100, INDUSTRIAL COR. ALDOPE JOSE STS. PASIG CITY, METRO MANILA</p>	<p>PLUMBING: PROJECT N. CHAVEZ VINCENT V. VILLAMOR RUP ALLAN A. MARTIN RUP</p>	<p>PROGRAMMING & CONSTRUCTION: ENGR. GREG V. RANESSES ENGR. MARK PEREZ</p>	<p>RECOMMENDING APPROVAL: ENGR. ROBERTO B. PRIDDENCIO ENGR. ARTAYRAXES V. GERONIMO</p>	<p>APPROVED BY: VICTOR MA. REGIS N. SOTTO CITY MANOR</p>	<p>SHEET CONTENTS: EXISTING POTABLE WATER SUPPLY SYSTEM SCHEMATIC DIAGRAM</p>	<p>SHEET NO.: P 18</p>
--	---	---	--	--	--	--	---	--------------------------------

IMPORTANT NOTES:
1. NO ALTERATION IN PLAN & SPECIFICATIONS SHALL BE MADE WITHOUT THE WRITTEN PERMISSION OF THE ARCHITECT.
2. IN ANY CASE, THE CONTRACTOR SHALL BE RESPONSIBLE FOR THE PROTECTION OF THE EXISTING UTILITIES.
3. A 50% PROVISIONAL ALLOWANCE SHALL BE MAINTAINED FOR UNANTICIPATED WORKS.
4. ANY VARIATION OF THIS SPECIFICATION SHALL BE CONNECTED AT THE DISCRETION OF THE CONTRACTOR.

CONTRACTOR

01
P-19
SCALE
**EXISTING
NON-POTABLE WATER SUPPLY SYSTEM SCHEMATIC DIAGRAM**
1 : 100 MM

	REPUBLIC OF THE PHILIPPINES CITY OF PASIG OFFICE OF THE MAJOR ENGINEERING OFFICE	PROJECT TITLE: PROPOSED EXPANSION W/ IMPROVEMENT WORKS AT PASIG CITY CHILDREN'S HOSPITAL	PROJECT NO. CHARGE: VINCENTY VILLAMOR RMP ALMA N. MARTIN RMP	PROGRAMMING & CONSTRUCTION: ENGR. J. V. BARRALES ENGR. J. M. PEREZ	RECOMMENDING APPROVAL: ENGR. E. B. PRUDENCIO ENGR. ARTAVARRIS V. GERONIMO	APPROVED BY: VICTOR MA. REGIS N. SOTTO CITY MAJOR	SHEET CONTENTS: EXISTING NON-POTABLE WATER SUPPLY SYSTEM	SHEET NO.: 19 P
	IMPORTANT NOTES: 1. NO. 1. ALL WORK SHALL BE DONE IN ACCORDANCE WITH THE CITY ENGINEERING DEPARTMENT'S STANDARDS AND SPECIFICATIONS. 2. ALL WORK SHALL BE DONE IN ACCORDANCE WITH THE CITY ENGINEERING DEPARTMENT'S STANDARDS AND SPECIFICATIONS. 3. ALL WORK SHALL BE DONE IN ACCORDANCE WITH THE CITY ENGINEERING DEPARTMENT'S STANDARDS AND SPECIFICATIONS. 4. ALL WORK SHALL BE DONE IN ACCORDANCE WITH THE CITY ENGINEERING DEPARTMENT'S STANDARDS AND SPECIFICATIONS. 5. ALL WORK SHALL BE DONE IN ACCORDANCE WITH THE CITY ENGINEERING DEPARTMENT'S STANDARDS AND SPECIFICATIONS. 6. ALL WORK SHALL BE DONE IN ACCORDANCE WITH THE CITY ENGINEERING DEPARTMENT'S STANDARDS AND SPECIFICATIONS.		LOCATION: PASIG CITY CHILDREN'S HOSPITAL PLUMBING:		RECOMMENDING APPROVAL: ENGR. E. B. PRUDENCIO ENGR. ARTAVARRIS V. GERONIMO		APPROVED BY: VICTOR MA. REGIS N. SOTTO CITY MAJOR	





REPUBLIC OF THE PHILIPPINES
CITY OF PASIG
OFFICE OF THE MAYOR
ENGINEERING OFFICE

PROJECT TITLE:
**PROPOSED EXPANSION W/
IMPROVEMENT WORKS AT
PASIG CITY CHILDREN'S HOSPITAL**

PLUMBING
PROJECT IN CHARGE
VINCENT WILLAMOR RAMP
ALJAN A. MARTIN RAMP

















PROGRAMMING & CONSTRUCTION:
ENGR. ISABELA RANERES
ENGR. JUAN CARLOS PEREZ

RECOMMENDING APPROVAL:
ENGR. JUAN B. PRUDENCIO
ENGR. ARTAVERDES V. GERONIMO

APPROVED BY:
VICTOR MA. REGIS N. SOTTO
CITY MAYOR

SHEET CONTENTS:
SHEET NO.:
20

IMPORTANT NOTES:
1. NO ALTERATION IN SCALE & REFERENCE TO SHEETS SHALL BE MADE WITHOUT THE WRITTEN PERMISSION OF THE ARCHITECT.
2. IN CASE OF CONFLICT BETWEEN THE ARCHITECT'S AND ENGINEER'S REQUIREMENTS, THE ARCHITECT'S SHALL PREVAIL.
3. IN CASE OF DISCREPANCY IN THE DRAWINGS, THE ARCHITECT'S SHALL PREVAIL.
4. ALL DIMENSIONS OF THIS DRAWING SHALL BE IN METERS UNLESS OTHERWISE SPECIFIED.
5. THE CONTRACTOR SHALL BE RESPONSIBLE FOR OBTAINING ALL NECESSARY PERMITS AND APPROVALS FROM THE APPROPRIATE AGENCIES.
6. THE CONTRACTOR SHALL BE RESPONSIBLE FOR OBTAINING ALL NECESSARY PERMITS AND APPROVALS FROM THE APPROPRIATE AGENCIES.

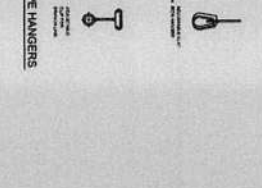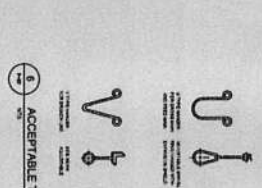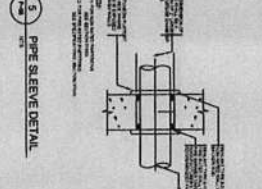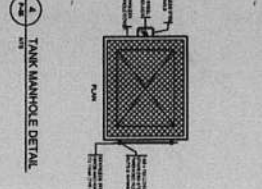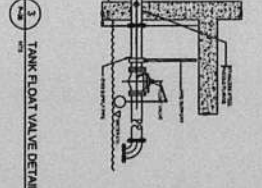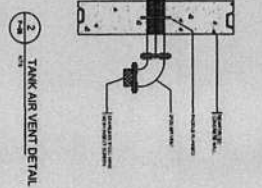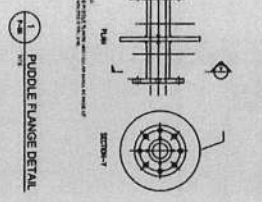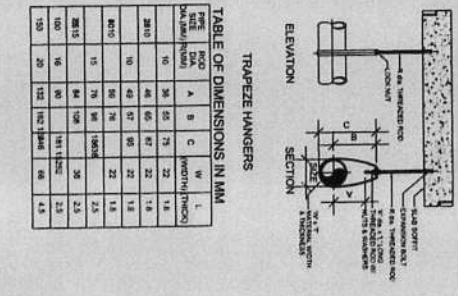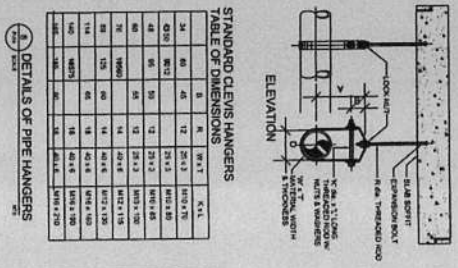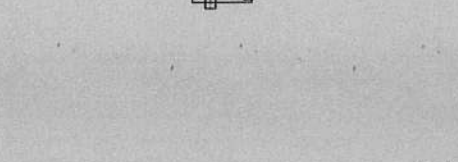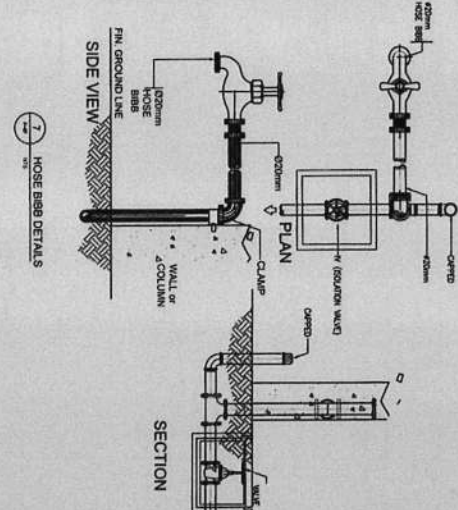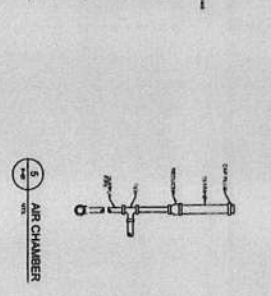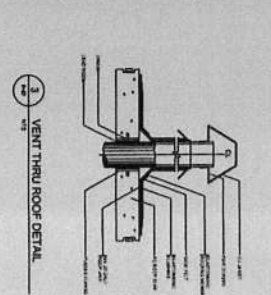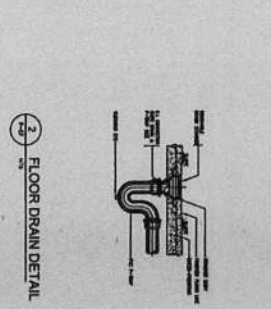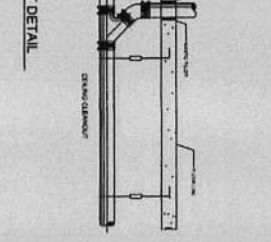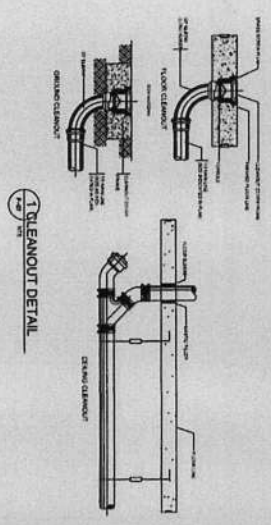



LUNGSOD NG
PASIG
UMAABOS ANG PAG-ASA

CITY ENGINEERING OFFICE

Form No. : _____
Date : _____
Page No. : 1 OF 25

Name of Project : **PROPOSED EXPANSION W/ IMPROVEMENT WORKS AT PASIG CITY CHILDREN'S HOSPITAL**
Location : **INDUSTRIA COR. ALCALDE JOSE STS., KAPASIGAN, PASIG CITY**
Source of Funds : _____
Obligated Author : _____
Calendar Days to Complete : **600 CD**
Desirable Starting Date : _____

MINIMUM EQUIPMENT REQUIREMENT			
DESCRIPTION	NO.	DESCRIPTION	NO.

TECHNICAL PERSONNEL REQUIRED			
DESCRIPTION	NO.	DESCRIPTION	NO.

ESTIMATED COST OF PROPOSED WORK:

ITEM NO.	DESCRIPTION	% WT	QUANTITY	UNIT	UNIT COST	AMOUNT
1.0	MOBILIZATION / DEMOBILIZATION	0.95%	1.00	lot		
2.0	PRELIMINARIES					
	- Bunkhouse / Temporary Facilities		250.00	sq.m		
	- Temporary Barricades and Protection Net		560.00	lm		
	- Occupational Safety and Health Program		20.00	mos.		
		0.70%				
3.0	REPAIR AND IMPROVEMENT AT BASEMENT					
	- Waterproofing		29.00	sq.m		
	- M2 Panel PSM 80 including dowel		130.00	sq.m		
	- Shotcrete Cement Plaster		260.00	sq.m		
	- Rollup Door		8.40	sq.m		
	- Solid Surface Plate Countertop and Splash Board including under cabinet		3.30	sq.m		
	- Painting of Walls and Ceiling		3,515.00	sq.m		
	- Rental of H-frame		1,054.50	sq.m		
	- Industrial Powerfloor self levelling compound (Epoxy Resin Floor Finish)		1,422.00	sq.m		
		1.90%				
4.0	REPAIR AND IMPROVEMENT AT RAMP					
	- Painting of Walls and Ceiling		2,681.00	sq.m		
	- Rental of H-Frame		804.30	sq.m		
	- 300x300mmx4mm thk Non-skid rubber tiles		730.00	sq.m		
		1.16%				
5.0	REPAIR AND IMPROVEMENT AT GROUND FLOOR					
	- Removal and hauling of Existing Flooring		1,118.00	sq.m		
	- 2mm Homogenous Anti-bacterial Vinyl Roll		1,118.00	sq.m		
	- Cove Former		994.00	lm		
	- Capping Strip		994.00	lm		
	- Self Levelling Compound		1,118.00	sq.m		
	- Demolition and Hauling of Existing wall partition		342.00	sq.m		
	- M2 Panel PSM 80 including dowel		375.00	sq.m		
	- Shotcrete Cement Plaster		750.00	sq.m		
	- 12mm Ficemboard on Metal Frame Double Wall Partition		66.50	sq.m		
	- Painting of Walls		2,980.00	sq.m		
	- Dismantling and hauling of Dilapidated and affected Ceiling		1,391.00	sq.m		
	- Ceiling including hangers and Metal Framing		1,391.00	sq.m		
	- Painting of Ceiling		1,391.00	sq.m		
	- Rental of H-frame		894.00	sq.m		
	- Plain Cement Floor Finish (Driveway)		400.00	sq.m		
	- Chipping and hauling of Existing Floor Finish at Driveway		400.00	sq.m		
	ADMITTING COUNTERS					
	- Built-up separator duco finish on metal framing		6.75	sq.m		
	- 0.8m Built-up Overhead Cabinet		4.20	lm		
	- Two Seater Modular Type Workstation – Two-Tone Fabric Finished in in 2mm PVC edge band Office partitions in 45mm thick aluminum trims with 25mm thick board Melamine Finish		1.00	set		
	FINANCE DEPARTMENT					
	- Built-up separator duco finish on metal framing		7.35	sq.m		
	- 8mm Thk Acrylic Glass Separator		7.20	sq.m		
	- 0.8m Built-up Overhead Cabinet		38.10	lm		
	- One Seater Modular Type Workstation – Two-Tone Fabric Finished in in 2mm PVC edge band Office partitions in 45mm thick aluminum trims with 25mm thick board Melamine Finish		3.00	sets		





Name of Project : PROPOSED EXPANSION W/ IMPROVEMENT WORKS AT PASIG CITY CHILDREN'S HOSPITAL
Location : INDUSTRIA COR. ALCALDE JOSE STS., KAPASIGAN, PASIG CITY

ESTIMATED COST OF PROPOSED WORK:

ITEM NO.	DESCRIPTION	% WT	QUANTITY	UNIT	UNIT COST	AMOUNT
	- One Seater Modular L- Type Workstation – Two-Tone Fabric Finished in 2mm PVC edge band Office partitions in 45mm thick aluminum trims with 25mm thick board Melamine Finish		7.00	sets		
	- One Seater Modular L- Type (1.5x2x1.2) Workstation – Two-Tone Fabric in 2mm PVC edge band Office partitions in 45mm thick aluminum trims with 25mm thick board Melamine Finish		2.00	sets		
	- Four Seater Modular Type Workstation – Two-Tone Fabric Finished in 2mm PVC edge band Office partitions in 45mm thick aluminum trims with 25mm thick board Melamine Finish		1.00	set		
	- Two Seater Modular Type Workstation – Two-Tone Fabric Finished in 2mm PVC edge band Office partitions in 45mm thick aluminum trims with 25mm thick board Melamine Finish		2.00	set		
	EMERGENCY ROOM					
	STAFF PANTRY AND ANTE ROOM					
	- Solid Surface Plate Countertop and Splash Board including under cabinet		4.44	sq.m		
	- 1.4m Built-up Overhead Cabinet		38.10	lm		
	PRIMARY CARE, ISOLATION AND WAITING AREA TOILET					
	- Waterproofing		17.42	sq.m		
	- 30x30 cm Vitr. Ceramic Tiles		46.50	sq.m		
	PHARMACY					
	- Solid Surface Plate Countertop and Splash Board including under cabinet		5.60	sq.m		
	- Waterproofing		361.00	sq.m		
	SOCIAL SERVICE SECTION					
	- Built-up separator duco finish on metal framing		4.50	sq.m		
	- 0.8m Built-up Overhead Cabinet		5.30	lm		
	- Waterproofing		2.13	sq.m		
	- 30x30 cm Vitr. Ceramic Tiles		8.33	sq.m		
		3.41%				
6.0	REPAIR AND IMPROVEMENT WORK AT SECOND FLOOR					
	- Removal and hauling of Existing Flooring		1,151.00	sq.m		
	- 2mm Homogenous Anti-bacterial Vinyl Roll		1,151.00	sq.m		
	- Cove Former		1,023.00	lm		
	- Capping Strip		1,023.00	lm		
	- Self Levelling Compound		1,151.00	sq.m		
	- Demolition and Hauling of Existing wall partition		793.00	sq.m		
	- M2 Panel PSM 80 including dowel		1,096.00	sq.m		
	- Shotcrete Cement Plaster		2,192.00	sq.m		
	- Painting of Walls		3,069.00	sq.m		
	- Dismantling and hauling of Dilapidated and affected Ceiling		1,344.00	sq.m		
	- Ceiling including hangers and Metal Framing		1,344.00	sq.m		
	- Painting of Ceiling		1,344.00	sq.m		
	- Rental of H-frame		921.00	sq.m		
	- Handrail with PVC Cover and aluminum Retainer including wall panel		107.00	lm		
	- End Cap (Left/Right)		43.00	pcs		
	- Butt Joint		30.00	pcs		
	- TB Dots Room and Connector Bridge		25.00	sq.m		
	LEDGE AND CANOPY					
	- Waterproofing		280.60	sq.m		
	- Concrete Topping		280.60	sq.m		
	- Stainless Steel Gutter (304) Ga. 25		10.00	lm		
	- 75mmØ Gutter Drain with Strainer		2.00	sets		
	- Chipping and hauling of Existing concrete ledge		4.00	sq.m		
	- 6mm Stainless plate with 4-16mmØ Anchor Bolt		12.00	sets		
	NEONATAL ICU					
	- Built-up Nurse's Station		4.60	lm		
	- Solid Surface Plate Countertop and Splash Board including under cabinet		14.80	sq.m		
	- 1.4m Built-up Overhead Cabinet		3.20	lm		
	RECOVERY ROOM					
	- Built-up Nurse's Station		3.00	lm		



Name of Project : PROPOSED EXPANSION W/ IMPROVEMENT WORKS AT PASIG CITY CHILDREN'S HOSPITAL
 Location : INDUSTRIA COR. ALCALDE JOSE STS., KAPASIGAN, PASIG CITY

ESTIMATED COST OF PROPOSED WORK:

ITEM NO.	DESCRIPTION	% WT	QUANTITY	UNIT	UNIT COST	AMOUNT
	PEDIATRIC ICU					
	- Solid Surface Plate Countertop and Splash Board including under cabinet		8.10	sq.m		
	- 1.4m Built-up Overhead Cabinet		5.10	lm		
	- Built-up Nurse's Station		4.90	lm		
	- Waterproofing		6.60	sq.m		
	- 30x30 cm Vitr. Ceramic Tiles		17.25	sq.m		
	MEDICAL ICU					
	- Solid Surface Plate Countertop and Splash Board including under cabinet		12.00	sq.m		
	- 1.4m Built-up Overhead Cabinet		6.70	lm		
	- Built-up Nurse's Station		3.80	lm		
	- Waterproofing		6.40	sq.m		
	- 30x30 cm Vitr. Ceramic Tiles		16.70	sq.m		
	LABOR ROOM AND HIGH PREGNANCY UNIT					
	- Solid Surface Plate Countertop and Splash Board including under cabinet		1.10	sq.m		
	- 2" Stainless Steel Curtain Partition hanger		32.00	lm		
	- Waterproofing		4.90	sq.m		
	- 30x30 cm Vitr. Ceramic Tiles		13.60	sq.m		
	SUB-STERILE					
	- Solid Surface Plate Countertop and Splash Board including under cabinet		9.50	sq.m		
	- 1.4m Built-up Overhead Cabinet		11.20	lm		
	DELIVERY ROOM					
	- 2" Stainless Steel Curtain Partition hanger		24.00	lm		
		4.69%				
7.0	REPAIR AND IMPROVEMENT WORK AT THIRD FLOOR					
	- Removal and hauling of Existing Flooring		1,078.00	sq.m		
	- 2mm Homogenous Anti-bacterial Vinyl Roll		1,078.00	sq.m		
	- Cove Former		1,136.00	lm		
	- Capping Strip		1,136.00	lm		
	- Self Levelling Compound		1,078.00	sq.m		
	- Demolition and Hauling of Existing wall partition		409.00	sq.m		
	- M2 Panel PSM 80 including dowel		598.30	sq.m		
	- Shotcrete Cement Plaster		1,196.60	sq.m		
	- Painting of Walls		3,407.00	sq.m		
	- Dismantling and hauling of Dilapidated and affected Ceiling		1,341.00	sq.m		
	- Ceiling including hangers and Metal Framing		1,341.00	sq.m		
	- Painting of Ceiling		1,341.00	sq.m		
	- Rental of H-frame		1,022.00	sq.m		
	- Handrail with PVC Cover and aluminum Retainer including wall panel		95.70	lm		
	- End Cap (Left/Right)		38.00	pcs		
	- Butt Joint		27.00	pcs		
	LEDGE AND CANOPY					
	- Waterproofing		169.00	sq.m		
	- Concrete Topping		169.00	sq.m		
	WCPU AND WAITING AREA TOILET					
	- Waterproofing		10.20	sq.m		
	- 30x30 cm Vitr. Ceramic Tiles		26.40	sq.m		
	- Floor Topping (Raised Flooring)		5.50	sq.m		
	CLINICAL LABORATORY					
	RECEPTION AND WAITING AREA TOILET					
	- Waterproofing		6.60	sq.m		
	- 30x30 cm Vitr. Ceramic Tiles		17.30	sq.m		
	EXTRACTION AREA					
	- Solid Surface Plate Countertop and Splash Board including under cabinet		2.30	sq.m		
	HALLWAY					
	- Solid Surface Plate Countertop and Splash Board including under cabinet		1.50	sq.m		
	RECEIVING/RELEASING OF SPECIMEN/RESULT ROOM					
	- 1.4m Built-up Overhead Cabinet		1.20	lm		



Name of Project : PROPOSED EXPANSION W/ IMPROVEMENT WORKS AT PASIG CITY CHILDREN'S HOSPITAL
Location : INDUSTRIA COR. ALCALDE JOSE STS., KAPASIGAN, PASIG CITY

ESTIMATED COST OF PROPOSED WORK:

ITEM NO.	DESCRIPTION	% WT	QUANTITY	UNIT	UNIT COST	AMOUNT
	CLINICAL MICROSCOPY SECTION					
	- Solid Surface Plate Countertop and Splash Board including under cabinet		10.00	sq.m		
	- 1.4m Built-up Overhead Cabinet		7.00	lm		
	HEMATOLOGY SECTION					
	- Solid Surface Plate Countertop and Splash Board including under cabinet		12.80	sq.m		
	- 1.4m Built-up Overhead Cabinet		3.30	lm		
	CLINICAL CHEMISTRY SECTION AND IMMUNOLOGY/SEROLOGY					
	- Solid Surface Plate Countertop and Splash Board including under cabinet		10.00	sq.m		
	- 1.4m Built-up Overhead Cabinet		6.70	lm		
	STERILIZATION					
	- Solid Surface Plate Countertop and Splash Board including under cabinet		4.40	sq.m		
	- 1.4m Built-up Overhead Cabinet		5.50	lm		
	STAFF PANTRY					
	- Solid Surface Plate Countertop and Splash Board including under cabinet		1.50	sq.m		
	- 1.4m Built-up Overhead Cabinet		2.40	lm		
	EMERGENCY SHOWER					
	- Waterproofing		2.20	sq.m		
	- 30x30 cm Vitr. Ceramic Tiles		6.40	sq.m		
	LOCKER ROOM TOILET					
	- Waterproofing		6.40	sq.m		
	- 30x30 cm Vitr. Ceramic Tiles		18.00	sq.m		
	HISTOPATHOLOGY					
	- Solid Surface Plate Countertop and Splash Board including under cabinet		8.60	sq.m		
	- 1.4m Built-up Overhead Cabinet		7.40	lm		
	MICROBIOLOGY					
	- Solid Surface Plate Countertop and Splash Board including under cabinet		5.80	sq.m		
	- 1.4m Built-up Overhead Cabinet		4.90	lm		
	DECONTAMINATION ROOM					
	- Solid Surface Plate Countertop and Splash Board including under cabinet		1.10	sq.m		
	- 1.4m Built-up Overhead Cabinet		2.00	lm		
	MEDIA PREP. ROOM					
	- Solid Surface Plate Countertop and Splash Board including under cabinet		1.90	sq.m		
	- 1.4m Built-up Overhead Cabinet		4.30	lm		
	MOLECULAR LAB PANTRY					
	- Solid Surface Plate Countertop and Splash Board including under cabinet		1.20	sq.m		
	- 1.4m Built-up Overhead Cabinet		1.30	lm		
	BLOOD BANK UNIT					
	- Built-up Reception Counter		2.70	lm		
	TOILET					
	- Waterproofing		6.40	sq.m		
	- 30x30 cm Vitr. Ceramic Tiles		16.70	sq.m		
	DONOR EXTRACTION AREA					
	- 2" Stainless Steel Curtain Partition hanger		10.00	lm		
	BB PROCESSING					
	- Solid Surface Plate Countertop and Splash Board including under cabinet		5.50	sq.m		
	- 1.4m Built-up Overhead Cabinet		2.00	lm		
		3.97%				
8.0	REPAIR AND IMPROVEMENT WORK AT FOURTH FLOOR					
	- Removal and hauling of Existing Flooring		1,122.00	sq.m		
	- 2mm Homogenous Anti-bacterial Vinyl Roll		1,128.00	sq.m		
	- Cove Former		900.00	lm		
	- Capping Strip		900.00	lm		





Name of Project : PROPOSED EXPANSION W/ IMPROVEMENT WORKS AT PASIG CITY CHILDREN'S HOSPITAL
Location : INDUSTRIA COR. ALCALDE JOSE STS., KAPASIGAN, PASIG CITY

ESTIMATED COST OF PROPOSED WORK:

ITEM NO.	DESCRIPTION	% WT	QUANTITY	UNIT	UNIT COST	AMOUNT
	- Self Levelling Compound		1,122.00	sq.m		
	- Demolition and Hauling of Existing wall partition		54.80	sq.m		
	- M2 Panel PSM 80 including dowel		170.00	sq.m		
	- Shotcrete Cement Plaster		340.00	sq.m		
	- Painting of Walls		2,700.00	sq.m		
	- Dismantling and hauling of Dilapidated and affected Ceiling		1,392.00	sq.m		
	- Ceiling including hangers and Metal Framing		1,392.00	sq.m		
	- Painting of Ceiling		1,392.00	sq.m		
	- Rental of H-frame		810.00	sq.m		
	- Handrail with PVC Cover and aluminum Retainer including wall panel		138.00	lm		
	- End Cap (Left/Right)		65.00	pcs		
	- Butt Joint		39.00	pcs		
	- Waterproofing/Damproofing		1,995.00	sq.m		
	LEDGE AND CANOPY					
	- Waterproofing		162.60	sq.m		
	- Concrete Topping		162.60	sq.m		
	T&B					
	- Removal and hauling of Tiles		258.80	sq.m		
	- Waterproofing		92.50	sq.m		
	- 30x30 cm Vitr. Ceramic Tiles		258.80	sq.m		
	WARD EXTENSION					
	- Varifold Door		16.70	sq.m		
	- 2" Stainless Steel Curtain Partition hanger		8.00	lm		
	- Solid Surface Plate Countertop and Splash Board including under cabinet		1.60	sq.m		
	- 1.4m Built-up Overhead Cabinet		1.70	lm		
	NURSE STATION A					
	- Solid Surface Plate Countertop and Splash Board including under cabinet		7.00	sq.m		
	- 1.4m Built-up Overhead Cabinet		6.80	lm		
	T&B					
	- Waterproofing		8.70	sq.m		
	- 30x30 cm Vitr. Ceramic Tiles		21.60	sq.m		
	TREATMENT MEDICATION AREA					
	- Solid Surface Plate Countertop and Splash Board including under cabinet		0.80	sq.m		
		3.88%				
9.0	REPAIR AND IMPROVEMENT WORK AT FIFTH FLOOR					
	- Removal and hauling of Existing Flooring		1,078.00	sq.m		
	- 2mm Homogenous Anti-bacterial Vinyl Roll		1,078.00	sq.m		
	- Cove Former		886.00	lm		
	- Capping Strip		886.00	lm		
	- Self Levelling Compound		1,078.00	sq.m		
	- Demolition and Hauling of Existing wall partition		284.00	sq.m		
	- M2 Panel PSM 80 including dowel		438.00	sq.m		
	- Shotcrete Cement Plaster		876.00	sq.m		
	- 12mm Ficeboard on Metal Frame Double Wall Partition		16.00	sq.m		
	- Painting of Walls		2,659.00	sq.m		
	- Dismantling and hauling of Dilapidated and affected Ceiling		1,392.00	sq.m		
	- Ceiling including hangers and Metal Framing		1,392.00	sq.m		
	- Painting of Ceiling		1,392.00	sq.m		
	- Rental of H-frame		797.70	sq.m		
	- Handrail with PVC Cover and aluminum Retainer including wall panel		108.00	lm		
	- End Cap (Left/Right)		51.00	pcs		
	- Butt Joint		31.00	pcs		
	- Waterproofing/Damproofing		1,483.50	sq.m		
	LEDGE AND CANOPY					
	- Waterproofing		152.20	sq.m		
	- Concrete Topping		152.20	sq.m		
	T&B					
	- Removal and hauling of Tiles		287.60	sq.m		
	- Waterproofing		102.80	sq.m		



Name of Project : PROPOSED EXPANSION W/ IMPROVEMENT WORKS AT PASIG CITY CHILDREN'S HOSPITAL
Location : INDUSTRIA COR. ALCALDE JOSE STS., KAPASIGAN, PASIG CITY

ESTIMATED COST OF PROPOSED WORK:

ITEM NO.	DESCRIPTION	% WT	QUANTITY	UNIT	UNIT COST	AMOUNT
	- 30x30 cm Vitr. Ceramic Tiles		287.60	sq.m		
	TREATMENT MEDICATION AREA					
	- One Seater Modular L- Type (1.5x2x1.2) Workstation – Two-Tone		1.00	set		
	- Fabric in 2mm PVC edge band Office partitions in 45mm thick aluminum					
	- Fabric trims with 25mm thick board Melamine Finish					
	- Solid Surface Plate Countertop and Splash Board including under cabinet		0.84	sq.m		
	ISOLATION ROOM - ANTE ROOM					
	- Solid Surface Plate Countertop and Splash Board including under cabinet		3.00	sq.m		
	- 1.4m Built-up Overhead Cabinet		1.00	lm		
	DIALYZER/REPROCESSING					
	- Solid Surface Plate Countertop and Splash Board including under cabinet		3.60	sq.m		
	- 1.4m Built-up Overhead Cabinet		4.60	lm		
	STORAGE ROOM					
	- Solid Surface Plate Countertop and Splash Board including under cabinet		3.00	sq.m		
	- 1.4m Built-up Overhead Cabinet		2.00	lm		
	STAFF PANTRY					
	- Solid Surface Plate Countertop and Splash Board including under cabinet		1.70	sq.m		
	- 1.4m Built-up Overhead Cabinet		2.00	lm		
	T&B BESIDE DIALYZER/REPROCESSING					
	- Removal and hauling of Tiles		17.90	sq.m		
	- Waterproofing		6.70	sq.m		
	- 30x30 cm Vitr. Ceramic Tiles		17.90	sq.m		
	T&B BESIDE BUSINESS OFFICE					
	- Removal and hauling of Tiles		16.70	sq.m		
	- Waterproofing		6.40	sq.m		
	- 30x30 cm Vitr. Ceramic Tiles		16.70	sq.m		
	HEMODIALYSIS UNIT					
	- Solid Surface Plate Countertop and Splash Board including under cabinet		4.00	sq.m		
	- 1.4m Built-up Overhead Cabinet		4.70	lm		
	- Built-up Nurse's Station		4.00	lm		
	- 2" Stainless Steel Curtain Partition hanger		72.00	lm		
		4.00%				
10.0	REPAIR AND IMPROVEMENT WORK AT SIXTH FLOOR					
	- Removal and hauling of Existing Flooring		1,173.00	sq.m		
	- 2mm Homogenous Anti-bacterial Vinyl Roll		1,173.00	sq.m		
	- Cove Former		1,023.60	lm		
	- Capping Strip		1,023.60	lm		
	- Self Levelling Compound		1,173.00	sq.m		
	- Demolition and Hauling of Existing wall partition		180.30	sq.m		
	- M2 Panel PSM 80 including dowel		279.00	sq.m		
	- Shotcrete Cement Plaster		558.00	sq.m		
	- 12mm Ficemboard on Metal Frame Double Wall Partition		152.80	sq.m		
	- Painting of Walls		3,071.00	sq.m		
	- Dismantling and hauling of Dilapidated and affected Ceiling		1,392.00	sq.m		
	- Ceiling including hangers and Metal Framing		1,392.00	sq.m		
	- Painting of Ceiling		1,392.00	sq.m		
	- Rental of H-frame		921.30	sq.m		
	- Handrail with PVC Cover and aluminum Retainer including wall panel		80.00	lm		
	- End Cap (Left/Right)		50.00	pcs		
	- Butt Joint		23.00	pcs		
	LEDGE AND CANOPY					
	- Waterproofing		133.80	sq.m		
	- Concrete Topping		133.80	sq.m		
	MEDICAL RECORDS DEPT.					
	- One Seater Modular Type Workstation – Two-Tone Fabric Finished in 2mm PVC edge band Office partitions in 45mm thick aluminum		6.00	sets		



Name of Project : PROPOSED EXPANSION W/ IMPROVEMENT WORKS AT PASIG CITY CHILDREN'S HOSPITAL
Location : INDUSTRIA COR. ALCALDE JOSE STS., KAPASIGAN, PASIG CITY

ESTIMATED COST OF PROPOSED WORK:

ITEM NO.	DESCRIPTION	% WT	QUANTITY	UNIT	UNIT COST	AMOUNT
	trims with 25mm thick board Melamine Finish					
	- 0.8m Built-up Overhead Cabinet		3.30	lm		
	CENTRAL SUPPLY AND STERILIZATION ROOM					
	- Solid Surface Plate Countertop and Splash Board including under cabinet		5.80	sq.m		
	INSPECTION AND PACKING AREA					
	- Solid Surface Plate Countertop and Splash Board including under cabinet		4.50	sq.m		
	STORAGE AND RELEASING AREA					
	- Solid Surface Plate Countertop and Splash Board including under cabinet		10.00	sq.m		
	PHYSICAL THERAPY SECTION					
	- One Seater Modular Type Workstation – Two-Tone Fabric Finished in 2mm PVC edge band Office partitions in 45mm thick aluminum		3.00	sets		
	trims with 25mm thick board Melamine Finish					
	- Solid Surface Plate Countertop and Splash Board including under cabinet		3.40	sq.m		
	- Full Height Copper Free Wall Mirror Including Bracket		15.60	sq.m		
	- Built-up Nurse's Station		4.10	lm		
	T&B					
	- Waterproofing		9.20	sq.m		
	- 30x30 cm Vitr. Ceramic Tiles		22.70	sq.m		
		3.25%				
11.0	REPAIR AND IMPROVEMENT WORK AT LOWER ROOF DECK					
	- Demolition and Hauling of Existing wall partition		113.50	sq.m		
	- M2 Panel PSM 80 including dowel		682.60	sq.m		
	- Shotcrete Cement Plaster		1,365.20	sq.m		
	- Painting of Walls		2,172.00	sq.m		
	- Rental of H-frame		651.60	sq.m		
	LEDGE AND CANOPY					
	- Waterproofing		124.80	sq.m		
	- Concrete Topping		124.80	sq.m		
	GARDEN AREA AND EXISTING GARDEN					
	- Bench		17.60	lm		
	- Removal and hauling of Existing Flooring		323.80	sq.m		
	- Waterproofing		323.80	sq.m		
	- Stencilcrete Paving System		107.60	sq.m		
	- Collapsible Pre-Fabricated Modular Units		8.00	sets		
	Walls: 2" Polysrene Insulation with Double Sided 0.5mm Pre-painted sht. Roof: Built-in drainage design 360 Fully Covered Roof with Pre-painted GI Sheet Ceiling. Security Steel Door with lockset					
	Flooring: T18mm High-Strength Cement Fiber Board, T2mm PVC Floor					
	Window: 2-sets of PVC Sliding window w/ grills. Steel Frame: Galvanized with Two coatings. Including Electrical Fixtures and Wires					
	HALLWAY AND ELAVATOR LOBBY					
	- Removal and hauling of Existing Flooring		272.30	sq.m		
	- 60X60 Non-skid. Homogenous Porcelain Tiles		272.30	sq.m		
	FOOD WASTE AND TRASH STO AREA					
	- Removal and hauling of Existing Flooring		3.90	sq.m		
	- Industrial Powerfloor self levelling compound (Epoxy Resin Floor Finish)		3.90	sq.m		
	DIETARY SECTION AND NUTRITION CLINIC					
	- Removal and hauling of Existing Flooring		203.00	sq.m		
	- Industrial Powerfloor self levelling compound (Epoxy Resin Floor Finish)		203.00	sq.m		
	- Dismantling and hauling of Dilapidated Ceiling		228.40	sq.m		
	- Ceiling including hangers and Metal Framing		228.40	sq.m		
	- Painting of Ceiling		228.40	sq.m		
	- Rental of H-frame		69.00	sq.m		
	- Solid Surface Plate Countertop and Splash Board including under cabinet		1.30	sq.m		
	MALE & FEMALE TOILET					
	- Waterproofing		19.50	sq.m		
	- 30x30 cm Vitr. Ceramic Tiles		54.20	sq.m		



Name of Project : PROPOSED EXPANSION W/ IMPROVEMENT WORKS AT PASIG CITY CHILDREN'S HOSPITAL
Location : INDUSTRIA COR. ALCALDE JOSE STS., KAPASIGAN, PASIG CITY

ESTIMATED COST OF PROPOSED WORK:

ITEM NO.	DESCRIPTION	% WT	QUANTITY	UNIT	UNIT COST	AMOUNT
	RAMP					
	- Concrete Breaking and Disposal of Existing Ramp		23.70	sq.m		
	- Construction of New Ramp		45.00	sq.m		
	WARD EXTENSION					
	- Slab Extension		6.70	sq.m		
	- Removal and hauling of Existing Flooring		13.25	sq.m		
	- 30x30 cm Vitr. Ceramic Tiles		13.25	sq.m		
	- Solid Surface Plate Countertop and Splash Board including under cabinet		5.20	sq.m		
	- Built-up Nurse's Station		6.80	lm		
	- 1.4m Built-up Overhead Cabinet		7.50	lm		
	- Removal and hauling of Existing Flooring		260.00	sq.m		
	- 2mm Homogenous Anti-bacterial Vinyl Roll		260.00	sq.m		
	- Cove Former		236.00	lm		
	- Capping Strip		236.00	lm		
	- Self Levelling Compound		260.00	sq.m		
	- Dismantling and hauling of Dilapidated Ceiling		305.00	sq.m		
	- Ceiling including hangers and Metal Framing		305.00	sq.m		
	- Painting of Ceiling		305.00	sq.m		
	- Rental of H-frame		92.00	sq.m		
	- 2" Stainless Steel Curtain Partition hanger		101.20	lm		
	T&B					
	- Waterproofing		34.20	sq.m		
	- 30x30 cm Vitr. Ceramic Tiles		89.30	sq.m		
	TREATMENT MEDICATION AREA					
	- Solid Surface Plate Countertop and Splash Board including under cabinet		0.84	sq.m		
		3.67%				
12.0	REPAIR AND IMPROVEMENT WORK AT UPPER ROOF DECK					
	- Ga. 24 Pre-painted Longspan Rib type including Accs and Framing		33.40	sq.m		
	- 10mm Thk Solid Polycarbonate on 2x4" Tubular rafter and Trellis		33.40	sq.m		
	LEDGE AND CANOPY					
	- Waterproofing		124.70	sq.m		
	- Concrete Topping		124.70	sq.m		
	WATERPROOFING OF RAMP DECK					
	- Waterproofing		148.70	sq.m		
	- Concrete Topping		148.70	sq.m		
	- Epoxy Rubber Painted Finish		148.70	sq.m		
	WATERPROOFING OF ELEC/MECH ROOM DECK, MECHANICAL DECK AND ELEVATOR SHAFT DECK					
	- Waterproofing		431.50	sq.m		
	- Concrete Topping		431.50	sq.m		
	- Epoxy Rubber Painted Finish		431.50	sq.m		
	OVER WARD EXPANSION					
	- Repair and Repainting of Roofing		325.40	sq.m		
		0.76%				
13.0	REHABILITATION OF PUBLIC TOILET					
	- Removal and hauling of Existing Flooring, Counter Top and Cubicles		801.60	sq.m		
	- Waterproofing		440.20	sq.m		
	- 30x30 cm Vitr. Ceramic Tiles		1,195.80	sq.m		
	- Painting of Walls		269.60	sq.m		
	- Rental of H-frame		80.88	sq.m		
	- Solid Phenolic Compact Boards partition and		175.40	sq.m		
	- PWD Stainless Steel Grab Bar		23.10	lm		
	- Solid Surface Plate Countertop and Splash Board including under cabinet		31.20	sq.m		
	- Copper Free Wall Mirror including Bracket		33.40	sq.m		
		1.38%				
14.0	EXTERIOR PAINTING					
	- Painting		4,280.00	sq.m		
	- Rental of Scaffolding		1,284.00	sq.m		
		0.60%				



Name of Project : PROPOSED EXPANSION W/ IMPROVEMENT WORKS AT PASIG CITY CHILDREN'S HOSPITAL
Location : INDUSTRIA COR. ALCALDE JOSE STS., KAPASIGAN, PASIG CITY

ESTIMATED COST OF PROPOSED WORK:

ITEM NO.	DESCRIPTION	% WT	QUANTITY	UNIT	UNIT COST	AMOUNT
15.0	REHABILITATION OF STAIRCASE 1 AND 2					
	- Painting		1,590.00	sq.m		
	- Rental of H-frame		477.00	sq.m		
	- Industrial Powerfloor self levelling compound (Epoxy Resin Floor Finish)		362.40	sq.m		
		0.54%				
16.00	COUNTER WINDOWS, DOORS AND WINDOWS					
	- 8mm Thk Acrylic Glass Sliding Type Door w/ fixed Side and Transom Glass Panels on Powder Coated Extruded Aluminum Frames		284.40	sq.m		
	- 6mm Thk Tinted Glass Double Sliding Type window w/ fixed side panels on powder coated extruded aluminum frames		53.20	sq.m		
	- 6mm Thk clear viewing glass fixed type window panels on powder coated extruded aluminum frames		16.30	sq.m		
	- 12mm Thk Clear Tempered Glass shop front double swing door w/ fixed side glass panels with 100mm wide glass film strips at 150mm O.C. and 38mmØ S.S. Pipe Grab handles on Powder coated extruded aluminum frames		61.80	sq.m		
	- 10mm Thk Clear Tempered Glass shop front double swing door w/ fixed side glass panels with 100mm wide glass film strips at 150mm O.C. and 38mmØ S.S. Pipe Grab handles on Powder coated extruded aluminum frames		17.80	sq.m		
	- Automatic Double Sliding Door Operator (Width:1250-3000mm)		3.00	sets		
	- Door Operation: Bi-parting					
	- Door width: 1250-3000mm					
	- Power Supply: AC 220V 50/60Hz					
	- Opening Spded: 150-460m/s (adjustable)					
	- Closing Speed:130-460m/s (Adjustable)					
	- Open Time: 0-8secs (Adjustable)					
	- Manual Force: <50N					
	- Temp: -20 - +50 Deg. C					
	- Profile Cover: 4.20 Meters					
	Including: Two motion Sensors					
	<i>One Door Floor Guide</i>					
	- Stainless Steel Hermetic Automatic Double Sliding Door		5.00	sets		
	- Door Operation: Double Slide					
	- Door width: up to 2000mm					
	- Power Supply: AC 220V +/- 10% 50/60Hz					
	- Opening Spded: 200mm - 500mm/s (adjustable)					
	- Closing Speed: 200mm - 500mm/s (adjustable)					
	- Open Time: 0-9secs (Adjustable)					
	- Manual Force: <100N					
	- Opening Control:					
	Foot Inductive Switch /					
	Touchless Switch Infrared					
	sensor / card or biometric					
	reader					
	- Stainless Steel Hermetic Automatic Single Sliding Door		1.00	set		
	- Door Operation: Single Slide					
	- Door width: up to 1400mm					
	- Power Supply: AC 220V +/- 10% 50/60Hz					
	- Opening Spded: 200mm - 500mm/s (adjustable)					
	- Closing Speed: 200mm - 500mm/s (adjustable)					
	- Open Time: 0-9secs (Adjustable)					
	- Manual Force: <100N					
	- Opening Control:					
	Foot Inductive Switch /					
	Touchless Switch Infrared					
	sensor / card or biometric					
	reader					
	- K.D. Solid wood double swing type door w/ laminated board finish w/ 6mm Thk frosted glass view window & 50mm thk UPI Insulation		303.30	sq.m		
	- 40mm Thk Stainless Steel Hermetic Door Swing Type Anti-Bacterial		35.80	sq.m		



Name of Project : PROPOSED EXPANSION W/ IMPROVEMENT WORKS AT PASIG CITY CHILDREN'S HOSPITAL
Location : INDUSTRIA COR. ALCALDE JOSE STS., KAPASIGAN, PASIG CITY

ESTIMATED COST OF PROPOSED WORK:

ITEM NO.	DESCRIPTION	% WT	QUANTITY	UNIT	UNIT COST	AMOUNT
	Components (Complete accs, Frames and self closing mechanism)					
	- Steel Swing Type Door with Embossed Wood Panels and Groove Lines (Complete accs, Frames and self closing mechanism)		107.73	sq.m		
	- Finishing Hardware		141.00	sets		
	- Frames (Jambs)		141.00	sets		
	- (CW 01) 10mm Thk Clear tempered Glass Fixed Panels with 100mm wide Glass Film Strips at 150mm O.C. on Powder Coated Extruded aluminum Frames including 850mm high Built-up counter desk w/ 20mm thk Marine Laminated Board Finish		20.30	lm		
	- (CW 03) 10mm Thk Clear tempered Glass Fixed Panels with 100mm wide Glass Film Strips at 150mm O.C. on Powder Coated Extruded aluminum Frames including 850mm high Built-up counter desk w/ 20mm thk Marine Laminated Board Finish		33.10	lm		
	- (CW 04) 6mm Thk Clear Glass Fixed/Sliding Panels with 100mm wide Glass Film Strips at 150mm O.C. on Powder Coated Extruded aluminum Frames including 850mm high Built-up counter desk w/ 20mm thk Marine Laminated Board Finish		8.10	lm		
		5.45%				
17.00	MEDICAL GAS PIPING					
17.1	BASEMENT AND GROUND FLOOR					
17.1.1	Coppertubes Type L cleaned for Medical Pipeline use					
	- 3 1/8		20.0	pcs		
	- 2 5/8		18.0	pcs		
	- 1 5/8		28.0	pcs		
	- 1 3/8		5.0	pcs		
	- 1 1/8		28.0	pcs		
	- 7/8		65.0	pcs		
	- 3/4		35.0	pcs		
	- 5/8		55.0	pcs		
17.1.2	Medical Gas Outlet					
	- Tri-tech Medical USA Oxygen DISS		15.0	sets		
	- Tri-tech Medical USA Air DISS		15.0	sets		
	- Tri-tech Medical USA Vacuum/Slide DISS		15.0	sets		
17.1.3	Medical Gas Zone Valve and Alarm and Equipment					
	- Tri-tech Medical USA ZVA Combo Digital Touchscreen		1.0	set		
	OAV 1 1/2" x 1 1/2" x 1"					
	- 1 Meter beadhead unit with reading light and Convenience outlet		15.0	sets		
		1.97%				
17.2	SECOND FLOOR AND FOURTH FLOOR					
17.2.1	Coppertubes Type L cleaned for Medical Pipeline use					
	- 2 1/8		40.0	pcs		
	- 1 5/8		20.0	pcs		
	- 1 1/8		75.0	pcs		
	- 7/8		205.0	pcs		
	- 3/4		160.0	pcs		
	- 5/8		310.0	pcs		
17.2.2	Medical Gas Outlet					
	- Tri-tech Medical USA Oxygen DISS		121.0	sets		
	- Tri-tech Medical USA Air DISS		35.0	sets		
	- Tri-tech Medical USA Vacuum/Slide DISS		121.0	sets		
17.2.3	Medical Gas Zone Valve and Alarm and Equipment					
	- Tri-tech Medical USA ZVA Combo Digital Touchscreen		6.0	set		
	OAV 1 1/2" x 1 1/2" x 1"					
	- Tri-tech Medical USA ZVA Combo Digital Touchscreen		2.0	set		
	OV 1 1/2" x 1 1/2"					
	- 1 Meter beadhead unit with reading light and Convenience outlet		98.0	sets		
	- Ceiling Column for OR		2.0	sets		
		5.59%				
17.3	FIFTH TO SEVENTH FLOOR					
17.3.1	Coppertubes Type L cleaned for Medical Pipeline use					



Name of Project : PROPOSED EXPANSION W/ IMPROVEMENT WORKS AT PASIG CITY CHILDREN'S HOSPITAL
Location : INDUSTRIA COR. ALCALDE JOSE STS., KAPASIGAN, PASIG CITY

ESTIMATED COST OF PROPOSED WORK:

ITEM NO.	DESCRIPTION	% WT	QUANTITY	UNIT	UNIT COST	AMOUNT
	- 1 5/8		35.0	pcs		
	- 1 1/8		40.0	pcs		
	- 7/8		45.0	pcs		
	- 3/4		150.0	pcs		
	- 5/8		160.0	pcs		
17.3.2	Medical Gas Outlet					
	- Tri-tech Medical USA Oxygen DISS		78.0	sets		
	- Tri-tech Medical USA Vacuum/Slide DISS		70.0	sets		
17.1.3	Medical Gas Zone Valve and Alarm and Equipment					
	- Tri-tech Medical USA ZVA Combo Digital Touchscreen OV 1 1/2" x 1 1/2"		3.0	set		
	- Tri-tech Medical USA ZVA Combo Digital Touchscreen O 1 1/2"		1.0	set		
	- 1 Meter beadhead unit with reading light and Covenience outlet		78.0	sets		
		3.02%				
17.4	MEDICAL GAS SOURCE EQUIPMENT					
	- 10hp Triplex Vacuum pump complete set touchscreen PLC		1.0	set		
	- 7.5hp triplex Air compressor complete set touchscreen PLC		1.0	set		
	- 20x20 header Tri-tech Oxygen Manifold complete set		1.0	set		
	- 15x15 header Tri-tech Air Manifold complete set		1.0	set		
	- Tri-tech Medical Master Alarm 3-gas Digital touchscreen		1.0	set		
	- Bracketing materials, sundries, and copper fittings (incl. oxyacetyline tanks, silver rods, and etc.)		1.0	ls		
		8.04%				
17.5	LABOR AND SUPERVISION					
	- Labor and Deliveries		1.0	ls		
		2.79%				
18.00	PLUMBING WORKS					
18.1	(Use PVC Pipes and Fittings of S-1000, SDR 35,ASTM D2729 and ISO 3633)					
	SEWER LINES:					
	PVC PIPE 8"X 3m		55.0	length		
	PVC PIPE 6"X 3m		70.0	length		
	PVC PIPE 4"X 3m		840.0	length		
	PVC PIPE 3"X 3m		78.3	length		
	PVC PIPE 2"X 3m		450.0	length		
	PVC WYE 8"X8"		5.0	pcs		
	PVC WYE 6"X6"		13.0	pcs		
	PVC WYE 4"X4"		212.0	pcs		
	PVC WYE 3"X3"		41.0	pcs		
	PVC WYE 2"X2"		42.0	pcs		
	PVC WYE REDUCER 8"X6"		7.0	pcs		
	PVC WYE REDUCER 6"X4"		10.0	pcs		
	PVC WYE REDUCER 6"X2"		24.0	pcs		
	PVC WYE REDUCER 4"X2"		234.0	pcs		
	PVC WYE REDUCER 3"X2"		34.0	pcs		
	PVC ELBOW 8"X90°		10.0	pcs		
	PVC ELBOW 6"X90°		8.0	pcs		
	PVC ELBOW 4"X90°		865.0	pcs		
	PVC ELBOW 3"X90°		80.0	pcs		
	PVC ELBOW 2"X90°		1244.0	pcs		
	PVC ELBOW 8"X45°		15.0	pcs		
	PVC ELBOW 6"X45°		33.0	pcs		
	PVC ELBOW 4"X45°		843.0	pcs		
	PVC ELBOW 3"X45°		169.0	pcs		
	PVC ELBOW 2"X45°		1128.0	pcs		
	PVC COUPLING REDUCER 8"X6"		4.0	pcs		
	PVC COUPLING REDUCER 8"X4"		8.0	pcs		
	PVC COUPLING REDUCER 6"X4"		12.0	pcs		
	PVC TEE 4"X2"		176.0	pcs		
	PVC TEE 4"		16.0	pcs		



Name of Project : PROPOSED EXPANSION W/ IMPROVEMENT WORKS AT PASIG CITY CHILDREN'S HOSPITAL
Location : INDUSTRIA COR. ALCALDE JOSE STS., KAPASIGAN, PASIG CITY

ESTIMATED COST OF PROPOSED WORK:

ITEM NO.	DESCRIPTION	% WT	QUANTITY	UNIT	UNIT COST	AMOUNT
	PVC TEE 2"		420.0	pcs		
	PVC P-TRAP 3"		34.0	pcs		
	PVC P-TRAP 2"		124.0	pcs		
	PVC CLEAN-OUT 6"		12.0	pcs		
	PVC CLEAN-OUT 4"		128.0	pcs		
	PVC CLEAN-OUT 2"		54.0	pcs		
	SOLVENT 400cc		327.0	can		
	Metal Hangers w/ Expansion Bolt		400.0	pcs		
	B.I PIPE SCH 40 - 4" X 6 METERS		24.0	pcs		
	B.I ELBOW SCH 40 4" (WELDED)		12.0	pcs		
	Labor Cost					
		1.45%				
18.2	(Use PVC Pipes and Fittings of S-1000, SDR 35, ASTM D2729 and ISO 3633)					
	SEWER LINES:					
	PVC PIPE 8" X 3m		84.0	length		
	PVC PIPE 6" X 3m		287.0	length		
	PVC PIPE 4" X 3m		288.0	length		
	PVC PIPE 3" X 3m		126.0	length		
	PVC WYE 6" X 6"		16.0	pcs		
	PVC WYE 4" X 4"		52.0	pcs		
	PVC WYE 3" X 3"		10.0	pcs		
	PVC WYE REDUCER 8" X 6"		26.0	pcs		
	PVC WYE REDUCER 6" X 4"		10.0	pcs		
	PVC ELBOW 8" X 90°		10.0	pcs		
	PVC ELBOW 6" X 90°		30.0	pcs		
	PVC ELBOW 4" X 90°		90.0	pcs		
	PVC ELBOW 3" X 90°		28.0	pcs		
	PVC ELBOW 8" X 45°		20.0	pcs		
	PVC ELBOW 6" X 45°		60.0	pcs		
	PVC ELBOW 4" X 45°		122.0	pcs		
	PVC ELBOW 3" X 45°		40.0	pcs		
	PVC COUPLING REDUCER 8" X 6"		4.0	pcs		
	PVC COUPLING REDUCER 8" X 4"		8.0	pcs		
	PVC COUPLING REDUCER 6" X 4"		12.0	pcs		
	PVC CLEAN-OUT 6"		12.0	pcs		
	PVC CLEAN-OUT 4"		22.0	pcs		
	SOLVENT 400cc		236.0	can		
	Metal Hangers w/ Expansion Bolt		200.0	pcs		
	ROOF DRAIN		24.0	pcs		
	GUTTER DRAIN		20.0	pcs		
	Labor Cost					
		0.94%				
18.3	REPAIR OF WATER LINES					
	PPR PIPE 20 (1/2") x 4m		459.00	pcs		
	PPR PIPE 25 (3/4") x 4m		218.00	pcs		
	PPR PIPE 32 (1") x 4m		304.0	pcs		
	PPR PIPE 50 (1 1/2") x 4m		156.0	pcs		
	PPR PIPE 63 (2") x 4m		86.0	pcs		
	PPR PIPE 90 (3") x 4m		74.0	pcs		
	PPR PIPE 100 (4") x 4m		80.0	pcs		
	PPR ELBOW 20(1/2")		344.0	pcs		
	PPR ELBOW 25(3/4")		284.0	pcs		
	PPR ELBOW 32(1")		312.0	pcs		
	PPR ELBOW 50(1 1/2")		88.0	pcs		
	PPR ELBOW 63(2")		30.0	pcs		
	PPR ELBOW 90(3")		20.0	pcs		
	PPR ELBOW 110(4")		56.0	pcs		
	PPR TEE 20 (1/2")		246.0	pcs		
	PPR TEE 25 (3/4")		148.0	pcs		
	PPR TEE 32 (1")		78.0	pcs		
	PPR TEE 50 (1 1/2")		12.0	pcs		



Name of Project : PROPOSED EXPANSION W/ IMPROVEMENT WORKS AT PASIG CITY CHILDREN'S HOSPITAL
Location : INDUSTRIA COR. ALCALDE JOSE STS., KAPASIGAN, PASIG CITY

ESTIMATED COST OF PROPOSED WORK:

ITEM NO.	DESCRIPTION	% WT	QUANTITY	UNIT	UNIT COST	AMOUNT
	PPR TEE 63 (2")		8.0	pcs		
	PPR TEE 90 (3")		6.0	pcs		
	PPR TEE 110 (4")		12.0	pcs		
	PPR TEE REDUCER 110mm x 63mm		5.0	pcs		
	PPR TEE REDUCER 110mm x 50mm		15.0	pcs		
	PPR TEE REDUCER 90mm x 63mm		4.0	pcs		
	PPR TEE REDUCER 90mm x 50mm		25.0	pcs		
	PPR TEE REDUCER 63mm x 50mm		18.0	pcs		
	PPR TEE REDUCER 63mm x 32mm		26.0	pcs		
	PPR TEE REDUCER 50mm x 32mm		6.0	pcs		
	PPR TEE REDUCER 32mm x 20mm		66.0	pcs		
	PPR STR MALE ADAPTER 20mm		132.0	pcs		
	PPR STR MALE ADAPTER 25mm		28.0	pcs		
	PPR STR MALE ADAPTER 32mm		44.0	pcs		
	PPR STR MALE ADAPTER 50mm		10.0	pcs		
	PPR ELBOW FEMALE ADAPTER 20mm		405.0	pcs		
	PPR ELBOW FEMALE ADAPTER 25mm		124.0	pcs		
	PPR ELBOW FEMALE ADAPTER 32mm		56.0	pcs		
	PPR TEE FEMALE ADAPTER 20mm		205.0	pcs		
	PPR END CAP 20mm		405.0	pcs		
	PPR END CAP 32mm		56.0	pcs		
	PPR COUPLINF RED. 110mm X @90mm		12.0	pcs		
	PPR COUPLINF RED. 90mm X @63mm		18.0	pcs		
	PPR COUPLINF RED. 63mm X @50mm		14.0	pcs		
	PPR COUPLINF RED. 63mm X @32mm		36.00	pcs		
	PPR COUPLINF RED. 50mm X @32mm		54.00	pcs		
	PPR COUPLINF RED. 32mm X @25mm		54.00	pcs		
	PPR COUPLINF RED. 32mm X @20mm		148.00	pcs		
	PPR COUPLINF RED. 25mm X @20mm		64.00	pcs		
	PPR COUPLING 110mm		70.0	pcs		
	PPR COUPLING 90mm		68.0	pcs		
	PPR COUPLING 63mm		76.0	pcs		
	PPR COUPLING 50mm		120.0	pcs		
	PPR COUPLING 32mm		68.0	pcs		
	PPR COUPLING 25mm		126.0	pcs		
	PPR COUPLING 20mm		244.0	pcs		
	GATE VALVE 1/2" KITZ		66.0	pcs		
	GATE VALVE 1" KITZ		22.0	pcs		
	Metal Hangers w/ Expansion Bolt		250.0	pcs		
	RJQ-110 (UP TO 110mm)		1.0	unit		
	RJQ-40 (UP TO 40mm)		1.0	unit		
	Labor Cost					
		2.96%				
18.4	PLUMBING FIXTURES					
	Water closet Commercial type		66.0	unit/s		
	Counter type Lavatory		51.0	unit/s		
	Semi - Pedestal Type Lavatory		56.0	unit/s		
	FLOOR DRAIN SQUARE STAINLESS		112.0	unit/s		
	Urinal flush valve		32.0	unit/s		
	Shower Set		49.0	unit/s		
	7 Gpm Grease Trap		12.0	unit/s		
	Bidet Set (Stainless Type)		66.0	unit/s		
	Soap Holder (Stainless Type)		49.0	unit/s		
	Tissue Holder (Stainless Type)		66.0	unit/s		
	Towel rack (Stainless Type)		49.0	unit/s		
	Water heater Single Point		61.0	unit/s		
	Labor Cost					
		2.02%				
19.00	ELECTRICAL AND MECHANICAL WORKS					
19.1	ELECTRICAL WORKS					
19.1.1	PANELBOARDS AND BREAKERS					
1.01	LOW VOLTAGE SWITCH GEAR (LVSG)					



Name of Project : PROPOSED EXPANSION W/ IMPROVEMENT WORKS AT PASIG CITY CHILDREN'S HOSPITAL
Location : INDUSTRIA COR. ALCALDE JOSE STS., KAPASIGAN, PASIG CITY

ESTIMATED COST OF PROPOSED WORK:

ITEM NO.	DESCRIPTION	% WT	QUANTITY	UNIT	UNIT COST	AMOUNT
	Replacement of Deffective ACB, MCCB and Additional MCCB 2000AT, 3P, ACB, 415V, Drawout Type, 65kAIC, Mechanical Interlock for 2000AF, sliding type, motor mechanism modules with SDE adapter and auxillary switch, electrically operated with Micro Logic 6.0 LSIG 600AT, 600AF, 3P, MCCB, 50kAIC, Thermal Magnetic and Electronic Trip, Micrologic 5.0 (LSIG) 500AT, 600AF, 3P, MCCB, 50kAIC, Thermal Magnetic and Electronic Trip, Micrologic 5.0 (LSIG)		2.00	unit		
			1.00	unit		
			1.00	unit		
1.02	AUTOMATIC TRANSFER SWITCH (ATS) at Basement Replacement of Deffective MCCB, ATS Controller and Mechanical Interlock for Fire Pump ATS 300AT, 300AF, 4P, 50kAIC, 415V Mechanical Interlock for 300AT, Sliding Type Motor Mechanism Modules with SDE Adapter and Auxillary Switch Electrically operated with Micrologic 6.0 Trip unit ATS Controller HAT 700		2.00	units		
			1.00	unit		
1.03	AUTOMATIC TRANSFER SWITCH (ATS) at LVSG Replacement of Deffective ACB, ATS Controller and Mechanical Interlock for Fire Pump ATS 1600AT, 1600AF, 4P, 50kAIC, 415V Mechanical Interlock for 800AT, Sliding Type Motor Mechanism Modules with SDE Adapter and Auxillary Switch Drawout Type Electrically operated with Micrologic 6.0 Trip unit ATS Controller HAT 700		2.00	units		
			1.00	unit		
1.04	AUTOMATIC TRANSFER SWITCH (ATS) at LVSG Replacement of Deffective MCCB, ATS Controller and Mechanical Interlock for Fire Pump ATS 800AT, 800AF, 4P, 50kAIC, 415V Mechanical Interlock for 800AT, Sliding Type Motor Mechanism Modules with SDE Adapter and Auxillary Switch Electrically operated with Micrologic 6.0 Trip unit ATS Controller HAT 700		2.00	units		
			1.00	unit		
1.05	SMDB-MECH'L-GF MAIN: 600AT, 600AF, 3P, MCCB,50kAIC, 415V, Micrologic 6.0 LSIG Branches: 1 - 400AT, 3P, 35kAIC,MCCB, 415V, LSI, Micrologic 5.0 2 - 200AT, 3P, 35kAIC,MCCB, 415V, LSI, Micrologic 5.0 1 - 100AT, 3P, 35kAIC,MCCB, 415V, LSI, Micrologic 5.0 In NEMA 1 Enclosure, Bolt-on, with Grounding and Neutral Terminal Block, Powder Coated Finished, G.I. Sheet # 16, Surface Mount		1.00	assem		
			1.00	unit		
			1.00	units		
			2.00	units		
			1.00	units		
			1.00	enclos		
1.06	PB-MECH'L-GF MAIN:200AT, 200AF, 3P, MCCB,35kAIC, 415V, LSI Branches: 6 - 60AT, 3P, 18kAIC,MCCB, 415V, Thermal and Electronic Trip In NEMA 1 Enclosure, Bolt-on, with Grounding and Neutral Terminal Block, Powder Coated Finished, G.I. Sheet # 16, Surface Mount		1.00	assem		
			1.00	unit		
			6.00	units		
			1.00	enclos		
1.07	PB-ACU-GF MAIN:100AT, 200AF, 3P, MCCB,35kAIC, 415V Branches: 16 - 30AT, 1P, 18kAIC,MCCB, 230V In NEMA 1 Enclosure, Bolt-on, with Grounding and Neutral Terminal Block, Powder Coated Finished, G.I. Sheet # 16, Surface Mount		1.00	assem		
			1.00	unit		
			16.00	units		
			1.00	enclo sure		
1.08	PB-MECH'L-2F-A MAIN: 400AT, 400AF, 3P, MCCB,35kAIC, 415V, Micrologic 6.0 LSI Branches: 1 - 200AT, 3P, 35kAIC,MCCB, 415V, LSI 5 - 50AT, 3P, 35kAIC,MCCB, 415V, LSI		1.00	assem		
			1.00	unit		
			1.00	units		
			5.00	units		



Name of Project : PROPOSED EXPANSION W/ IMPROVEMENT WORKS AT PASIG CITY CHILDREN'S HOSPITAL
Location : INDUSTRIA COR. ALCALDE JOSE STS., KAPASIGAN, PASIG CITY

ESTIMATED COST OF PROPOSED WORK:

ITEM NO.	DESCRIPTION	% WT	QUANTITY	UNIT	UNIT COST	AMOUNT
	In NEMA 1 Enclosure, Bolt-on, with Grounding and Neutral Terminal Block, Powder Coated Finished, G.I. Sheet # 16, Surface Mount		1.00	enclos		
1.09	PB-MECH'L-2F-B MAIN: 200AT, 200AF, 3P, MCCB,35kAIC, 415V, LSI Branches: 4 - 50AT, 3P, 22kAIC,MCCB, 415V 2 - 40AT, 3P, 22kAIC,MCCB, 415V In NEMA 1 Enclosure, Bolt-on, with Grounding and Neutral Terminal Block, Powder Coated Finished, G.I. Sheet # 16, Surface Mount		1.00 1.00 4.00 2.00 1.00	assem unit units units enclos		
1.10	PB-MECH'L-3F MAIN: 200AT, 200AF, 3P, MCCB,35kAIC, 415V, LSI Branches: 4 - 50AT, 3P, 22kAIC,MCCB, 415V 2 - 40AT, 3P, 35kAIC,MCCB, 415V In NEMA 1 Enclosure, Bolt-on, with Grounding and Neutral Terminal Block, Powder Coated Finished, G.I. Sheet # 16, Surface Mount		1.00 1.00 4.00 2.00 1.00	assem unit units units enclos		
1.11	PB-LABORATORY-3F MAIN: 150AT, 200AF, 3P, MCCB,22kAIC, 415V, LSI Branches: 10 - 30AT, 1P, 10kAIC,MCCB, 415V 10 - 40AT, 1P, 10kAIC,MCCB, 415V In NEMA 1 Enclosure, Bolt-on, with Grounding and Neutral Terminal Block, Powder Coated Finished, G.I. Sheet # 16, Surface Mount		1.00 1.00 10.00 10.00 1.00	assem unit units units enclos		
1.12	SMDB-MECH'L-MECH'L-URD MAIN:600AT, 600AF, 3P, MCCB,50kAIC, 415V, Micrologic 6.0 LSI Branches: 4 - 200AT, 3P, 35kAIC,MCCB, 415V, LSI In NEMA 4X Enclosure, Bolt-on, with Grounding and Neutral Terminal Block, Powder Coated Finished, G.I. Sheet # 16, Surface Mount		1.00 1.00 4.00 1.00	assem unit units enclos		
1.13	PB-MECH'L-4F MAIN: 200AT, 200AF, 3P, MCCB,35kAIC, 415V, LSI Branches: 4 - 50AT, 3P, 22kAIC,MCCB, 415V 2 - 40AT, 3P, 22kAIC,MCCB, 415V In NEMA 4X Enclosure, Bolt-on, with Grounding and Neutral Terminal Block, Powder Coated Finished, G.I. Sheet # 16, Surface Mount		1.00 1.00 4.00 2.00 1.00	assem unit units units enclos		
1.14	PB-AUTOCLAVE-6F MAIN: 200AT, 200AF, 3P, MCCB,35kAIC, 415V, LSI Branches: 2 - 100AT, 3P, 22kAIC, MCCB, 415V 2 - 40AT, 3P, 35kAIC, MCCB, 415V In NEMA 1X Enclosure, Bolt-on, with Grounding and Neutral Terminal Block, Powder Coated Finished, G.I. Sheet # 16, Surface Mount		1.00 1.00 2.00 2.00 1.00	assem unit units units enclos		
1.15	PB-LP-RD MAIN: 60AT, 100AF, 3P, MCCB18kAIC, 415V Branches: 16 - 30AT, 1P, 10kAIC,MCCB, 230V In NEMA 1 Enclosure, Bolt-on, with Grounding and Neutral Terminal Block, Powder Coated Finished, G.I. Sheet # 16, Surface Mount		1.00 1.00 16.00 1.00	assem unit units enclosure		
1.16	Enclosed Circuit Breaker MAIN: 60AT, 100AF, 3P, MCCB, 22kAIC, 415V,Thermal Magnetic, in NEMA 4X Enclosure with Grounding and Neutral Terminal Lugs		8.00	assem		



Name of Project : PROPOSED EXPANSION W/ IMPROVEMENT WORKS AT PASIG CITY CHILDREN'S HOSPITAL
Location : INDUSTRIA COR. ALCALDE JOSE STS., KAPASIGAN, PASIG CITY

ESTIMATED COST OF PROPOSED WORK:

ITEM NO.	DESCRIPTION	% WT	QUANTITY	UNIT	UNIT COST	AMOUNT
1.17	Enclosed Circuit Breaker MAIN: 100AT, 100AF, 3P, MCCB, 22kAIC, 415V, Thermal Magnetic, in NEMA 4X Enclosure with Grounding and Neutral Terminal Lugs		10.00	assem		
1.18	Enclosed Circuit Breaker MAIN: 150AT, 200AF, 3P, MCCB, 18kAIC, 415V, Thermal Magnetic, in NEMA 4X Enclosure with Grounding and Neutral Terminal Lugs		4.00	assem		
1.19	Enclosed Circuit Breaker MAIN: 200AT, 250AF, 3P, MCCB, 22kAIC, LSIG, 415V in NEMA 4X Enclosure with Grounding and Neutral Terminal Lugs		2.00	assem		
1.20	Enclosed Circuit Breaker MAIN: 300AT, 400AF, 3P, MCCB, 22kAIC, 415V, LSIG, In NEMA 4X Enclosure with Grounding and Neutral Terminal Lugs		4.00	assem		
1.22	Enclosed Circuit Breaker MAIN: 30AT, 60AF, 1P, MCCB, 10kAIC, 230V, in NEMA 4X Enclosure with Grounding and Neutral Terminal Lugs		18.00	assem		
1.23	IP-2F-1, IP-2F-2 and IP-2F-3 at Operating Rooms Relocation of Isotrol Panelboard and Preventive Maintenance.		3.00	assem		
1.24	GPS-RD Panelboards Preventive Maintenance and Calibration of Master Control Panel		1.00	assem		
1.25	Distribution and Sub -Panelboards Preventive Maintenance, cleaning, re-tagging and re-tightening of breakers		43.00	assem		
1.26	Consumables - tox with metal screw, expansion bolt and shield, flat washers		1.00	lot		
		2.59%				
19.1.2	WIRES, CONDUITS, AND BOXES					
2.01	150.0 mm ² THHN Stranded		1,890.00	mtrs		
2.02	100.0 mm ² THHN Stranded		844.00	mtrs		
2.03	30.0 mm ² THHN Stranded		640.00	mtrs		
2.04	22.0 mm ² THHN Stranded		322.00	mtrs		
2.05	14.0 mm ² THHN Stranded		688.00	mtrs		
2.06	8.0 mm ² THHN Stranded		722.00	mtrs		
2.07	5.5 mm ² THHN Stranded		1,862.00	mtrs		
2.08	3.5 mm ² THHN Stranded		2,261.00	mtrs		
2.09	2.0 mm ² THHN Stranded		2,144.00	mtrs		
2.10	80 mmØ (3") IMC x 10ft.		210.00	lgt		
2.11	50 mmØ (2") IMC x 10ft.		94.00	lgt		
2.12	40 mmØ (1 1/2") IMC x 10ft.		112.00	lgt		
2.13	25 mmØ (1") IMC x 10ft.		80.00	lgt		
2.14	20 mmØ (3/4") IMC x 10ft.		476.00	lgt		
2.15	15 mmØ (1/2") IMC x 10ft.		358.00	lgt		
2.16	Junction Box, deep type, with cover and ground terminal, G.I. #16		894.00	pcs		
2.17	Utility Box, deep type, ground terminal, G.I. #16		656.00	pcs		
2.18	IMC Coupling, 3"Ø		80.00	pcs		
2.19	IMC Coupling, 2"Ø		100.00	pcs		
2.20	IMC Coupling, 1 1/2"Ø		140.00	pcs		
2.21	IMC Coupling, 1"Ø		90.00	pcs		
2.22	IMC Coupling, 3/4"Ø		600.00	pcs		
2.23	IMC Coupling, 1/2"Ø		700.00	pcs		
2.24	G.I Wires #16		10.00	kilos		
2.25	Tox with Metal Screw #8		2.00	boxes		
2.26	Pull-Boxes with cover, Gauge #16(assorted sizes)		1.00	lot		
2.27	Hanger and Supports, Horizontal and Vertical (Unitstrut bar, full tread rod, anchor grip, clamps, flat washers and nuts, etc.)		600.00	sets		
		2.20%				
19.1.3	FIXTURES AND WIRING DEVICES					



Name of Project : PROPOSED EXPANSION W/ IMPROVEMENT WORKS AT PASIG CITY CHILDREN'S HOSPITAL
Location : INDUSTRIA COR. ALCALDE JOSE STS., KAPASIGAN, PASIG CITY

ESTIMATED COST OF PROPOSED WORK:

ITEM NO.	DESCRIPTION	% WT	QUANTITY	UNIT	UNIT COST	AMOUNT
3.01	60W, HI-BAY LED, 90 Degrees beam angle, Day light		6.00	pcs		
3.02	Downlight LED Panel, Recessed Type, 6" diameter, 15watts,		418.00	pcs		
3.03	Recessed type Luminare, Housing made of sheet, power coated in white resins, with Prismatic Diffuser, 4 x 18watts LED tube lamp, 30t - 40t burning hours, 300mm x 1200mm x 120mm, 120lumens per watt or higher		37.00	pcs		
3.04	Recessed type Luminare, Housing made of sheet, power coated in white resins, Louver Type, 4 x 9watts LED tube lamp, 30t - 40t burning hours, 600mm x 600mm x 100mm, 120lumens per watt or higher		141.00	pcs		
3.05	Emergency Light, Twin Head LED bulb, 230volts, 20 to 30 hours		289.00	pcs		
3.06	Polycarbonate Lighting Fixtures, IP65, 2x18watts LED Lamp tube, Daylight, 230V		24.00	pcs		
3.07	Exhaust Fan, Ceiling Cassette Type, 12" x 12", complete with flexible duct and stainless exhaust hood		3.00	pcs		
3.08	One Gang switch, Wide type, 10Ampere, with cover plate, white finished		24.00	pcs		
3.09	Two Gang switch, Wide type, 10Ampere, with cover plate, white finished		32.00	pcs		
3.10	Three Gang switch, Wide type, 10Ampere, with cover plate, white finished		14.00	pcs		
3.11	Hospital Grade Duplex Outlet, 20Ampere Rating with grounding, 230V, with cover plate, white finished		182.00	pcs		
3.12	Duplex Outlet, 16Ampere Rating with grounding, Universal Type, with cover plate, white finished		84.00	pcs		
3.13	Simplex Outlet, 16Ampere Rating with grounding, Universal Type, with cover plate, white finished		289.00	pcs		
3.14	LED Lamp Tube, 18watts, daylight, 120lumens per watt or higher, 230volts, double ended, T8 (replacement for existing fluorescent)		884.00	pcs		
3.15	LED Lamp Tube, 9watts, daylight, 120lumens per watt or higher, 230volts, double ended, T8 (replacement for existing fluorescent)		320.00	pcs		
		0.93%				
19.2	MECHANICAL WORKS					
19.2.1	AIRCON WORKS					
19.2.1.1	VRV/VRF (VARIABLE REFRIGERANT VOLUME/FLOW) UNITS					
	SYSTEM 1, GROUND FLOOR					
1.01	14.OHP, OUTDOOR UNIT, VRV/VRF 400V/380V, 3P, 60HZ, INVERTER		1.00	Pc		
1.02	8.OHP, OUTDOOR UNIT, VRV/VRF 400V/380V, 3P, 60HZ, INVERTER		1.00	Pc		
1.03	1.OHP CEILING CASSETTE DOUBLE FLOW, INVERTER TYPE 220V, 1P,		15.00	Pcs		
	SYSTEM 2, GROUND FLOOR					
1.04	14.OHP, OUTDOOR UNIT, VRV/VRF 400V/380V, 3P, 60HZ, INVERTER		1.00	Pc		
1.05	12.OHP, OUTDOOR UNIT, VRV/VRF 400V/380V, 3P, 60HZ, INVERTER		1.00	Pc		
1.06	3.OHP CEILING CASSETTE, INVERTER TYPE 220V, 1P, 60HZ		2.00	Pcs		
1.07	1.OHP CEILING CASSETTE DOUBLE FLOW, INVERTER TYPE 220V, 1P,		11.00	Pcs		
	SYSTEM 3, GROUND FLOOR					
1.08	14.OHP, OUTDOOR UNIT, VRV/VRF 400V/380V, 3P, 60HZ, INVERTER		1.00	Pc		
1.09	12.OHP, OUTDOOR UNIT, VRV/VRF 400V/380V, 3P, 60HZ, INVERTER		1.00	Pc		
1.10	3.OHP CEILING CASSETTE, INVERTER TYPE 220V, 1P, 60HZ		2.00	Pcs		
1.11	1.OHP CEILING CASSETTE DOUBLE FLOW, INVERTER TYPE 220V, 1P,		9.00	Pcs		
	SYSTEM 1, SECOND FLOOR					
1.12	14.OHP, OUTDOOR UNIT, VRV/VRF 400V/380V, 3P, 60HZ, INVERTER		1.00	Pc		
1.13	10.OHP, OUTDOOR UNIT, VRV/VRF 400V/380V, 3P, 60HZ, INVERTER		1.00	Pc		
1.14	3.OHP CEILING CASSETTE, INVERTER TYPE 220V, 1P, 60HZ		3.00	Pcs		
1.15	2.OHP CEILING CASSETTE DOUBLE FLOW, INVERTER TYPE 220V, 1P,		1.00	Pcs		
1.16	1.OHP CEILING CASSETTE DOUBLE FLOW, INVERTER TYPE 220V, 1P,		5.00	Pcs		
	SYSTEM 2, SECOND FLOOR					
1.17	18.OHP, OUTDOOR UNIT, VRV/VRF 400V/380V, 3P, 60HZ, INVERTER		1.00	Pc		
1.18	14.OHP, OUTDOOR UNIT, VRV/VRF 400V/380V, 3P, 60HZ, INVERTER		1.00	Pc		
1.19	3.OHP CEILING CASSETTE, INVERTER TYPE 220V, 1P, 60HZ		4.00	Pcs		



Name of Project : PROPOSED EXPANSION W/ IMPROVEMENT WORKS AT PASIG CITY CHILDREN'S HOSPITAL
Location : INDUSTRIA COR. ALCALDE JOSE STS., KAPASIGAN, PASIG CITY

ESTIMATED COST OF PROPOSED WORK:

ITEM NO.	DESCRIPTION	% WT	QUANTITY	UNIT	UNIT COST	AMOUNT
1.20	2.0HP CEILING CASSETTE DOUBLE FLOW, INVERTER TYPE 220V, 1P,		1.00	Pcs		
1.21	1.0HP CEILING CASSETTE DOUBLE FLOW, INVERTER TYPE 220V, 1P,		6.00	Pcs		
SYSTEM 3,SECOND FLOOR						
1.22	16.0HP, OUTDOOR UNIT, VRV/VRF 400V/380V, 3P, 60HZ, INVERTER		1.00	Pc		
1.23	14.0HP, OUTDOOR UNIT, VRV/VRF 400V/380V, 3P, 60HZ, INVERTER		1.00	Pc		
1.24	3.0HP CEILING CASSETTE, INVERTER TYPE 220V, 1P, 60HZ		4.00	Pcs		
1.25	2.0HP CEILING CASSETTE DOUBLE FLOW, INVERTER TYPE 220V, 1P,		4.00	Pcs		
SYSTEM 4,SECOND FLOOR						
1.26	12.0HP, OUTDOOR UNIT, VRV/VRF 400V/380V, 3P, 60HZ, INVERTER		1.00	Pc		
1.27	8.0HP, OUTDOOR UNIT, VRV/VRF 400V/380V, 3P, 60HZ, INVERTER		1.00	Pc		
1.28	3.0HP CEILING CASSETTE, INVERTER TYPE 220V, 1P, 60HZ		2.00	Pcs		
1.29	1.0HP CEILING CASSETTE DOUBLE FLOW, INVERTER TYPE 220V, 1P,		7.00	Pcs		
SYSTEM 1,THIRD FLOOR						
1.30	14.0HP, OUTDOOR UNIT, VRV/VRF 400V/380V, 3P, 60HZ, INVERTER TYPE		1.00	Pc		
1.31	10.0HP, OUTDOOR UNIT, VRV/VRF 400V/380V, 3P, 60HZ, INVERTER TYPE		1.00	Pc		
1.32	3.0HP CEILING CASSETTE, INVERTER TYPE 220V, 1P, 60HZ		4.00	Pcs		
1.33	1.0HP CEILING CASSETTE DOUBLE FLOW, INVERTER TYPE 220V, 1P,		3.00	Pcs		
SYSTEM 2,THIRD FLOOR						
1.04	14.0HP, OUTDOOR UNIT, VRV/VRF 400V/380V, 3P, 60HZ, INVERTER		1.00	Pc		
1.05	10.0HP, OUTDOOR UNIT, VRV/VRF 400V/380V, 3P, 60HZ, INVERTER		1.00	Pc		
1.12	3.0HP CEILING CASSETTE, INVERTER TYPE 220V, 1P, 60HZ		2.00	Pcs		
1.06	1.5HP CEILING CASSETTE DOUBLE FLOW, INVERTER TYPE 220V, 1P,		2.00	Pcs		
1.06	1.0HP CEILING CASSETTE DOUBLE FLOW, INVERTER TYPE 220V, 1P,		6.00	Pcs		
SYSTEM 1,FOURTH FLOOR						
1.04	16.0HP, OUTDOOR UNIT, VRV/VRF 400V/380V, 3P, 60HZ, INVERTER		2.00	Pc		
1.05	14.0HP, OUTDOOR UNIT, VRV/VRF 400V/380V, 3P, 60HZ, INVERTER		1.00	Pc		
1.05	12.0HP, OUTDOOR UNIT, VRV/VRF 400V/380V, 3P, 60HZ, INVERTER		1.00	Pc		
1.12	3.0HP CEILING CASSETTE, INVERTER TYPE 220V, 1P, 60HZ		1.00	Pcs		
1.06	2.5HP CEILING DUCTED, INVERTER TYPE 220V, 1P, 60HZ		10.00	Pcs		
SYSTEM 2,FOURTH FLOOR						
1.04	18.0HP, OUTDOOR UNIT, VRV/VRF 400V/380V, 3P, 60HZ, INVERTER		2.00	Pc		
1.05	14.0HP, OUTDOOR UNIT, VRV/VRF 400V/380V, 3P, 60HZ, INVERTER		1.00	Pc		
1.12	3.0HP CEILING CASSETTE, INVERTER TYPE 220V, 1P, 60HZ		10.00	Pcs		
1.06	1.0HP CEILING CASSETTE DOUBLE FLOW, INVERTER TYPE 220V, 1P,		2.00	Pcs		
SYSTEM 1,FIFTH FLOOR						
1.04	18.0HP, OUTDOOR UNIT, VRV/VRF 400V/380V, 3P, 60HZ, INVERTER		1.00	Pc		
1.05	14.0HP, OUTDOOR UNIT, VRV/VRF 400V/380V, 3P, 60HZ, INVERTER		1.00	Pc		
1.12	3.0HP CEILING CASSETTE, INVERTER TYPE 220V, 1P, 60HZ		5.00	Pcs		
1.06	2.0HP CEILING CASSETTE DOUBLE FLOW, INVERTER TYPE 220V, 1P,		1.00	Pcs		
1.06	1.5HP CEILING CASSETTE DOUBLE FLOW, INVERTER TYPE 220V, 1P,		2.00	Pcs		
1.06	1.0HP CEILING CASSETTE DOUBLE FLOW, INVERTER TYPE 220V, 1P,		1.00	Pcs		
SYSTEM 2,FIFTH FLOOR						
1.04	12.0HP, OUTDOOR UNIT, VRV/VRF 400V/380V, 3P, 60HZ, INVERTER		3.00	Pc		
1.06	2.5HP CEILING DUCTED, INVERTER TYPE 220V, 1P, 60HZ		10.00	Pcs		
SYSTEM 3,FIFTH FLOOR						
1.04	16.0HP, OUTDOOR UNIT, VRV/VRF 400V/380V, 3P, 60HZ, INVERTER		1.00	Pc		
1.05	14.0HP, OUTDOOR UNIT, VRV/VRF 400V/380V, 3P, 60HZ, INVERTER		1.00	Pc		
1.06	2.0HP CEILING CASSETTE DOUBLE FLOW, INVERTER TYPE 220V, 1P,		10.00	Pcs		
SYSTEM 1,SIXTH FLOOR						
1.04	20.0HP, OUTDOOR UNIT, VRV/VRF 400V/380V, 3P, 60HZ, INVERTER		1.00	Pc		
1.04	18.0HP, OUTDOOR UNIT, VRV/VRF 400V/380V, 3P, 60HZ, INVERTER		2.00	Pc		
1.06	4.0HP CEILING CASSETTE DOUBLE FLOW, INVERTER TYPE 220V, 1P,		3.00	Pcs		
1.12	3.0HP CEILING CASSETTE, INVERTER TYPE 220V, 1P, 60HZ		1.00	Pcs		
1.18	1.0HP WALL MOUNTED, INVERTER TYPE 220V, 1P, 60HZ R32		1.00	Pc		
1.06	2.0HP CEILING CASSETTE DOUBLE FLOW, INVERTER TYPE 220V, 1P,		11.00	Pcs		
SYSTEM 2,SIXTH FLOOR						
1.04	18.0HP, OUTDOOR UNIT, VRV/VRF 400V/380V, 3P, 60HZ, INVERTER		2.00	Pc		
1.04	14.0HP, OUTDOOR UNIT, VRV/VRF 400V/380V, 3P, 60HZ, INVERTER		1.00	Pc		
1.06	10.0HP CEILING DUCTED HIGH STATIC AIR VOLUME, INVERTER TYPE		1.00	Pcs		
1.06	6.0HP CEILING DUCTED, INVERTER TYPE 220V, 1P, 60HZ		1.00	Pcs		



Name of Project : PROPOSED EXPANSION W/ IMPROVEMENT WORKS AT PASIG CITY CHILDREN'S HOSPITAL
Location : INDUSTRIA COR. ALCALDE JOSE STS., KAPASIGAN, PASIG CITY

ESTIMATED COST OF PROPOSED WORK:

ITEM NO.	DESCRIPTION	% WT	QUANTITY	UNIT	UNIT COST	AMOUNT
1.06	3.0HP CEILING CASSETTE DOUBLE FLOW, INVERTER TYPE 220V, 1P,		2.00	Pcs		
1.06	2.0HP CEILING CASSETTE DOUBLE FLOW, INVERTER TYPE 220V, 1P,		6.00	Pcs		
SYSTEM 3,SIXTH FLOOR						
1.04	12.0HP, OUTDOOR UNIT, VRV/VRF 400V/380V, 3P, 60HZ, INVERTER		2.00	Pc		
1.04	10.0HP, OUTDOOR UNIT, VRV/VRF 400V/380V, 3P, 60HZ, INVERTER		1.00	Pc		
1.06	1.5HP CEILING CASSETTE DOUBLE FLOW, INVERTER TYPE 220V, 1P,		1.00	Pcs		
1.06	1.0HP CEILING CASSETTE DOUBLE FLOW, INVERTER TYPE 220V, 1P,		1.00	Pcs		
1.06	2.0HP CEILING CASSETTE DOUBLE FLOW, INVERTER TYPE 220V, 1P,		10.00	Pcs		
SPLIT TYPE AIRCONDITIONING EQUIPMENT						
1.06	4.0HP WALL MOUNTED , INVERTER TYPE 220V, 1P, 60HZ, R32		4.00	sets		
	2.0HP WALL MOUNTED , INVERTER TYPE 220V, 1P, 60HZ, R32		1.00	sets		
1.06	3.0HP CEILING MOUNTED , INVERTER TYPE 220V, 1P, 60HZ, R32		1.00	sets		
1.06	3.0HP CEILING CASSETTE, INVERTER TYPE 220V, 1P, 60HZ, R32		6.00	sets		
1.17	1.5HP WALL MOUNTED, INVERTER TYPE 220V, 1P, 60HZ R32		1.00	set		
1.18	1.0HP WALL MOUNTED, INVERTER TYPE 220V, 1P, 60HZ R32		1.00	sets		
OTHER EQUIPMENTS						
1.19	Refrigerant network for vrv system (indoor and outdoor)		183.00	pcs		
1.20	Remote for VRV/VRF (wired)		183.00	pcs		
Ducting works						
	Removal of deffective ducting, machine connection ,grills and other		426.00	/sq.m		
	Reducing for the deffective ducting and new Ducting works for new		468.00	/sq.m		
		13.91%				
19.2.1.2 REFRIGERANT WORKS						
Refrigerant Copper Tubing, Hard Drawn, Type L						
2.01	1 5/8" Ø		155.00	lm		
2.02	1 3/8" Ø		290.00	lm		
2.04	1 1/8" Ø		225.00	lm		
2.07	7/8" Ø		210.00	lm		
2.08	3/4" Ø		350.00	lm		
2.09	1/2" Ø		680.00	lm		
2.10	5/8" Ø		670.00	lm		
2.11	3/8" Ø		625.00	lm		
2.12	1/4" Ø		477.00	lm		
Refrigerant Copper Fittings (Long radius Elbow 90 °)						
2.10	1 5/8" Ø		39.00	pcs		
2.11	1 3/8" Ø		73.00	pcs		
2.12	1 1/8" Ø		56.00	pcs		
2.13	7/8" Ø		53.00	pcs		
2.14	3/4" Ø		88.00	pcs		
2.15	1/2" Ø		170.00	pcs		
2.16	5/8" Ø		168.00	pcs		
2.17	3/8" Ø		156.00	pcs		
2.18	1/4" Ø		119.00	pcs		
2.19	1 5/8" Ø coupling		1.00	pcs		
2.20	1 3/8" Ø coupling		2.00	pcs		
2.21	1 1/8" Ø coupling		10.00	pcs		
2.22	7/8" Ø coupling		16.00	pcs		
Closed Cell Elastomeric Rubber Insulation with thickness of 1 inch						
2.23	1 5/8" Ø		155.00	lm		
2.24	1 3/8" Ø		290.00	lm		
2.25	1 1/8" Ø		225.00	lm		
2.26	7/8" Ø		210.00	lm		
2.27	3/4" Ø		350.00	lm		
2.28	1/2" Ø		680.00	lm		
2.29	5/8" Ø		670.00	lm		
2.30	3/8" Ø		625.00	lm		
2.31	1/4" Ø		477.00	lm		
2.32	Polythelene Tape (white)		80.00	rolls		
Condensate Drain System						
2.33	50mm Ø, PVC S-Blue		20.00	lgt/10f		
2.34	40mm Ø, PVC S-Blue		40.00	lgt/10f		
2.35	32mm Ø, PVC S-Blue		100.00	lgt/10f		



Name of Project : PROPOSED EXPANSION W/ IMPROVEMENT WORKS AT PASIG CITY CHILDREN'S HOSPITAL
Location : INDUSTRIA COR. ALCALDE JOSE STS., KAPASIGAN, PASIG CITY

ESTIMATED COST OF PROPOSED WORK:

ITEM NO.	DESCRIPTION	% WT	QUANTITY	UNIT	UNIT COST	AMOUNT
2.35	25mm Ø, PVC S-Blue		60.00	lgt/10f		
2.36	50mm Ø, rubber insulation		34.00	pcs		
2.37	40mm Ø, rubber insulation		67.00	pcs		
2.38	32mm Ø, rubber insulation		34.00	pcs		
2.38	25mm Ø, rubber insulation		100.00	pcs		
2.39	Polythelene Tape (blue)		30.00	rolls		
Hangers and Support Sytem						
2.40	Fullthreaded 3/8"		100.00	pcs		
2.41	Dynabolt 3/8"		56.00	pcs		
2.42	Metal clamp 4"		60.00	pcs		
2.43	Loop hanger (refrigerant and drain) 2"& 1 1/2"		50.00	pcs		
2.44	Spring (indoor)		132.00	pcs		
2.45	Metal clamp 2"		150.00	pcs		
2.46	Bolt and nut 3/8'		100.00	pcs		
2.47	Spring (Outdoor)		48.00	pcs		
2.48	Concrete flatom (4" thickness) vrv/vrf outdoor with rubber pad		41.00	sets		
Miscellaneous / Consumables						
2.46	Mapp gas		100.00	tank		
2.47	Silver Rod		500.00	pcs		
2.48	Oxy-Acetylene tank		10.00	pcs		
2.49	Charging Freon, R410a		192.00	kls		
2.50	Charging Freon, R32		10.00	kls		
2.51	Nitrogen		10.00	tank		
2.52	Other accessories		1.00	lot		
		1.34%				
19.2.1.3 ELECTRICAL WORKS OF AIRCON UNITS						
3.01	100AT,3P,220V IN NEMA 3R		9.00	pcs		
3.02	75AT , 3P , 220V IN NEMA 3R		28.00	pcs		
3.03	40AT , 2P , 220V IN NEMA 3R		4.00	pcs		
3.04	30AT , 2P , 220V IN NEMA 3R		10.00	pcs		
3.05	15AT , 2P , 220V IN NEMA 1		183.00	pcs		
3.06	lmc pipe 3/4"dia.		14.00	pcs		
3.07	lmc pipe 1/2"dia.		1,110.00	pcs		
3.08	Liquid tight 1 1/2" with connector and adapter		120.00	mtr		
3.09	Liquid tight 1 1/2" elbow		14.00	pcs		
3.10	Liquid tight 1" with connector and adapter		300.00	mtr		
3.11	Liquid tight 1 " elbow		20.00	pcs		
3.12	Metal Flexible Conduit 1/2 with mica tube		25.00	mtrs		
3.13	Metal Flexible Connector 3/4 with mica tube		25.00	mtrs		
3.14	Royal Cord 1.25 mm, 2C PHILFLEX (Transmission)		1,929.00	mtrs		
3.15	Royal Cord 0.75 mm, 2C PHILFLEX (Control Wire)		2,196.00	mtrs		
3.16	THHN Wire #12 (SUPPLY)		1,300.00	mtrs		
3.17	THHN Wire #10 (SUPPLY)		120.00	mtrs		
3.18	THHN Wire #8 (SUPPLY)		220.00	mtrs		
3.19	THHN Wire #4 (SUPPLY)		220.00	mtrs		
3.20	THHN Wire #2 (SUPPLY)		160.00	mtrs		
3.21	Square Box 4x4, deep type, G.I. Gauge #16		6.00	pcs		
3.22	Other accessories		1.00	lot		
		0.60%				
19.2.2 AUXILIARY SYSTEM						
19.2.2.1 FDAS(FIRE DETECTION AND ALARM SYSTEM)						
1.01	Firealarm control panel addressable UL listed,system update and		1.00	unit		
1.02	Smoke Detector(optical) with base addressable, UL listed		166.00	pcs		
1.03	Heat Detector with base addressable, UL listed		19.00	pcs		
1.04	Fire alarm strobe(red) and horn(sounder) 12/24V UL listed, addressable		12.00	pcs		
1.05	Manual Call point, indoor red, with hinge cover and bezel addressable		12.00	pcs		
1.06	# 16 TF wire, 2C (black and red)		15,725.00	mtrs		
1.07	Spare glass		6.00	pcs		
1.08	Interface module notific, app,surface		6.00	pcs		
1.09	Power supply ,8A, 12/24V		12.00	set		
1.10	12V, 7 Ah battery		12.00	pcs		



Name of Project : PROPOSED EXPANSION W/ IMPROVEMENT WORKS AT PASIG CITY CHILDREN'S HOSPITAL
Location : INDUSTRIA COR. ALCALDE JOSE STS., KAPASIGAN, PASIG CITY

ESTIMATED COST OF PROPOSED WORK:

ITEM NO.	DESCRIPTION	% WT	QUANTITY	UNIT	UNIT COST	AMOUNT
1.11	Junction Box, deep type, G.I. Gauge #16		185.00	pcs		
1.12	Utility Box, deep type, G.I. Gauge #16		24.00	pcs		
1.13	Square Box 4x4, deep type, G.I. Gauge #16		12.00	pcs		
1.14	lmc pipe 1/2"dia.		5,242.00	lgt		
1.16	Support and hangering such as clamps, gi wires , concrete nails,.etc.		10,485.00	sets		
		2.41%				
19.2.2.2 CCTV(CLOSED CIRCUIT TELEVISION) SYSTEM						
2.01	40"- 43" Led Monitor (CCTV Monitoring Screen), 4K Resolution, with mounting bracket and other support		6.00	units		
2.02	Desktop Computer Set - (Intel Core 7 10th Generation, 16GB expandable up to 32GB, up to 2TB M.2 PCIe NVME SSD + 2TB HDD, 8GB OC DDR5X Video Card, with 144HZ 24" Led Monitor, keyboard, up 800 Watts Power Supply Unit (PSU), up to 1500 VA Uninterrupted Power Supply (UPS), with Licensed Windows 10 System and Microsoft Office Application.)		1.00	set		
2.03	Network Video Recorder (NVR) -32 Channel Compact up to 32Tb, supports up to SMP cameras, 1U HDD Network video recorder, 240fps @ 1080P, VGA/HDMI simultaneous video output , maximum resolution of HDMI is 4K, support camera using a POE(power over Ethernet), support remote configuration and management of IPC.		4.00	set		
2.04	Boxes of mounting camera (octagonal junction box with cover)		21.00	pcs		
2.05	4-Megapixel CCTV Camera 1/1.8" CMOS image sensor, built in IR LED , 2.8/4/6 mm fixed lens distance : 30m , 12V DC/PoE power support , IP67 protection. Support h.265+ /h.265 /h.264+ h.264, upto 30fps		110.00	units		
2.06	4-Terabyte Hard Disk Drive		4.00	units		
2.07	CCTV cable cabinet/rack		1.00	set		
2.08	Cat 6 cable wire		5,959.00	mtrs		
	rj45 and rubber boots		220.00	pcs		
2.09	HDMI Splitter (monitors), 4-6 ports		1.00	pcs		
2.10	HDMI cable, 4 ports		12.00	mtrs		
2.11	lmc pipe 2"diameter		6.00	lgt		
2.12	lmc pipe 1"diameter		12.00	lgt		
2.14	lmc pipe 1/2"diameter		1,990.00	lgt		
2.15	Others (accessories , hangers, tagging/ panning of camera and support including c-clamp and velcro, tv mounting plate, 24 PORTS POE, wire mesh/cable tray)		6.00	sets		
		1.15%				
19.2.2.3 PUBLIC ADDRESS AND BACKGROUND MUSIC SYSTEM						
3.01	Ceiling Mounted speaker (6W)		232.00	units		
3.02	Power Amplifier 240watts(pre amplifier)		12.00	sets		
3.03	# 16 TF wire, 2C (black and red)/speaker wire		19,720.00	mtrs		
3.04	lmc pipe 1/2"dia.		6,574.00	lgt		
3.05	Usb Desktop Microphone with mute button, plug & play		11.00	set		
3.06	Tuner		1.00	set		
3.07	DVD player with usb		1.00	set		
3.08	Support and hangering such as clamps, gi wires, full		4,382.00	lot		
		2.54%				
19.2.2.4 BMS(BUILDING MANAGEMENT SYSTEM)						
4.01	Rehabilitation, programming and calibration, including additional accessories, replacement of defective sensors, equipments.		1.00	unit		
		0.25%				



Name of Project : **PROPOSED EXPANSION W/ IMPROVEMENT WORKS AT PASIG CITY CHILDREN'S HOSPITAL**
Location : **INDUSTRIA COR. ALCALDE JOSE STS., KAPASIGAN, PASIG CITY**

ESTIMATED COST OF PROPOSED WORK:

ITEM NO.	DESCRIPTION	% WT	QUANTITY	UNIT	UNIT COST	AMOUNT
20.0	ELECTRIC MOTOR PUMPS AND FIRE PROTECTION SYSTEM					
	Additional Fire Protection System at Extension (Lower Roof Deck)		1.00	ls		
	P -TP1 " BERKELEY " (USA) B Sseries Close-coupled End-suction Centrifugal Pump Model B1-1/2TPMS, size 1-1/2 x 2 x 6M Features Cast iron construction with unique back pull-out design permits access to the impeller without disturbing the piping; high -quality and self-lubricating mechanical shaft seal; close-coupled with a NEMA standard ODP motor HP: 10, Pipe Tapping Size (suction x Discharge): 2" x 1- 1/2" Motor Voltage: 230/460Volts, Rated Speed: 3450RPM, Phase/Hz: Three(3)/60Hz Rated to deliver: 180 GPM against 150ft. TDH		4.00	pcs		
	P-BP 1 " AERMOTOR " (USA) UL Listed CT35 Series Centrifugal Pump Motor CT35-3-100 Features: Closed-Grained Cast Iron Body and Sealed Plate; Steel 10 Gauge Base;416 Stainless Steel Shaft; Carbon/Ceramic, Buna-N Mechanical Seal; Abrasion-Resistant Noryl Impeller; coupled with an A.O Smith Electric Motor; Replaceable Wear Ring HP:1 0, Pipe Tapping Size (suction x Discharge): 1-1/4" x 1" Motor Voltage: 230/460Volts, Phase/Hz: Three(3)/60Hz, Max Load Amps: 3.6/1.8A Rated to deliver: 30GPM againts 80ft. TDH.		3.00	pcs		
	CPS Triplex Controls Triplex Controller for Pump " AERMOTOR " (USA) UL Listed CT35 Series Centrifugal Pump, Model CT35-3-100		1.00	pc.		
	P-BP2 " AERMOTOR " (USA) UL Listed CT35 Series Cenrifugal Pump Model CT35-3-200 features. Closed-Grained Cast Iron Body and Sealed Plate; Steel 10 Gauge Base;416 Stainless Steel Shaft; Carbon/Ceramic, Buna-N Mechanical Seal; Abrasion-Resistant Noryl Impeller; coupled with an A.O Smith Electric Motor; Replaceable Wear Ring HP: 2, Pipe Tapping Size (suction x Discharge): 1-1/2" x 1-1/4" Motor Voltage: 230/460Volts, Phase/Hz: Three(3)/60Hz, Max Load Amps: 6.8/3.4A Rated to deliver: 40GPM against 100ft.TDH		3.00	pcs		
	CPS triplex Controls Triplex Controller for Pump " AEROMOTOR " (USA) UL Listed CT35 Series Model CT35-3-200		1.00	pc.		
	P-BP 3" AERMOTOR " (USA) Ul Listed CT35 Series Centrifugal Pump Model CT35-3-200 Features: Close-Grained Cast Iron Body and Seal 10 Gauge Base; 416 Stainless Steel Shaft; Carbon/Ceramic,		3.00	pcs		



Name of Project : **PROPOSED EXPANSION W/ IMPROVEMENT WORKS AT PASIG CITY CHILDREN'S HOSPITAL**
 Location : **INDUSTRIA COR. ALCALDE JOSE STS., KAPASIGAN, PASIG CITY**

ESTIMATED COST OF PROPOSED WORK:

ITEM NO.	DESCRIPTION	% WT	QUANTITY	UNIT	UNIT COST	AMOUNT
	Buna-N Mechanical Seal; Abraison-Resistant Noryl Impeller; coupled with an A.O Smith Electric Motor; Replaceable Wear Ring HP: 2, Pipe Tapping Size (Suction x Discharge): 1-1/2" x 1-1/4" Motor Voltage: 230/460Volts, Phase/Hz: Three(3)/60Hz, Max Load Amps: 6.8/3.4A Rated to deliver: 40GPM against 100ft. TDH					
	CPS Triplex Control Triplex Controller for Pump for AERMOTOR CT35-3-200		1.00	pc.		
	NP-BP 1 " AERMOTOR " (USA) UL Listed CT35 Series Centrifugal Pump Model CT35-3-150		3.00	pcs		
	Features: Close -Grained Cast Iron Body and Seal Plate; Steel 10Gauge Base;416 Stainless Steel Shaft; Carbon/Ceramic, Buna-N Mechanical Seal; Abraison-Resistant Noryl Impeller; couple with an A.O Smith Electric Motor; Replaceable Wear Ring HP: 1-1/2, Pipe Tapping Size (Suction x Discharge): 1-1/4" x 1" Motor Voltage: 230/460Volts, Phase/Hz: Three(3)/60Hz, Max Load Amps: 4.7/2.35A Rated to deliver: 40GPM against 90ft.TDH					
	CPS Triplex Control Triplex Controller for Pump " AERMOTOR " (USA) UL Listed CT35 Series Centrifugal Pump Model SPCH-3-150		1.00	pc.		
	NP-BP 2 " AERMOTOR " (USA) SPCH Series Self-Priming Centrifugal Pump Model SPCH-3-300 Features Close-Grained cast iron body and base; bronze impeller;cast iron diffuser;carbon steel shaft inside removable shaft sleeve of stainless steel; leak-proof mechanical seal; close-coupled with an A.O Smith motor HP:3, Pipe Tapping Size (Suction xDischarge): 2" x 1-1/2" Motor Voltage: 230/460Volts, Phase/Hz: Three(3)/60Hz, Max Load Amps: 8.6/4.3A Rated to deliver: 80GPM against 100ft. TDH		3.00	pcs		
	CPS triplex Controls Triplex Controller for "AERMOTOR" (USA) SPCH Series Self-Priming Centrifugal Pump Model SPCH-3-300		1.00	pc.		
	Np-Bp 3 " AERMOTOR " (USA) SPCH Series Self -Priming Centrifugal Pump Model SPCH-3-300		3.00	pcs		



Name of Project : PROPOSED EXPANSION W/ IMPROVEMENT WORKS AT PASIG CITY CHILDREN'S HOSPITAL
Location : INDUSTRIA COR. ALCALDE JOSE STS., KAPASIGAN, PASIG CITY

ESTIMATED COST OF PROPOSED WORK:

ITEM NO.	DESCRIPTION	% WT	QUANTITY	UNIT	UNIT COST	AMOUNT
	Features:					
	Close-Grained cast iron body and base;					
	bronze impeller; cast iron diffuser;					
	carbon steel shaft inside removable					
	leak-proof mechanical seal;					
	close-coupled with an A.O Smith motor					
	shaft sleeve of stainless steel,					
	HP:3, Pipe Tapping Size (Suction x Discharge): 2" x 1-1/2"					
	Motor Voltage: 230/460Volts,					
	Phase/Hz: Three(3)/60Hz, Max Load Amps: 8.6/4.3A					
	Related to deliver: 80Gpm against 100ft. TDH					
	CPS triplex Controls		1.00	unit		
	Triplex Controller for " AERMOTOR" (USA) SPCH					
	Series Self-Priming Centrifugal Pump					
	Model SPCH-3-300					
	SP 1 & 2		2.00	pcs		
	Duplex Controller for Sump Pump		1.00	unit		
	hydromatic S4S500M4-4 Non-clog					
	pump 5 Hp 230V/460V					
	Hydromatic S4S500M4-4 Non-clog		2.00	pcs		
	Pump 5Hp 230V/460V					
	Duplex Controller for Sump Pump		1.00	unit		
	Hydromatic S4S500M4-4 Non-clog					
	Pump 5Hp 230V/460V					
	Hydromatic S4S500M4-4 Non-clog		2.00	pcs		
	Pump 5 Hp 230V/460V					
	Duplex Controller For Sump Pump		1.00	unit		
	Hydromatic S4S500M4-4 Non-clog					
	Pump 5Hp 230V/460V					
	EP-1 Hydromatic USA Submersible Sanitary Equipment Pump		2.00	units		
	Sewage Ejector Pump					
	Application: Commercial Sewage,					
	Residential Sewage, High-Capacity					
	Sump, Septic Tank Effluent					
	Features: Cast iron construction;					
	Non-clogging cast iron Impeller;					
	Stainless steel shaft; carbon and					
	ceramic-faced mechanical shaft seal;					
	oil-filled motor; Automatic reset thermal					
	over load; water-resistant					
	power cord with molded plug;					
	Bottom-suction design' steel handle					
	Specifications:					
	HP:3/4, Full Load Amps: 9.0, Motor Tpye: split Phase					
	w/ thermal Overload protection					
	RPM:170, Voltage: 230V 60Hz,					
	Capacity: 25 gpm @ 29ft; 50gpm					
	@ 26ft; 75 gpm @ 24ft; 100gpm					
	Solid Handling: 2" Spherical solid and lint,					
	Temperature: 140° F Ambient					
	Operation: Intermittent,					
	NEMA Design: A, Discharge: 2" NPT					
	power cord: 20', 16/3 STWA					



Name of Project : PROPOSED EXPANSION W/ IMPROVEMENT WORKS AT PASIG CITY CHILDREN'S HOSPITAL
Location : INDUSTRIA COR. ALCALDE JOSE STS., KAPASIGAN, PASIG CITY

ESTIMATED COST OF PROPOSED WORK:

ITEM NO.	DESCRIPTION	% WT	QUANTITY	UNIT	UNIT COST	AMOUNT
	TP From STP to NP "AERMOTOR" (USA) UL		2.00	Units		
	Listed CT35 Series Centrifugal Pump					
	Model CT35-3-200					
	Duplex Controller for transfer 2hp, 3phase 60hz		1.00	unit		
	Duplex Controller Panel Submersible Pump		1.00	unit		
	Installation Cost					
		2.97%				

100.00%